




- K LINE OF FOUNDATION WALL BEYOND
- SIMULATED STONE VENEER CULTURED STONE "COUNTRY LEDGESTONE" BUCKS COUNTY

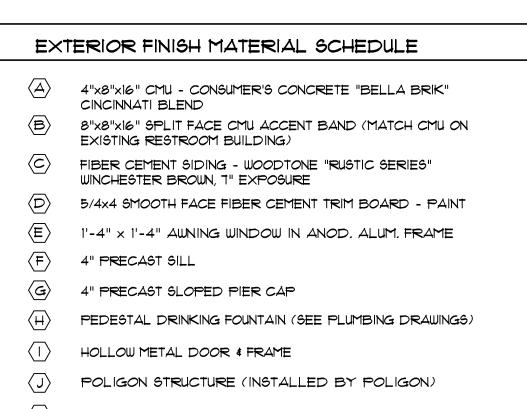


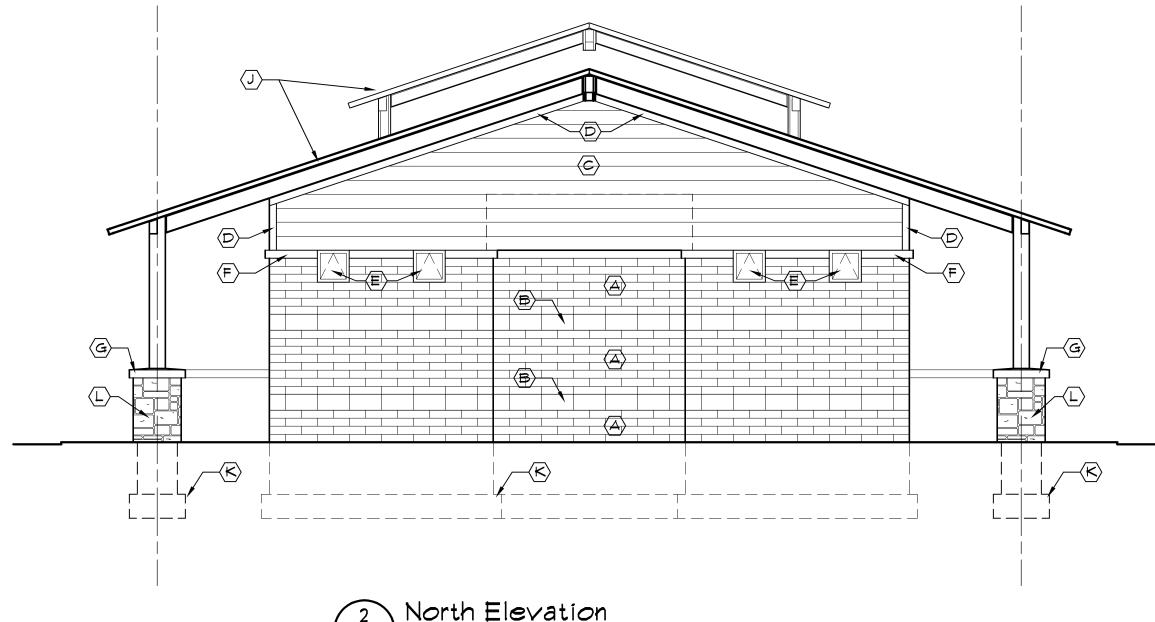

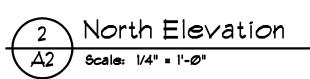

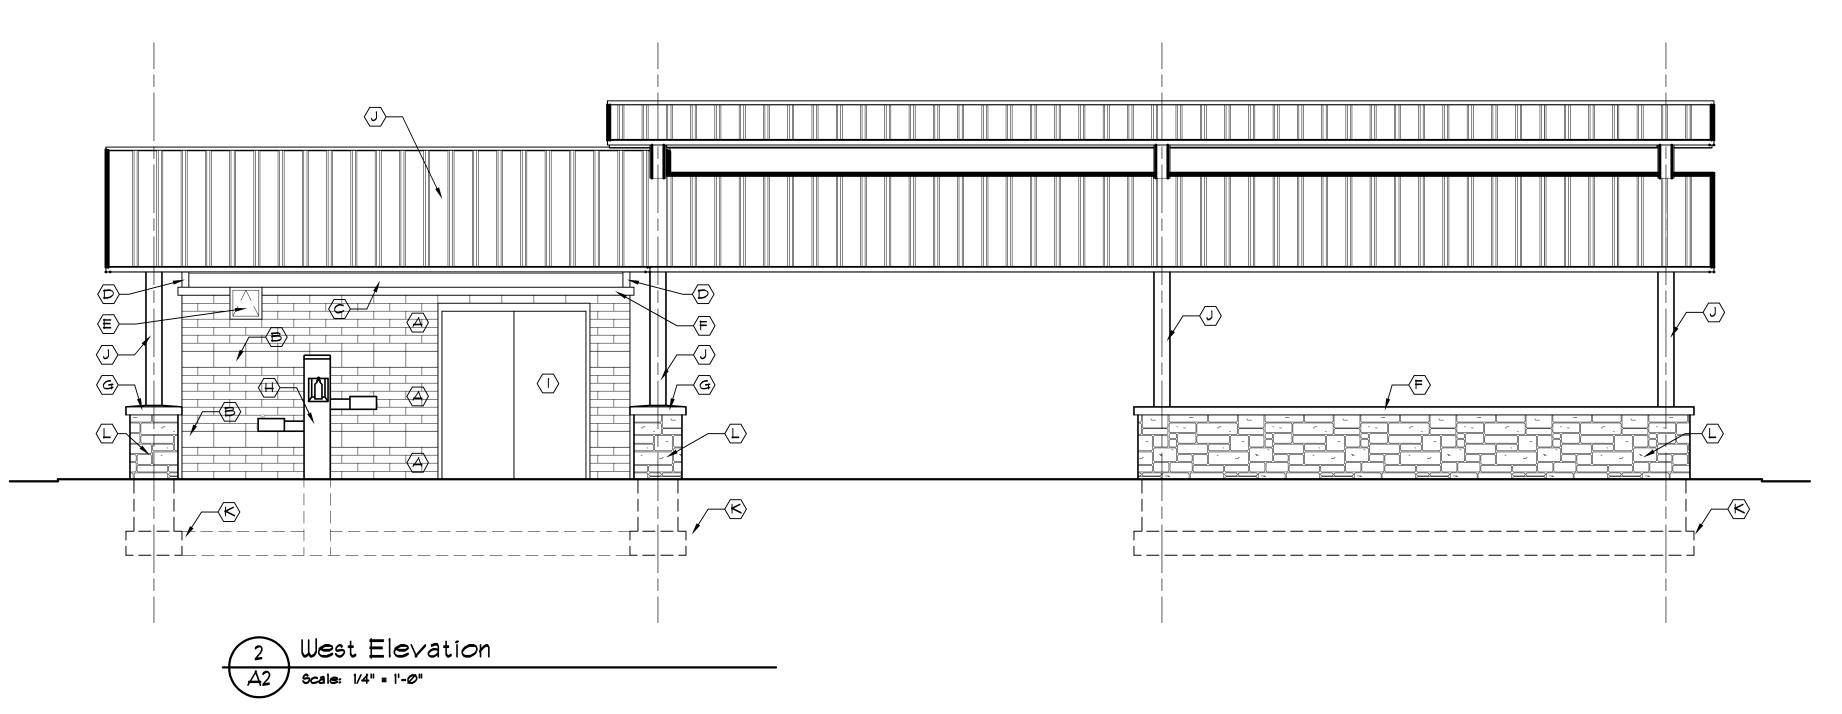

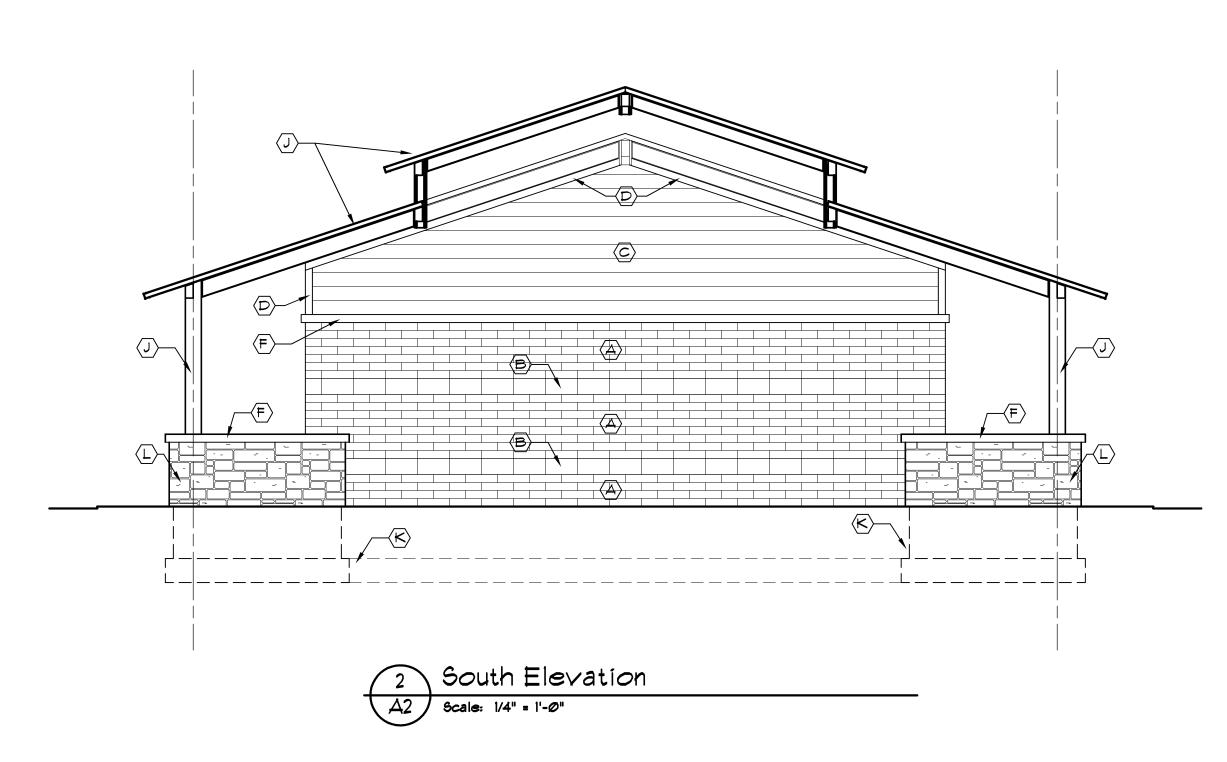

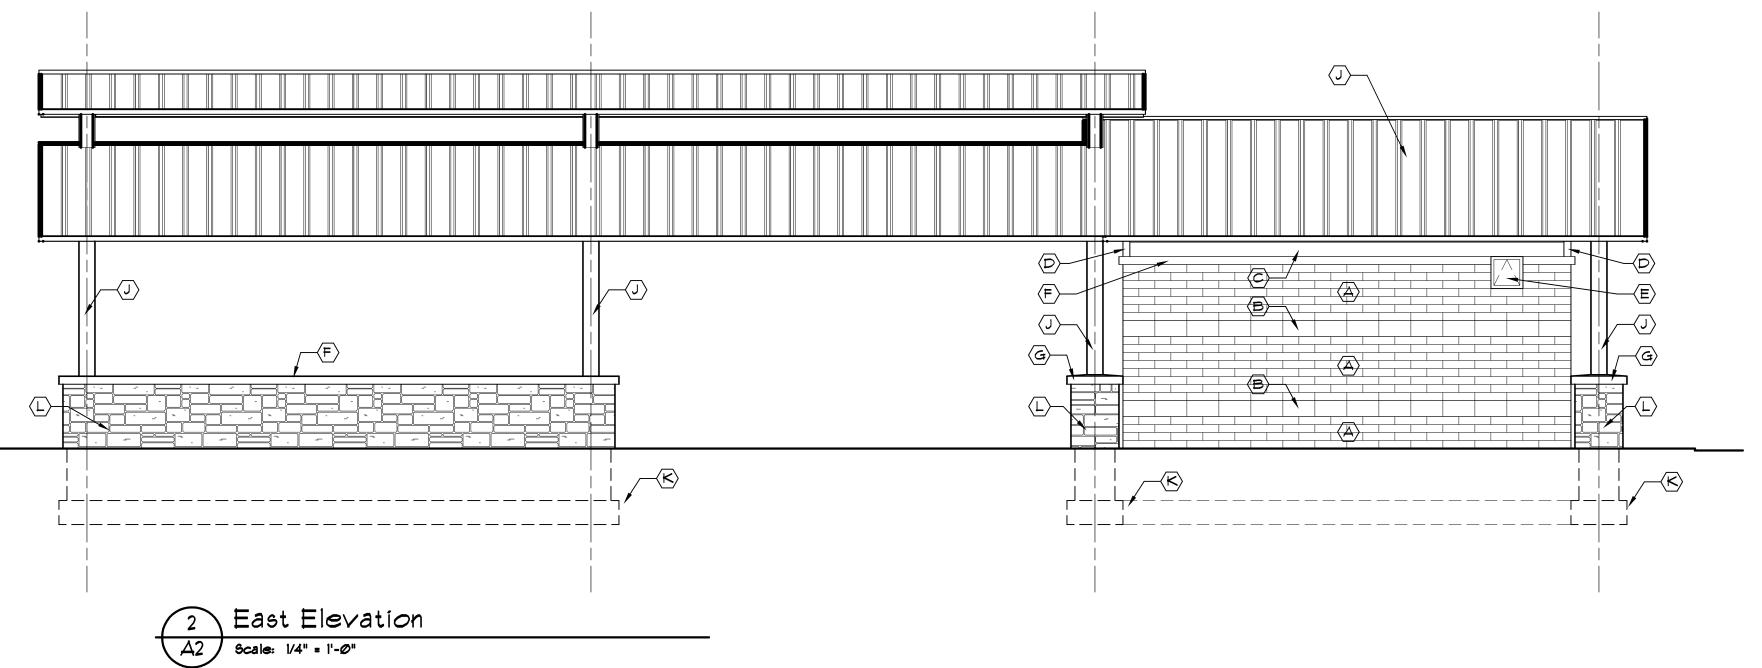

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5-9-17 Prelim. Review

5-16-17 Prelim. Review

6-7-17 City Review

6-19-17 Bids

checked podge Park Improvements
Sterling Heights, Michigan
Sterling Heights, Michigan
Building Elevations





Southfield, Michigan 48076 (248) 557-1062 Fax: (248) 557-1231 job no. sheet no.

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POLIGON STRUCTURE -(INSTALLED BY POLIGON) 4" PRECAST SLOPED PIER CAP-SIMULATED STONE VENEER - -CULTURED STONE "COUNTRY LEDGESTONE" BUCKS COUNTY 6" CONC. BLOCK COLUMN -SURROUND - GROUT SOLID ALL ` BLOCK BELOW GRADE 4" CONCRETE SLAB ON 4" -----COMP. GRANULAR BASE (TYP.) \*3 BARS, 16" LONG @ 32" O.C. IN -GROUT FILLED CORES 20" x 20" WIDE POURED CONC. PIER W/ 2-#5 T&B 28"x28"x12" POURED CONC. — SPREAD FOOTING W/ 2-#5 AT BTM. (TYP.)

Simulated Stone Pier Section



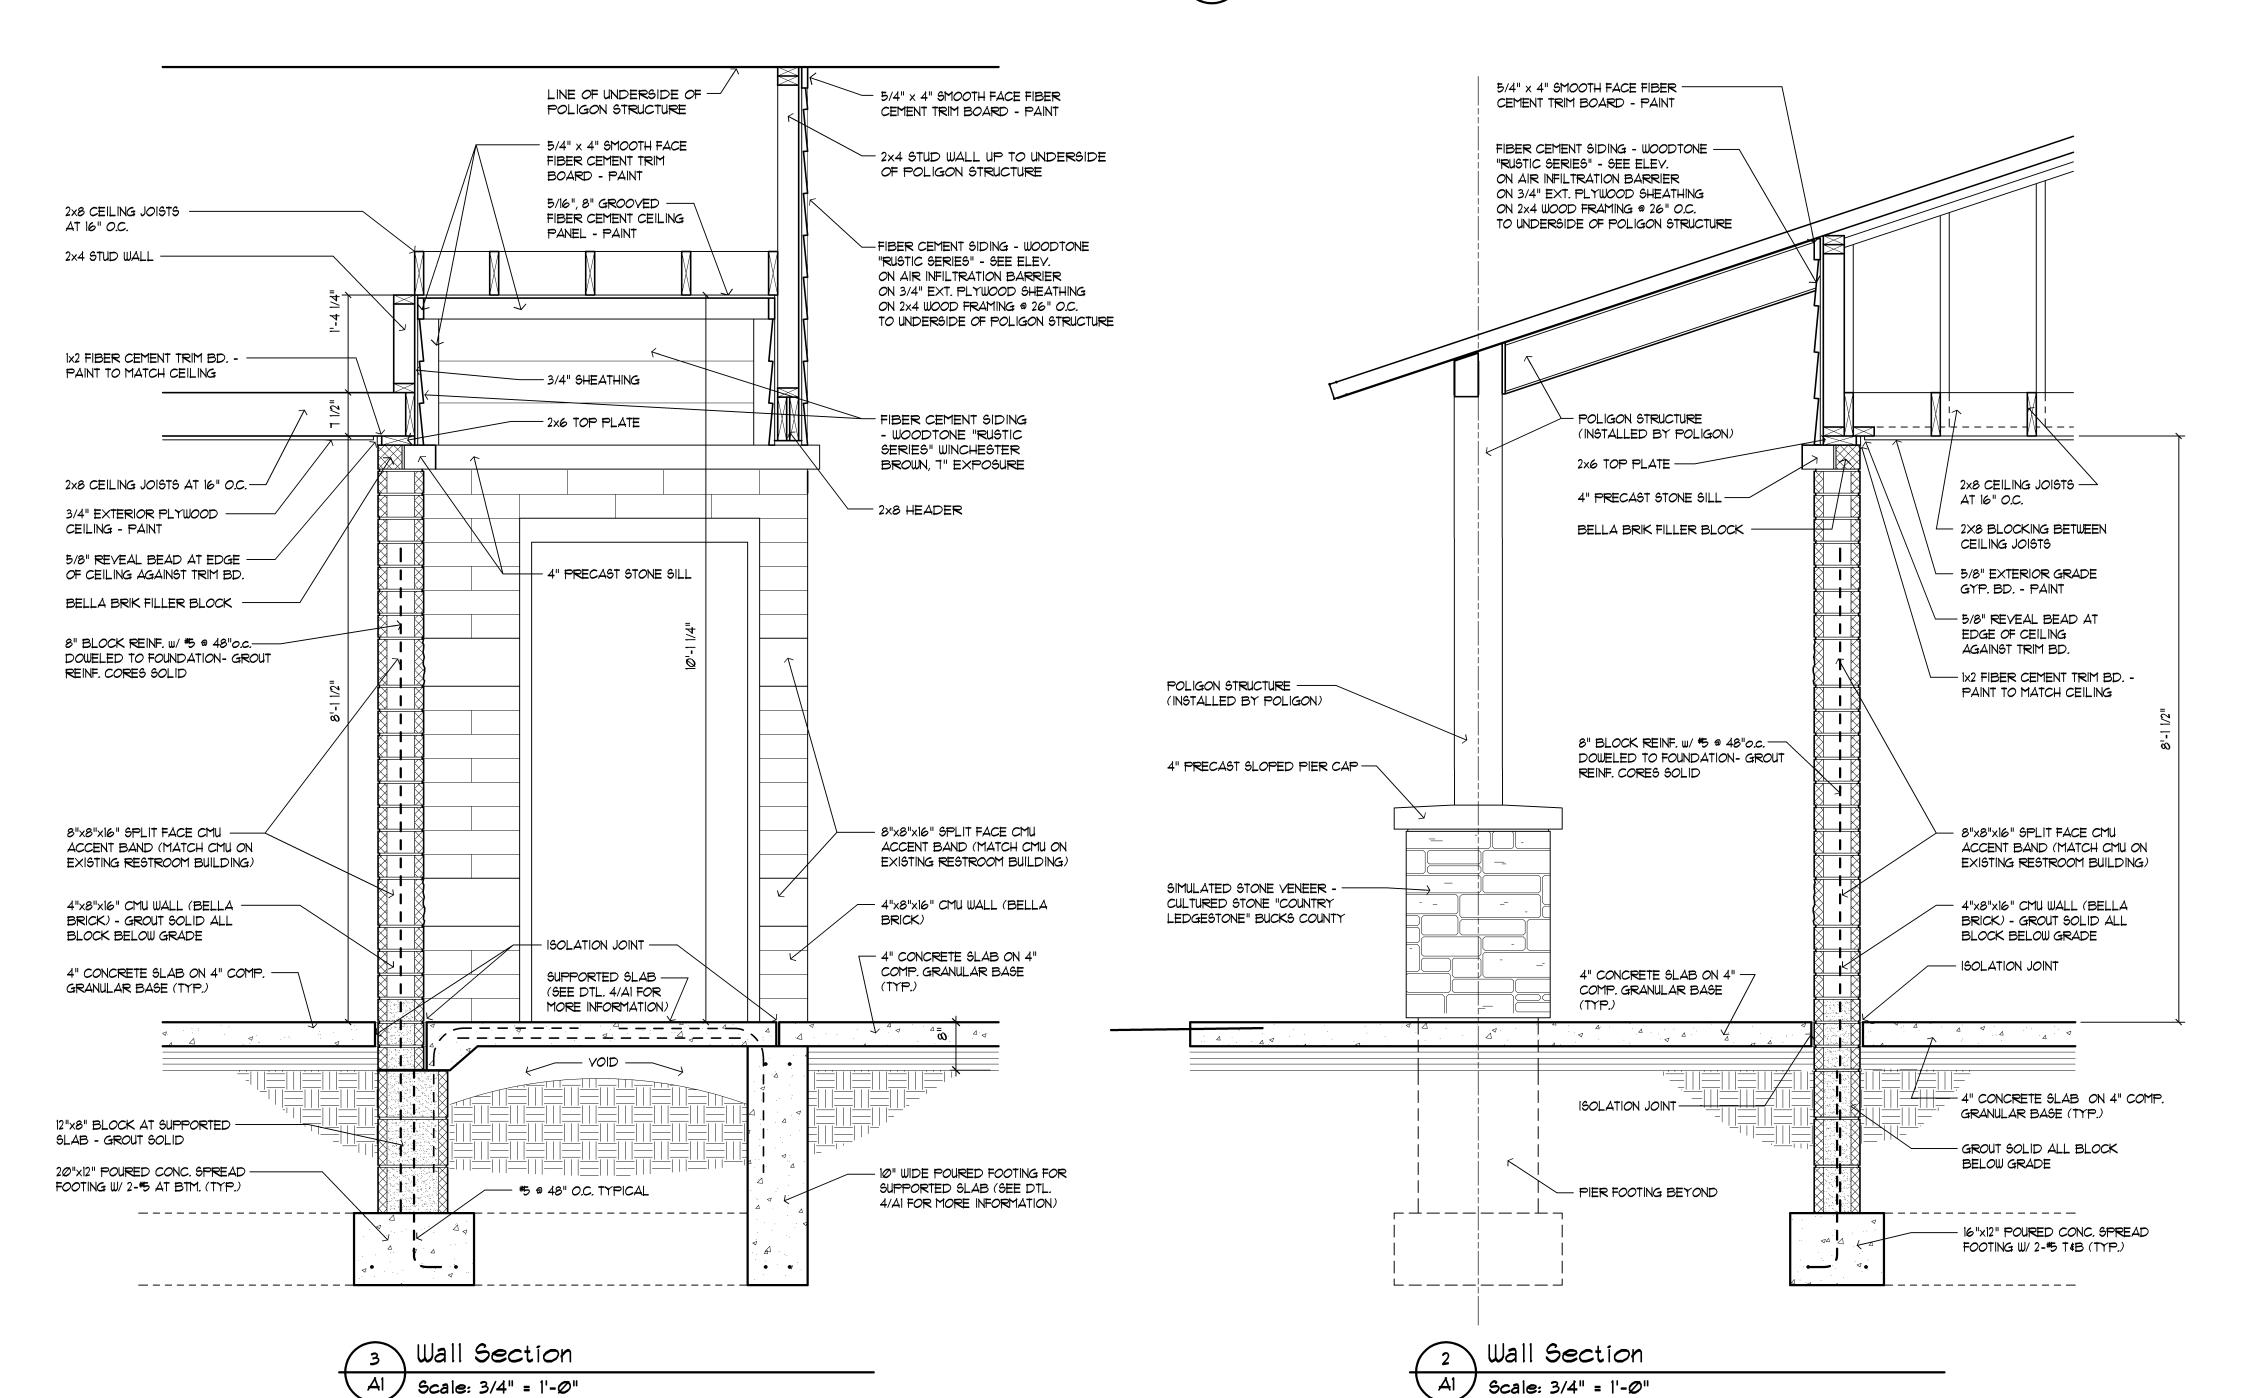

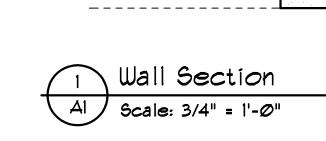AT 16" O.C.

ISOLATION JOINT —

BELOW GRADE

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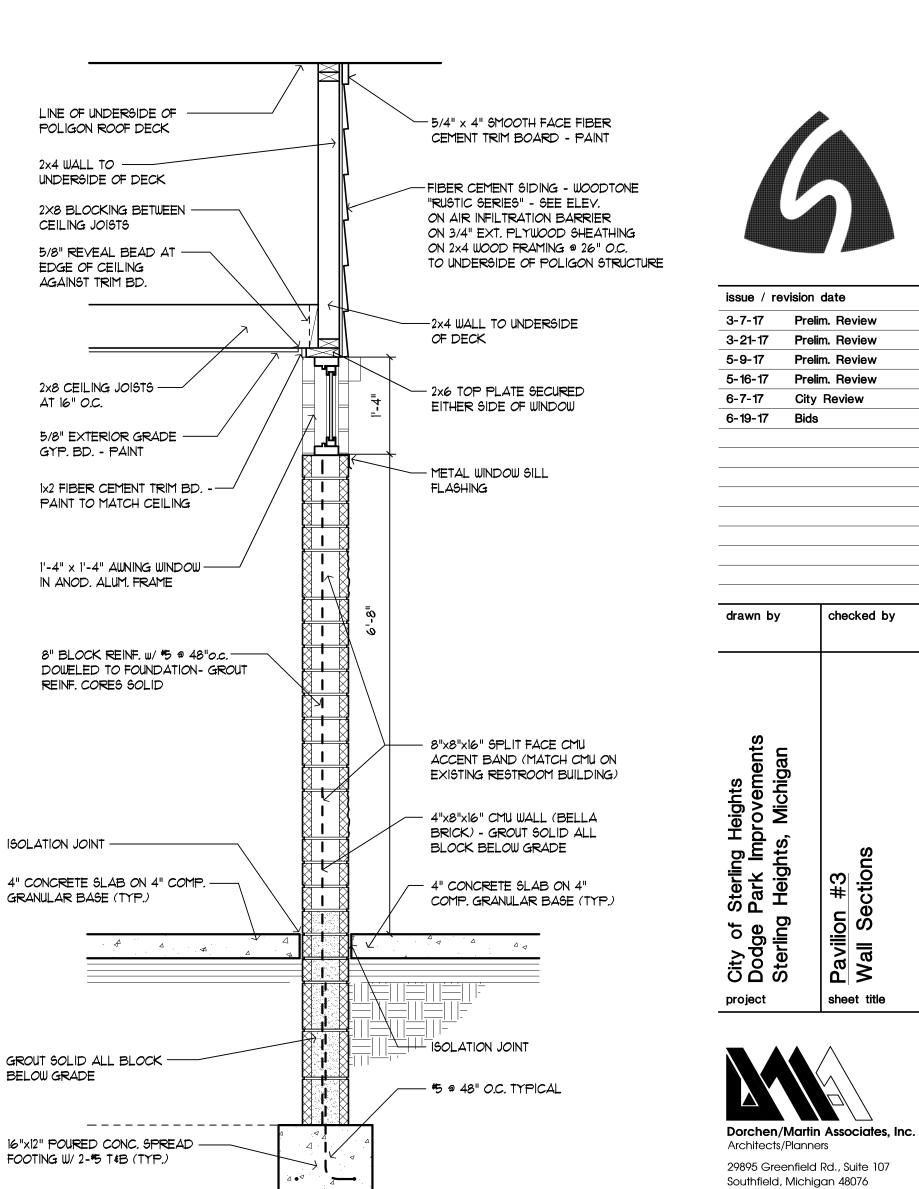
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	DOOR SCHEDULE														
DOOR	DOOR SIZE DOOR HDWR. FRAME DETAILS LABEL CODED														
NO.	DOOK 512L	TYPE	MAT'L.	FINISH	SET	TYPE	MAT'L.	FINISH	SILL	JAMB	HEAD	LADEL	REMARKS		
1Ø1	3'-@"x1'-@"x1-3/4"	В	H.M.	PAINT	ØI	<b>=</b> 1	HM.	PAINT	404	4Ø3	-	-	1, 5, 9, 10, 12, 13, 14		
1Ø2	3'-@"xT'-@"x1-3/4"	B	H.M.	PAINT	Ø1	<del>F</del> 1	HM.	PAINT	404	4Ø3	-	-	1, 5, 9, 10, 12, 13, 14		
1Ø3	(2) 3'-Ø"x1'-Ø"x1-3/4"	Д	H.M.	PAINT	<b>Ø</b> 2	<b>F</b> 2	HM.	PAINT	404	4Ø3	-	-	1, 5, 9, 14		

### ROOM FINISH SCHEDULE ROOM ROOM FLOOR BASE CEILING WALLS REMARKS NO. NAME HGT. FINISH GYP. BD. C.T. - 6 \$ 7 | C.T. - 6 MAS. MEN'S RESTROOM 8'-0" PT. - 4 MAS. MAS. SEE CT TILE PATTERN TYPICAL WOMEN'S RESTROOM C.T. - 6 \$ 7 | C.T. - 6 GYP. BD. 8'-Ø" | PT. - 4 MAS. MAS. MAS. MAS. SEE CT TILE PATTERN TYPICAL 103 MAINTENANCE/UTILITY CONC. EXPOSED PT. - 4 MAS. MAS. MAS. MAS.

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# ABBREVIATIONS

AL/GL. = ALUMINUM & GLASS ALUM. = ALUMINUM

CANOD. = CLEAR ANODIZED

= BI-FOLD = HOLLOW METAL

= HOLLOW METAL KNOCK DOWN

= GLASS MANF. = BY MANUFACTURER = OVERHEAD DOOR

= PRE-FIN. METAL KNOCK DOWN FRAME

= PLASTIC LAMINATE PRE-FIN. = PRE-FINISHED

STL. = STAIN & VARNISH (FIELD FINISHED)

= WOOD, SOLID CORE

NO SCALE

# CODED REMARKS

CLOSER

2. SAFETY GLASS VISION LITE SAFETY GLASS SIDE LITE

4. YINYL CARPET TO TILE JOINER

METAL THRESHOLD 6. MARBLE THRESHOLD VINYL REDUCING STRIP

TERRAZZO STRIP 9. GROUT FILLED FRAME

10. LIMIT DOOR TO 90° SWING DOOR TO OPEN 135°

12. PUSH / PULL

13. WALL MOUNTED DOOR STOP

14. WEATHER STRIPPING 15. KICK DOWN DOOR STOP

# GENERAL DOOR & FRAME NOTES

1. ALL DOOR FRAMES ARE TO RECEIVE CONTINUOUS BEAD

OF SEALANT AT PERIMETER - BOTH SIDES.

2. ALL H.M. FRAMES SHALL BE GROUT FILLED.

3. ALL H.M. DOORS TO BE GALVANIZED, PAINTED

# MATERIAL KEY

= ACOUSTIC CEILING TILE

= ACOUSTIC CEILING CANOPY = ALUMINUM & GLASS AL./GL. = CABINETRY

CAB. CONC. = CONCRETE CPT. = CARPET

= CERAMIC TILE C.T.B. = CERAMIC TILE BASE E.C. = EXPOSED CONSTRUCTION

EPNT. = EPOXY PAINT = FABRIC WALL COVERING = GYPSUM BOARD

= MASONRY = PRE-FIN. METAL KNOCK DOWN FRAME

P. LAM. = PLASTIC LAMINATE = PAINT

PRE-FIN. = PRE-FINISHED = RUBBER BASE WD. = STAINED WOOD = VINYL BASE V.B.

= VINYL COMPOSITION TILE = VINYL SHEET FLOORING = YINYL WALL COVERING = WALL PROTECTION

### GENERAL REMARKS

1. FLOOR MATERIAL CHANGES OCCUR AT CENTERLINE OF DOOR.

2. ACCESS PANELS, ELECTRICAL PANELS, HYAC REGISTERS & FIRE EXTINGUISHER CABINETS SHALL BE PRE-FINISHED OR PAINTED TO MATCH ADJACENT WALLS OR CEILINGS.


A CONTINUOUS BEAD OF SEALANT AT ALL PERIMETER EDGES.


3. ALL DOOR & WINDOW FRAMES TO RECEIVE

4. ALL EXPOSED STEEL SHALL BE PAINTED.

5. REFER TO REFLECTED CEILING PLANS AND SECTIONS WHERE CEILING HEIGHT VARIES.

6. ALL GYPSUM BOARD SOFFITS SHALL BE PAINTED.

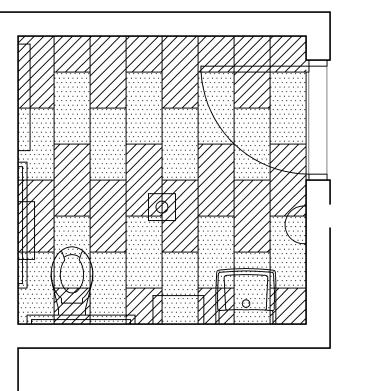


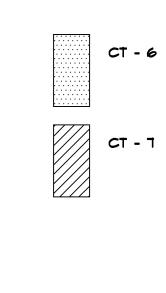


TYPICAL TOILET ROOM CERAMIC TILE PATTERN


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# SEE SEE SCHED. SCHED. (B) LOUVERS (A)DOOR TYPES



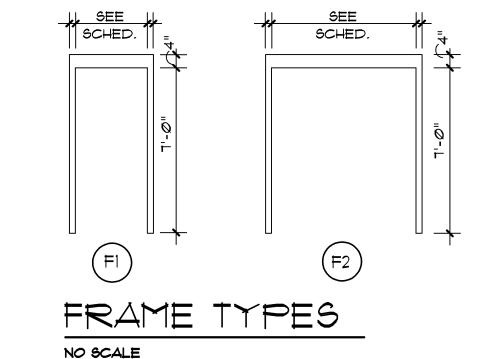





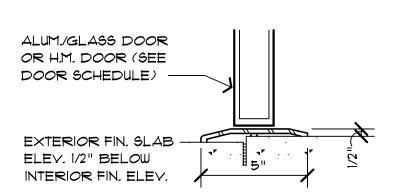


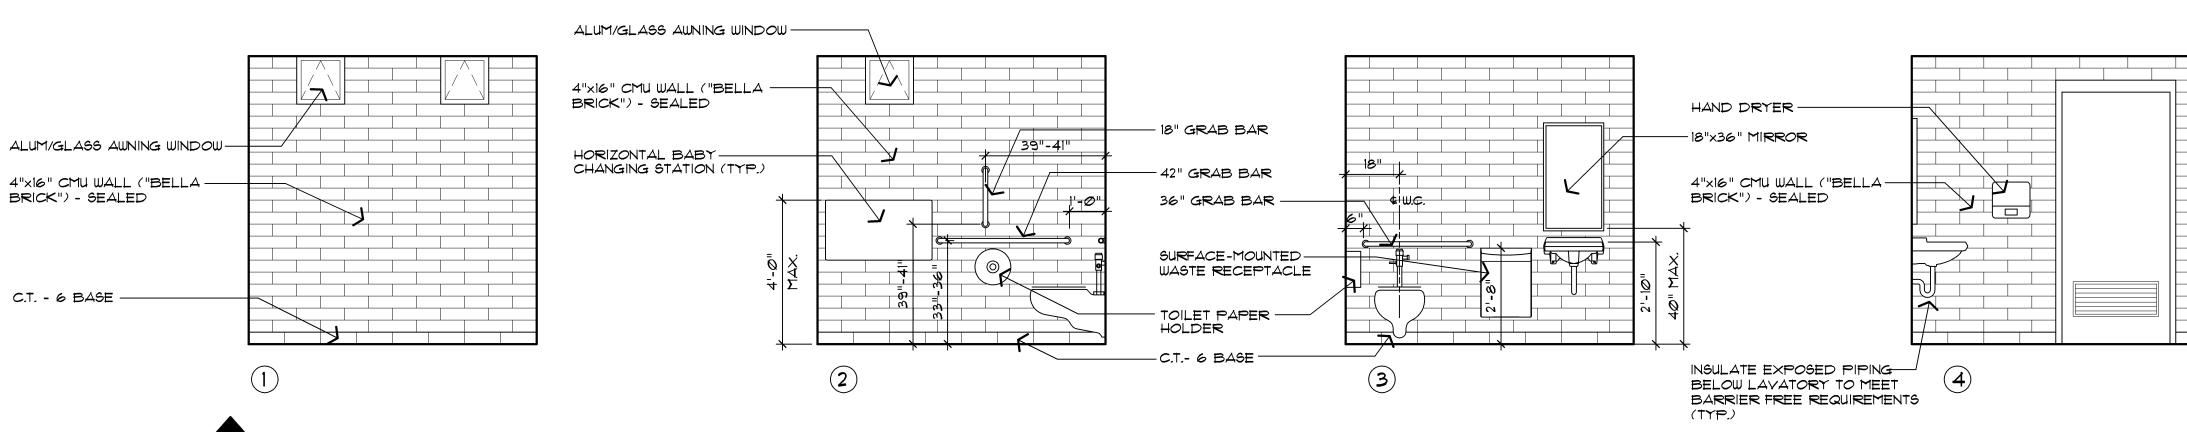




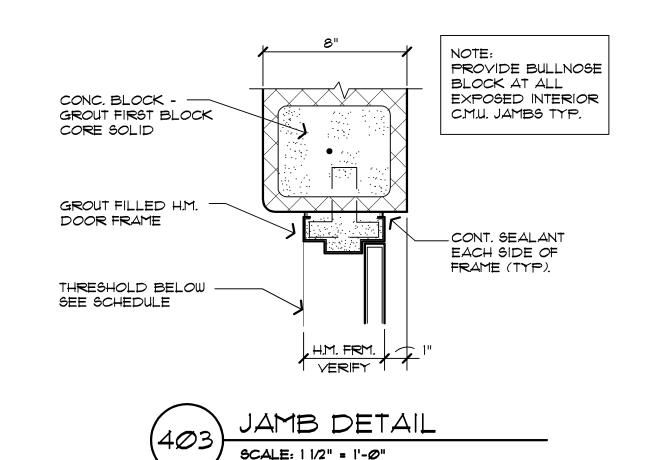

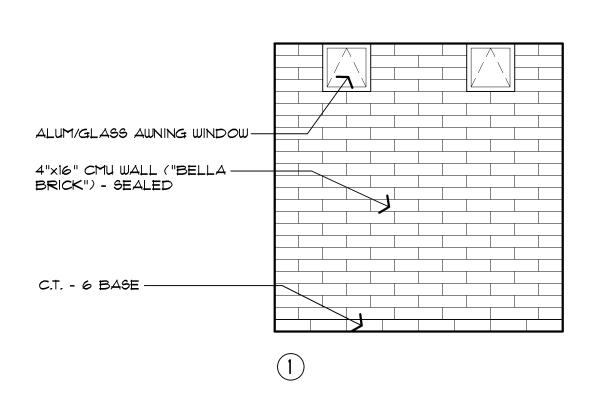

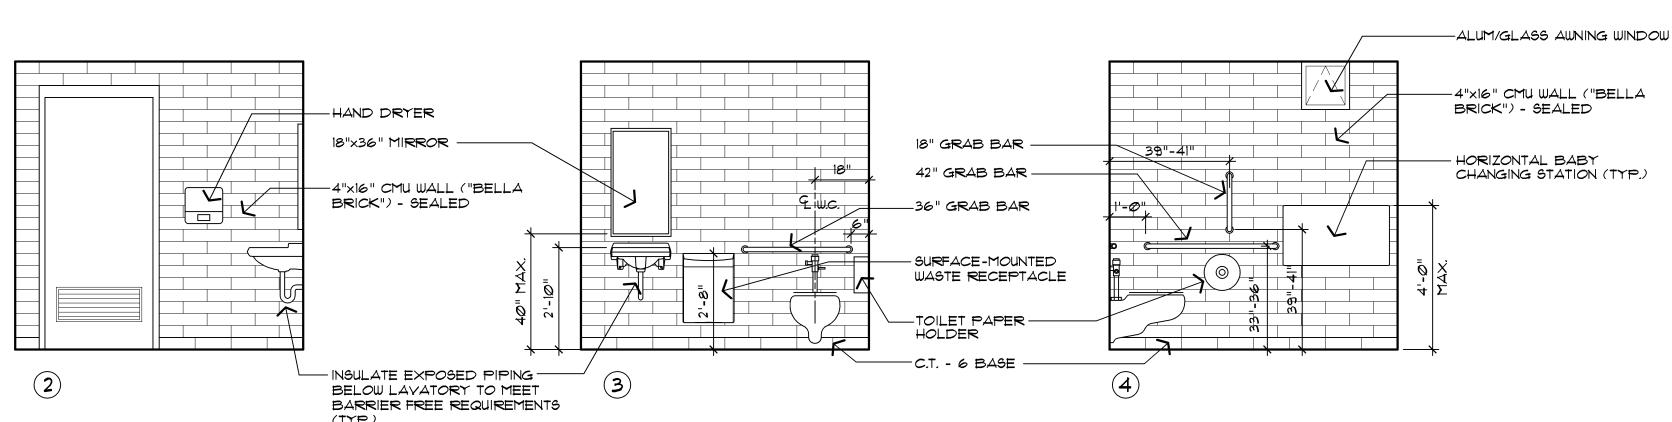



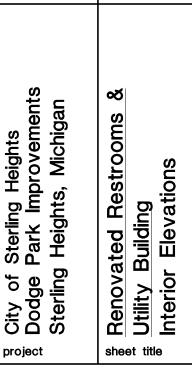

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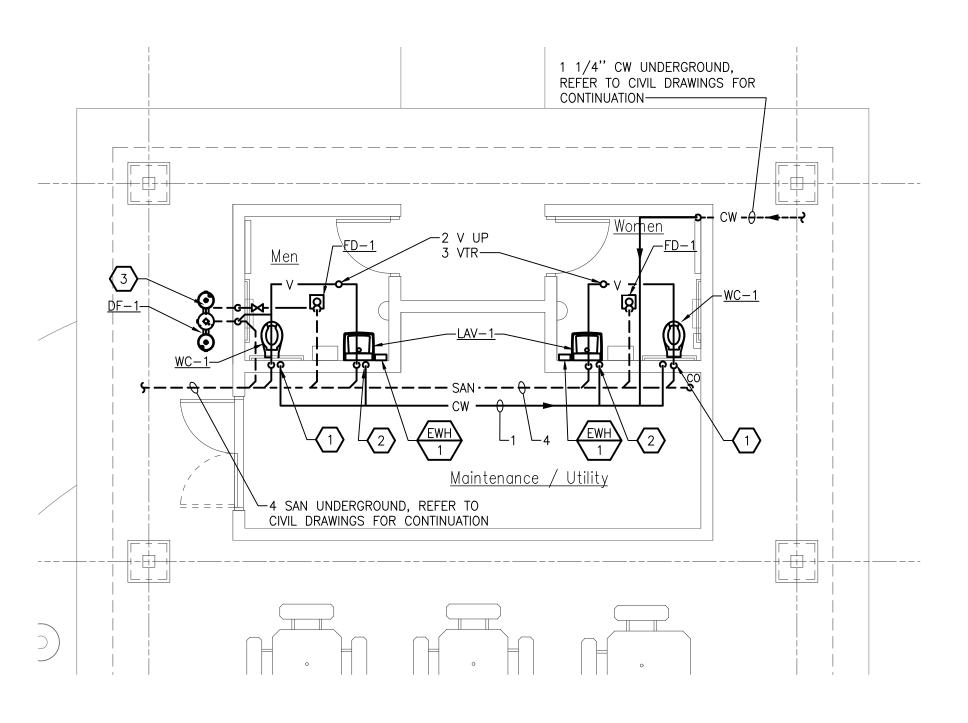
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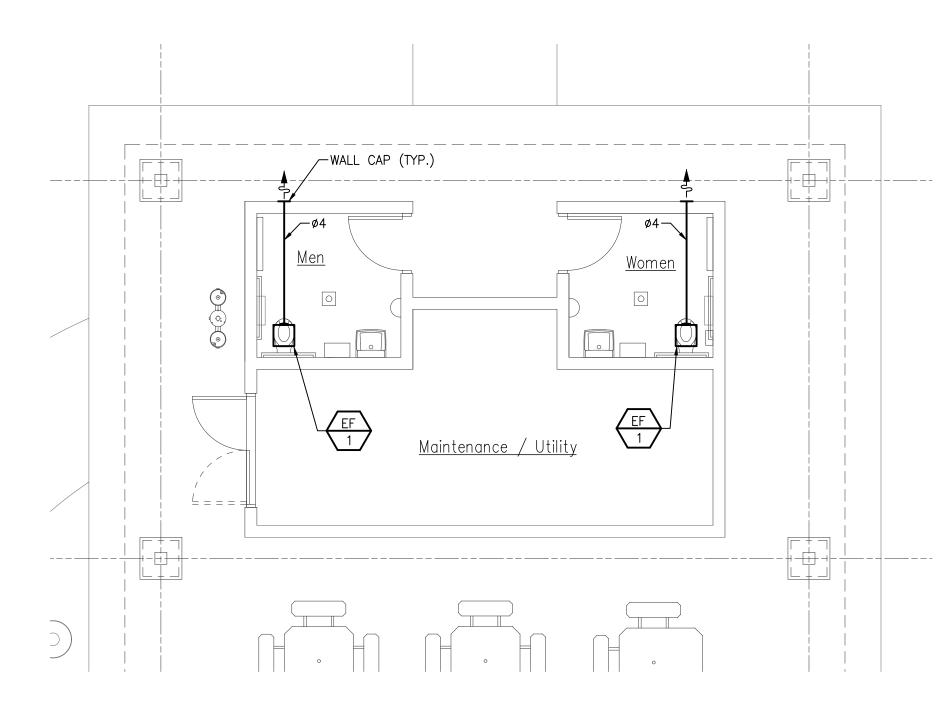
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		PL	UMBI	NG F	FIXTL	IRE S	CHEDULE	
TAG	BARRIER FREE	ITEM	PIF WASTE	PE CONNE VENT	CTION SIZ	ES HW	MANUFACTURER & MODEL NO.	ACCESSORIES
FD-1	_	FLOOR DRAIN	3"	1 1/2"	-	-	ZURN: Z-415-B	
LAV-1	Y	WALL MOUNTED LAVATORY	1 1/2"	1 1/2"	1/2"	1/2"	AMERICAN STANDARD: LUCERNE	FAUCET: AMERICAN STANDARD: RELIANT 3. DECK MOUNTED SOAP DISPENSER: AMERICAN STANDARD MODEL # 4503.115.PROVIDE ASSE 1070 MIXING VALVE.
DF-1	ı	BI-LEVEL DRINKING FOUNTAIN WITH BOTTLE FILLER	2"	1 1/2"	1/2"	I	MODEL 10145 SM, BLUE COLOR	PROVIDE WITH HOSE BIBB
WC-1	Y	WALL MOUNTED WATER CLOSET	4"	2"	1"	-	KOHLER: KINGSTON. MODEL: K-4325	FLUSH VALVE: KOHLER K-13516, 1.6 GPF

# NOTES:

- 1. SUPPLY ALL FIXTURES WITH LOOSE KEY STOPS.
- 2. PROVIDE ALL ACCESSORIES NECESSARY FOR COMPLETE AND OPERABLE INSTALLATION.
- 3. PROVIDE CARRIERS FOR ALL FIXTURES PER MANUFACTURER'S RECOMMENDATIONS.
- 4. WHERE REQUIRED AND WHERE DESIGNATED, FIXTURES SHALL BE FURNISHED AND INSTALLED IN ACCORDANCE TO THE LATEST EDITION OF "THE BARRIER" FREE DESIGN REQUIREMENTS OF THE STATES CONSTRUCTION CODE.
- 5. REFER TO ARCHITECTURAL ELEVATIONS FOR EXACT LOCATION/MOUNTING HEIGHT OF ALL FIXTURES.

	EXHAUST FAN SCHEDULE													
	050/10/0	P. (0.E.	0.514	ESP	FAN	MOTOR	ELECT	RICAL						
UNIT ID	SERVING	TYPE	CFM	(IN WG)	RPM	WATTS	VOLTS	PHASE	MODEL NO.					
EF-1	RESTROOM	CEILING	90	0.25	1,161	20.7	120	1	FV-11VQ5					
NOTEC.														

- 1. MODEL NUMBERS ARE PANASONIC UNLESS OTHERWISE NOTED.
- 2. PROVIDE WITH GRAVITY BACKDRAFT DAMPER.
- 3. CONTROL SHALL BE BY MANUAL MOTOR STARTER PROVIDED
- BY ELECTRICAL TRADES.
- 4. PROVIDE WALL CAP AT TERMINATION POINT.

T				RIC A	
UNIT ID	VOLTS	PHASE	HERTZ	KW INPUT	MODEL NO.
EWH-1	208	1	60	4.1	SP4208

NOTES:

1. MODEL NUMBERS ARE EEMAX UNLESS OTHERWISE NOTED.

# MECHANICAL GENERAL NOTES

- 1. THESE DRAWINGS ARE DIAGRAMMATIC & INDICATE THE GENERAL EXTENT OF THE WORK. PROVIDE PLUMBING AND HVAC SYSTEMS COMPLETE PER SPECIFICATION, SMACNA STANDARDS, AND PER APPLICABLE CODES INCLUDING ALL NECESSARY OFFSETS, FITTINGS, SPECIAL RADIUS OR MITERED ELBOWS WHICH ARE REQUIRED DUE TO SPACE CONSTRAINTS OR OTHER STRUCTURAL CONDITIONS.
- 2. CONTRACTOR SHALL COORDINATE HIS WORK WITH THE WORK OF ALL OTHER TRADES. VERIFY ALL CLEARANCES PRIOR TO THE FABRICATION OF ANY WORK.
- 3. DUCTWORK/PIPING SHALL NOT BE LOCATED OVER ELECTRICAL EQUIPMENT/PANELS. PROVIDE REQUIRED CLEARANCE IN FRONT OF ELECTRICAL EQUIPMENT. DUCTWORK/PIPING SHALL NOT INTERFERE WITH ELECTRICAL EQUIPMENT CLEARANCE.
- 4. THE CONTRACTOR SHALL PROVIDE ALL MISCELLANEOUS SUPPORTING STEEL, ETC. FOR THE PROPER INSTALLATION OF ALL MECHANICAL SYSTEMS.
- 5. COORDINATE FLOOR, WALL, ROOF PENETRATIONS, LOUVER SIZES, PAD LOCATIONS ETC. WITH ARCHITECTURAL TRADES.
- 6. REFER TO ARCHITECTURAL PLANS FOR SPECIFICATIONS AND EXACT LOCATIONS OF FIXTURES (STANDARD AND BARRIER FREE), SINKS, ETC.
- 7. REFER TO ARCHITECTURAL REFLECTED CEILING PLANS FOR EXACT LOCATION OF GRILLES, REGISTERS, AND DIFFUSERS. 8. PIPING/DUCTWORK SHALL NOT BE LOCATED OVER ELECTRICAL EQUIPMENT/

PANELS. PROVIDE REQUIRED CLEARANCE IN FRONT/ABOVE OF ELECTRICAL

EQUIPMENT. PIPING SHALL NOT INTERFERE WITH ELECTRICAL EQUIPMENT

- 9. PIPING SHALL NOT BE INSTALLED IN A LOCATION THAT RESTRICTS THE ACCESS TO MECHANICAL DEVICES REQUIRING ACCESS.
- 10. HOT AND COLD WATER PIPING RUN-OUTS TO LAVS AND SINKS SHALL BE 3/4" UNLESS NOTED OTHERWISE. REFER TO PLUMBING FIXTURE SCHEDULE FOR CONNECTION SIZES. PROVIDE BRANCH LINE ISOLATION VALVES ON DOMESTIC PIPING TO EACH GROUP OF FIXTURES AND TOILET ROOMS. PROVIDE FULL OPEN VALVES PER PLUMBING CODE.
- 11. PROVIDE CODE REQUIRED CLEARANCE/ACCESS DOORS FOR DAMPERS, VALVES, AND CLEANOUTS LOCATED IN WALLS OR ABOVE HARD CEILINGS, AND LOCATIONS OF CLEANOUTS INSTALLED IN STORM AND SANITARY PIPING. COORDINATE LOCATIONS WITH ARCHITECT. PROVIDE CLEANOUTS AT THE BASE OF ALL STACKS. REFER TO ARCHITECTURAL PLANS FOR CEILING TYPES.
- 12. FOR EQUIPMENT VALVING, COMPONENT, AND PIPING ARRANGEMENT, REFER TO PIPING DIAGRAMS AND DETAILS.
- 13. MAXIMUM LENGTH OF FLEXIBLE DUCT SHALL BE 5'-0".

CLEARANCE.

# □E□ED NOTES

- 1 ROUTE 4" SANITARY, 2" VENT AND 1 1/4" CW DOWN TO WATER CLOSET.
- 2 ROUTE 1/2" SANITARY, 1 1/4" VENT, 1/2" HOT WATER DOWN TO LAVATORY.
- ROUTE 3" SANITARY, 1 1/2" VENT AND 1/2" COLD WATER DOWN TO DRINKING FOUNTAIN.

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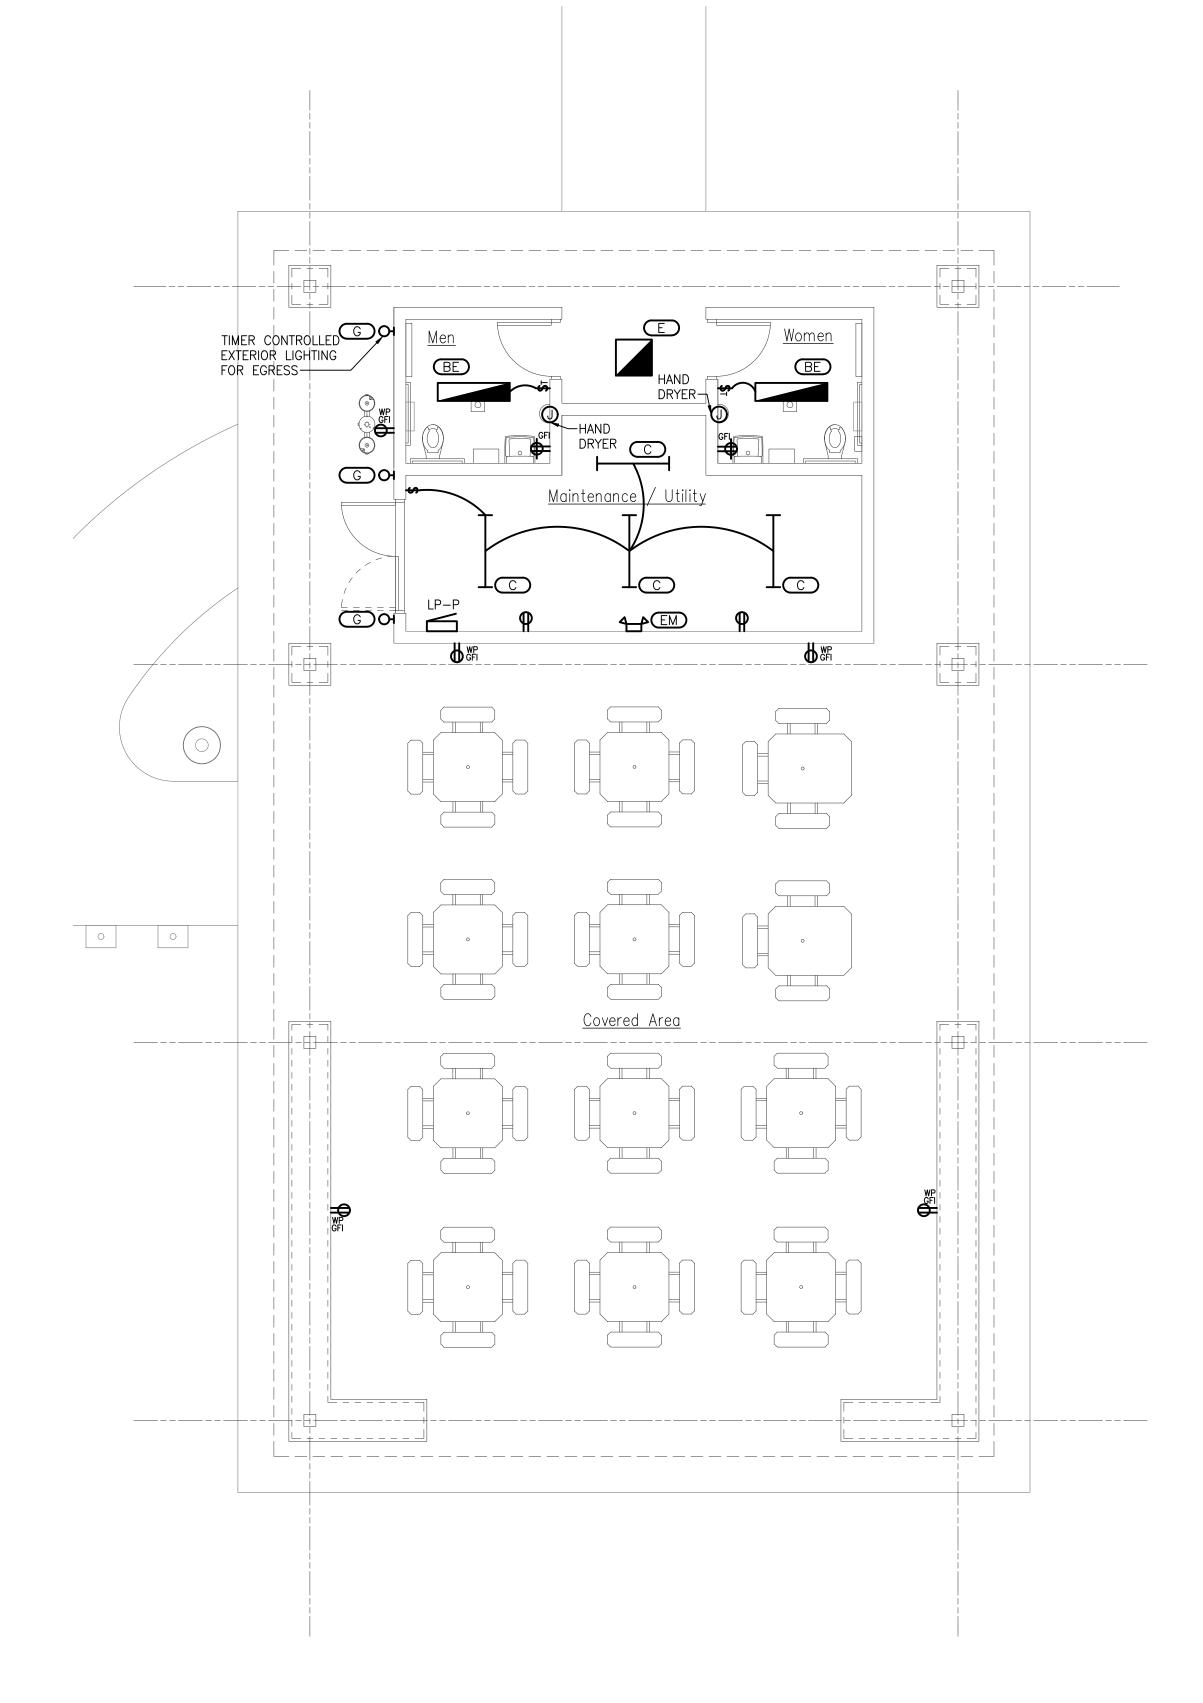
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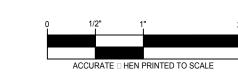
# ELECTRICAL GENERAL NOTES

- REFER TO ARCHITECTURAL REFLECTED CEILING PLAN FOR EXACT LOCATION OF ALL LIGHTING FIXTURES UNLESS OTHERWISE NOTED.
- 2. SEE LUMINAIRE SCHEDULE ON ELECTRICAL GENERAL INFORMATION SHEET.
- 3. EXIT LIGHTS AND EMERGENCY BATTERY UNITS SHALL BE UNCONTROLLED AND TIED AHEAD OF LOCAL AREA LIGHTING SWITCH, UNLESS CIRCUITED OTHERWISE.
- 4. WHERE MORE THEN ONE LIGHT SWITCH IS INDICATED TO BE INSTALLED AT THE SAME LOCATION, THEY SHALL BE GROUPED UNDER ONE COMMON FACEPLATE.
- 5. ALL ELECTRICAL DEVICES SHOWN ON THIS PLAN SHALL BE NEW UNLESS OTHERWISE NOTED.
- 6. ANY 120 VOLT BRANCH CIRCUIT FEEDER LONGER THAN 75'-0" TO LAST DEVICE SHALL BE SIZED TO THE NEXT LARGER STANDARD AWG SIZE. E.C. SHALL FIELD VERIFY ALL LENGTHS OF FEEDERS.
- 7. ALL RECEPTACLES SHALL BE 20A. RATED.
- 8. ALL DISCONNECT SWITCHES SHALL BE HEAVY DUTY TYPE.
- 9. ALL RECEPTACLES WITHIN 6'-0" OF SINK OR OTHER WATER SUPPLY SHALL BE GFCI TYPE RECEPTACLE.
- 10. REFER TO ARCHITECTURAL FLOOR PLAN AND ELEVATIONS FOR EXACT LOCATION OF DEVICES.
- 11. ALL JUNCTION BOXES SERVING BRANCH CIRCUIT WIRING SHALL BE LABELED WITH CIRCUITS SERVED.
- 12. ALL 120 VOLT CIRCUITS SHALL UTILIZE A SEPARATE NEUTRAL.
- 13. ALL CONDUITS SERVING 120 VOLTS OR GREATER SHALL INCLUDE A GROUND WIRE.
- 15. ALL ELECTRICAL EQUIPMENT MOUNTED ON THE FLOOR SHALL BE MOUNTED ON A 4" CONCRETE HOUSE KEEPING PAD.
- ALL BRANCH CIRCUIT WIRING SHALL BE 2#12, 1#12GND IN 3/4" CONDUIT, UNLESS NOTED OTHERWISE.

14. ALL CONDUITS SHALL BE ROUTED CONCEALED UNLESS NOTED OTHERWISE.

PANEL N	AME: LP-P					Ν	AAIN:	150A	BREAKE	:R			ı	L VOLTAGE:	: 208
LOCA	TION: PAVILION #	3				BUSS	SING:	225A					L.	-N VOLTAGE:	: 120
	URCE: FARMER'S M		=		GR		BUS:		DARD					PHASE	
FEEDER		MINEL SERVICE	-				ING:							WIRE	
FEEDER	SIZE:				IV				ACE			_			
	T		ı	ı		NEU	TRAL:	100%					AIN SC INTERR	UPI KATING:	22kA
LOAD DESCRIPTION	LIGHTIN G LOAD	RECEPTACLE LOAD	CONTINUOUS	NON- CONTINUOUS LOAD	OCPD	СКТ	L1	L2 CK	т ОСРІ	CON	NON- NTINUOUS LOAD	CONTINUOUS LOAD	RECEPTACLE LOAD	LIGHTING LOAD	LOAD DESCRIPTION
PARKING LOT LIGHTING	1400	0			20	1		2	20				0	1000	SPORT FIELD LIGHTING - SOCCER
PARKING LOT LIGHTING	1000	0			20	3		4	20				0	1000	SPORT FIELD LIGHTING - SOCCER
PARKING LOT LIGHTING	1200	0			20	5		6	20				0	1000	SPORT FIELD LIGHTING - SOCCER
SPARE		0			20	7		8	20				0	1000	SPORT FIELD LIGHTING - SOCCER
SPARE		0			20	9		10	20				0	1000	SPORT FIELD LIGHTING - BASKETBALL
SPARE		0			20	11		1:	2 20				0	1000	SPORT FIELD LIGHTING - BASKETBALL
SPARE		0			20	13		14	<b>1</b> 20				0	1000	SPORT FIELD LIGHTING - BASKETBALL
SPARE		0			20	15		10	<b>3</b> 20				0	1000	SPORT FIELD LIGHTING - BASKETBALL
SPARE		0			20	17		18	3 20				0		SPARE
SPARE		0			20	19		20	20				0		SPARE
PACE		0			20	21		22					0		SPACE
SPACE		0			20	23		24					0		SPACE
PACE		0			20	25		20	3 20				0		SPACE
PACE		0			20	27		28	3 20				0		SPACE
PACE		0			20	29		30	20				0		SPACE
PACE		0			20	31		32	2 20				0		SPACE
PACE		0			20	33		34	1 20				0		SPACE
PACE		0			20	35		36	20				0		SPACE
PACE		0			20	37		38	3 20				0		SPACE
PACE		0			20	39		40	20				0		SPACE
		CONNEC	TEDIOAD		1		D F 4 4 4 4	10				DEMAN	DICAD		1
LOAD TYPE	L1	CONNEC	TED LOAD L2	TOTAL	l		DEMAN FACTO			_	L1	DEMAN	L2	TOTAL	
IGHTING LOAD (VA)	6600		5000	11600	$\vdash$		1.00			+	6600		5000	11600	1
RECEPTACLE LOAD (VA)	0		0	0	<u> </u>	1 00	(FIRST		.)	+	0		0	0	I RECEPTACLE DEMAND FACTOR PER
RECEFIACLE LOAD (VA)	<u> </u>	A ma =	Ţ.		<u> </u>		(FIRS) 50 (> 10		<b>'</b>	_					4
CONTINUOUS LOAD (VA)		Amoui	nt over 10kVA	0		0.5					0		0	0	ARTICLE 220.44 OF THE NEC
CONTINUOUS LOAD (VA)	0		0	0			1.00				0		0	0	4
NON-CONTINUOUS (VA)	0	1	0	0	105%	VE 11/21			D RECEP	<del>,</del>	0		0	0	4
TOTAL LOAD (KVA)	6.60		5.00	11.60							6.60		5.00	11.60	1
TOTAL AMPACITY (A)	55.0		41.7	55.8		-			IER LOAI		55.0		41.7	55.8	1
MINIMUM FEEDER SIZE (A)	68.8		52.1	69.7	< P	ER NE	C ARTI	CLE 2	15.2	>	68.8		52.1	69.7	





AL NOTES

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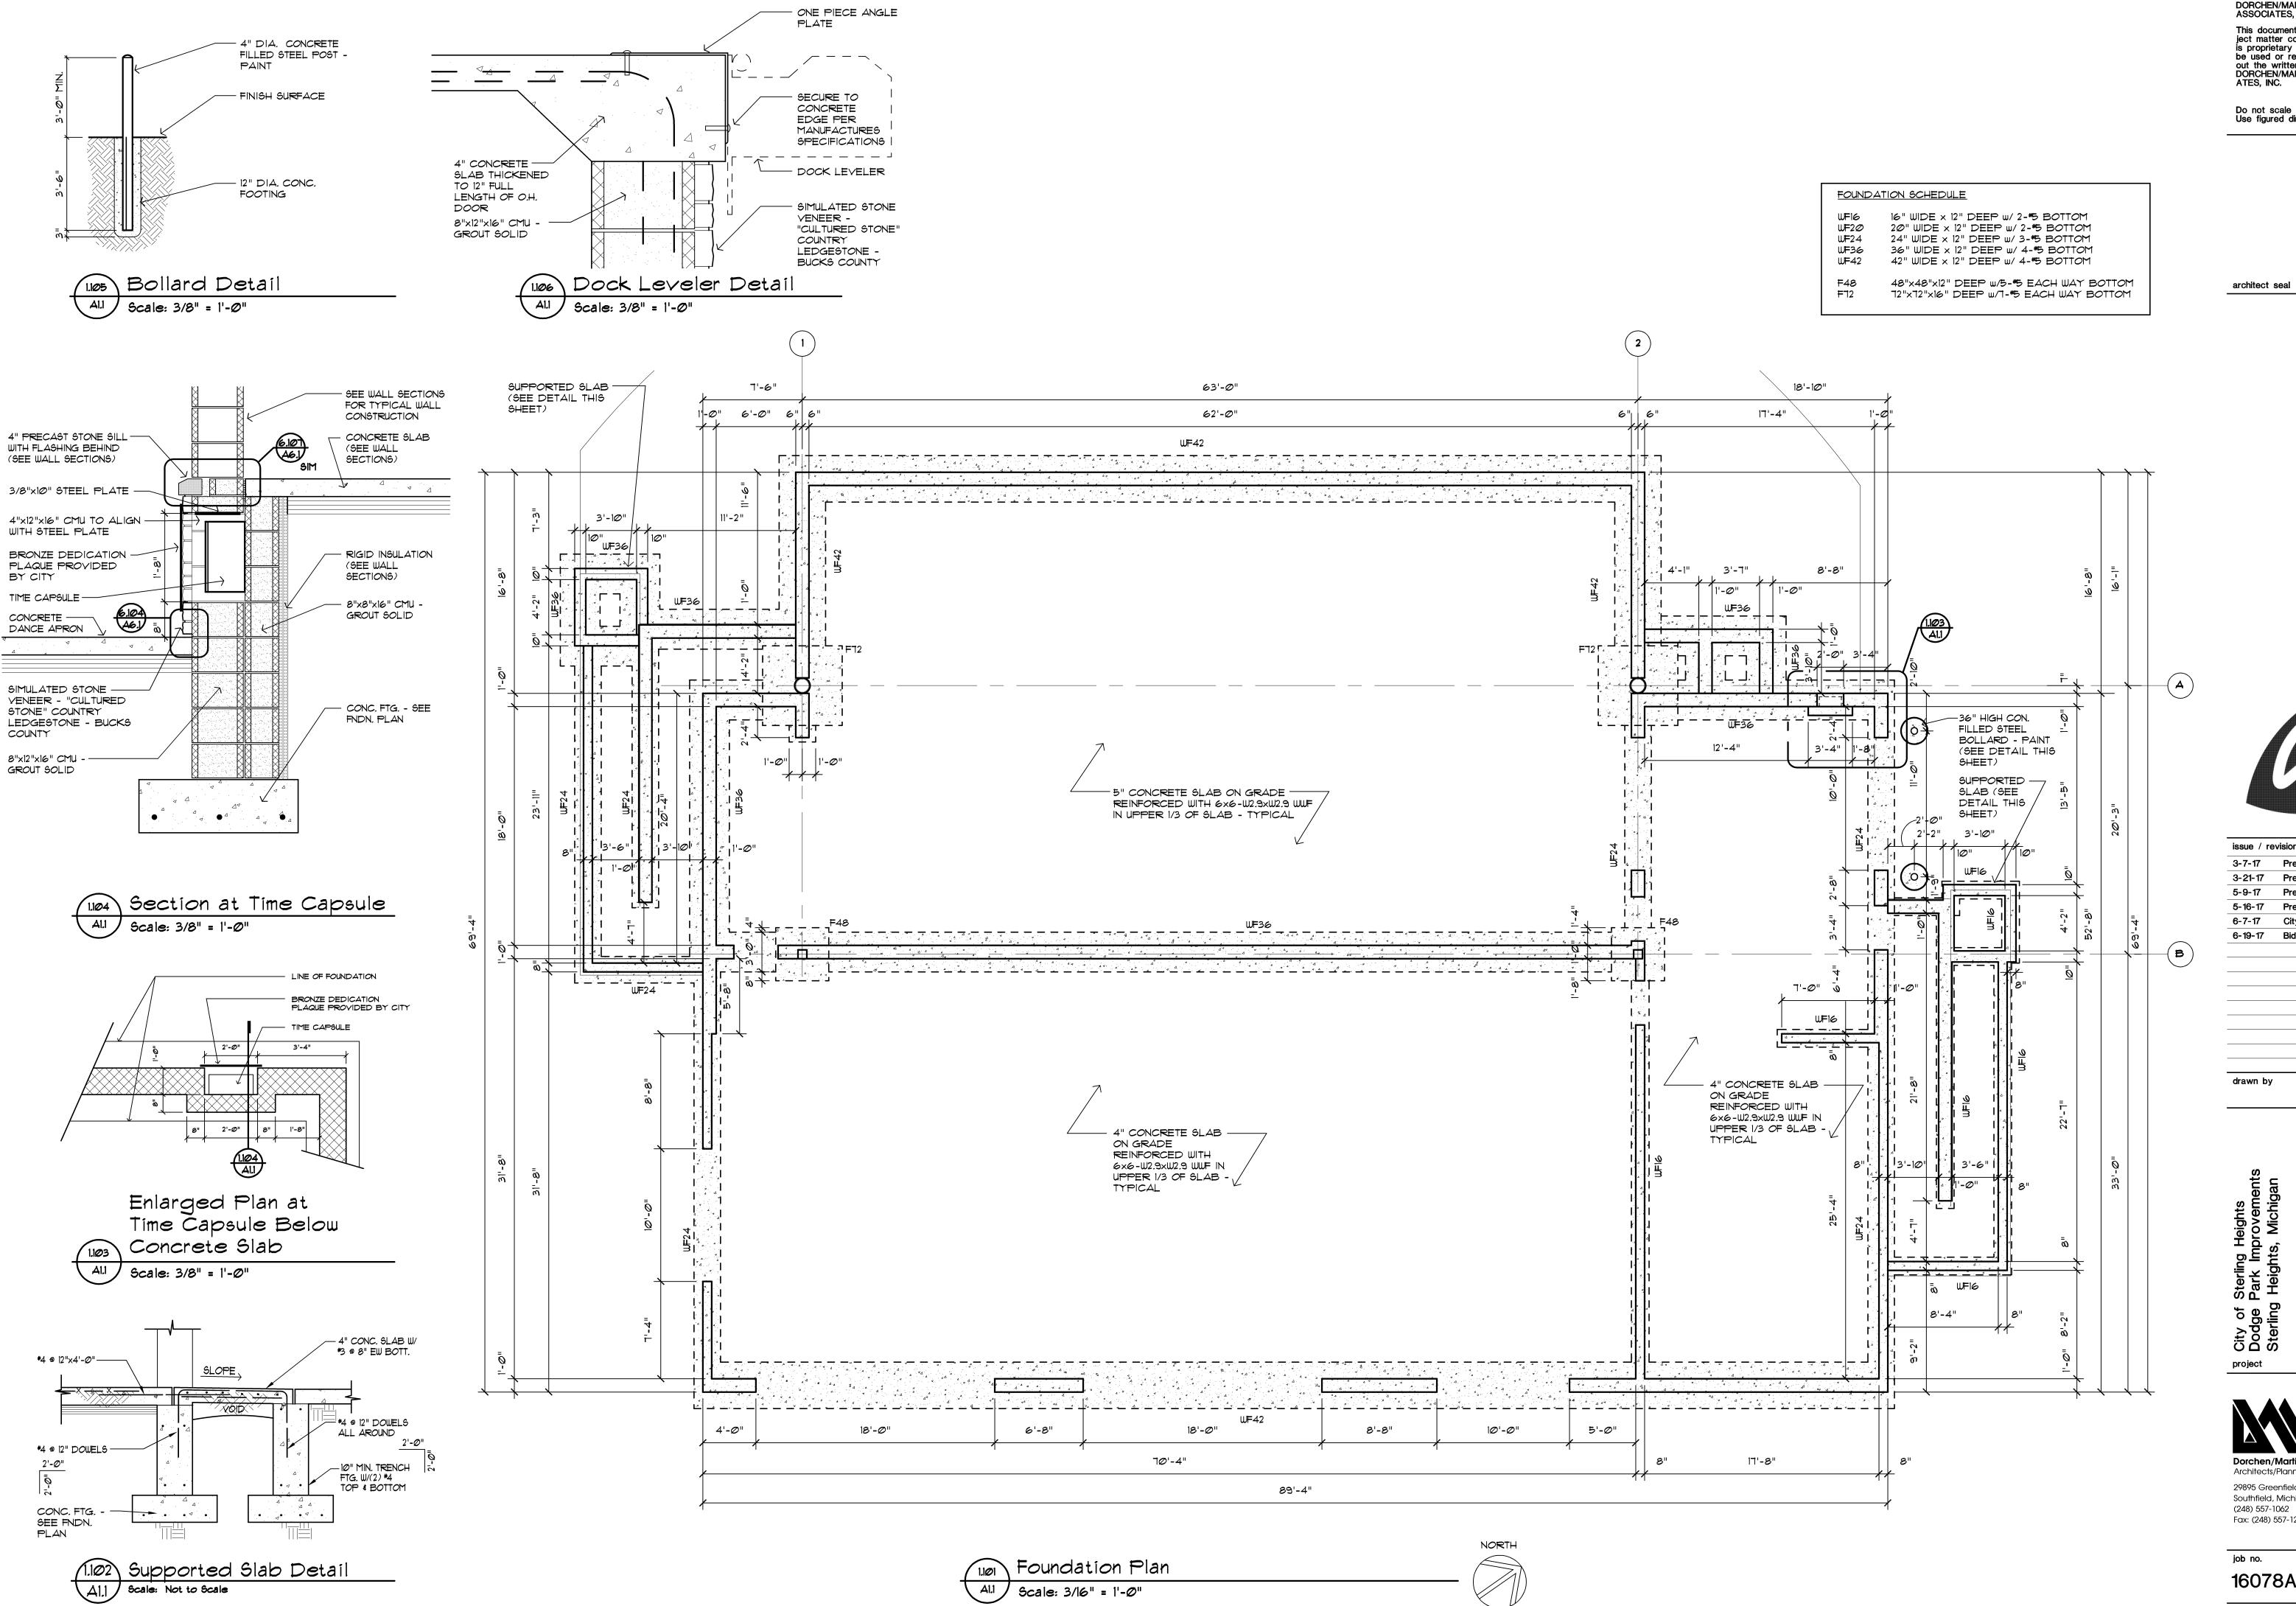
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job no. sheet no. **16078A E1.2** 



Al.1 | Scale: 3/16" = 1'-0"

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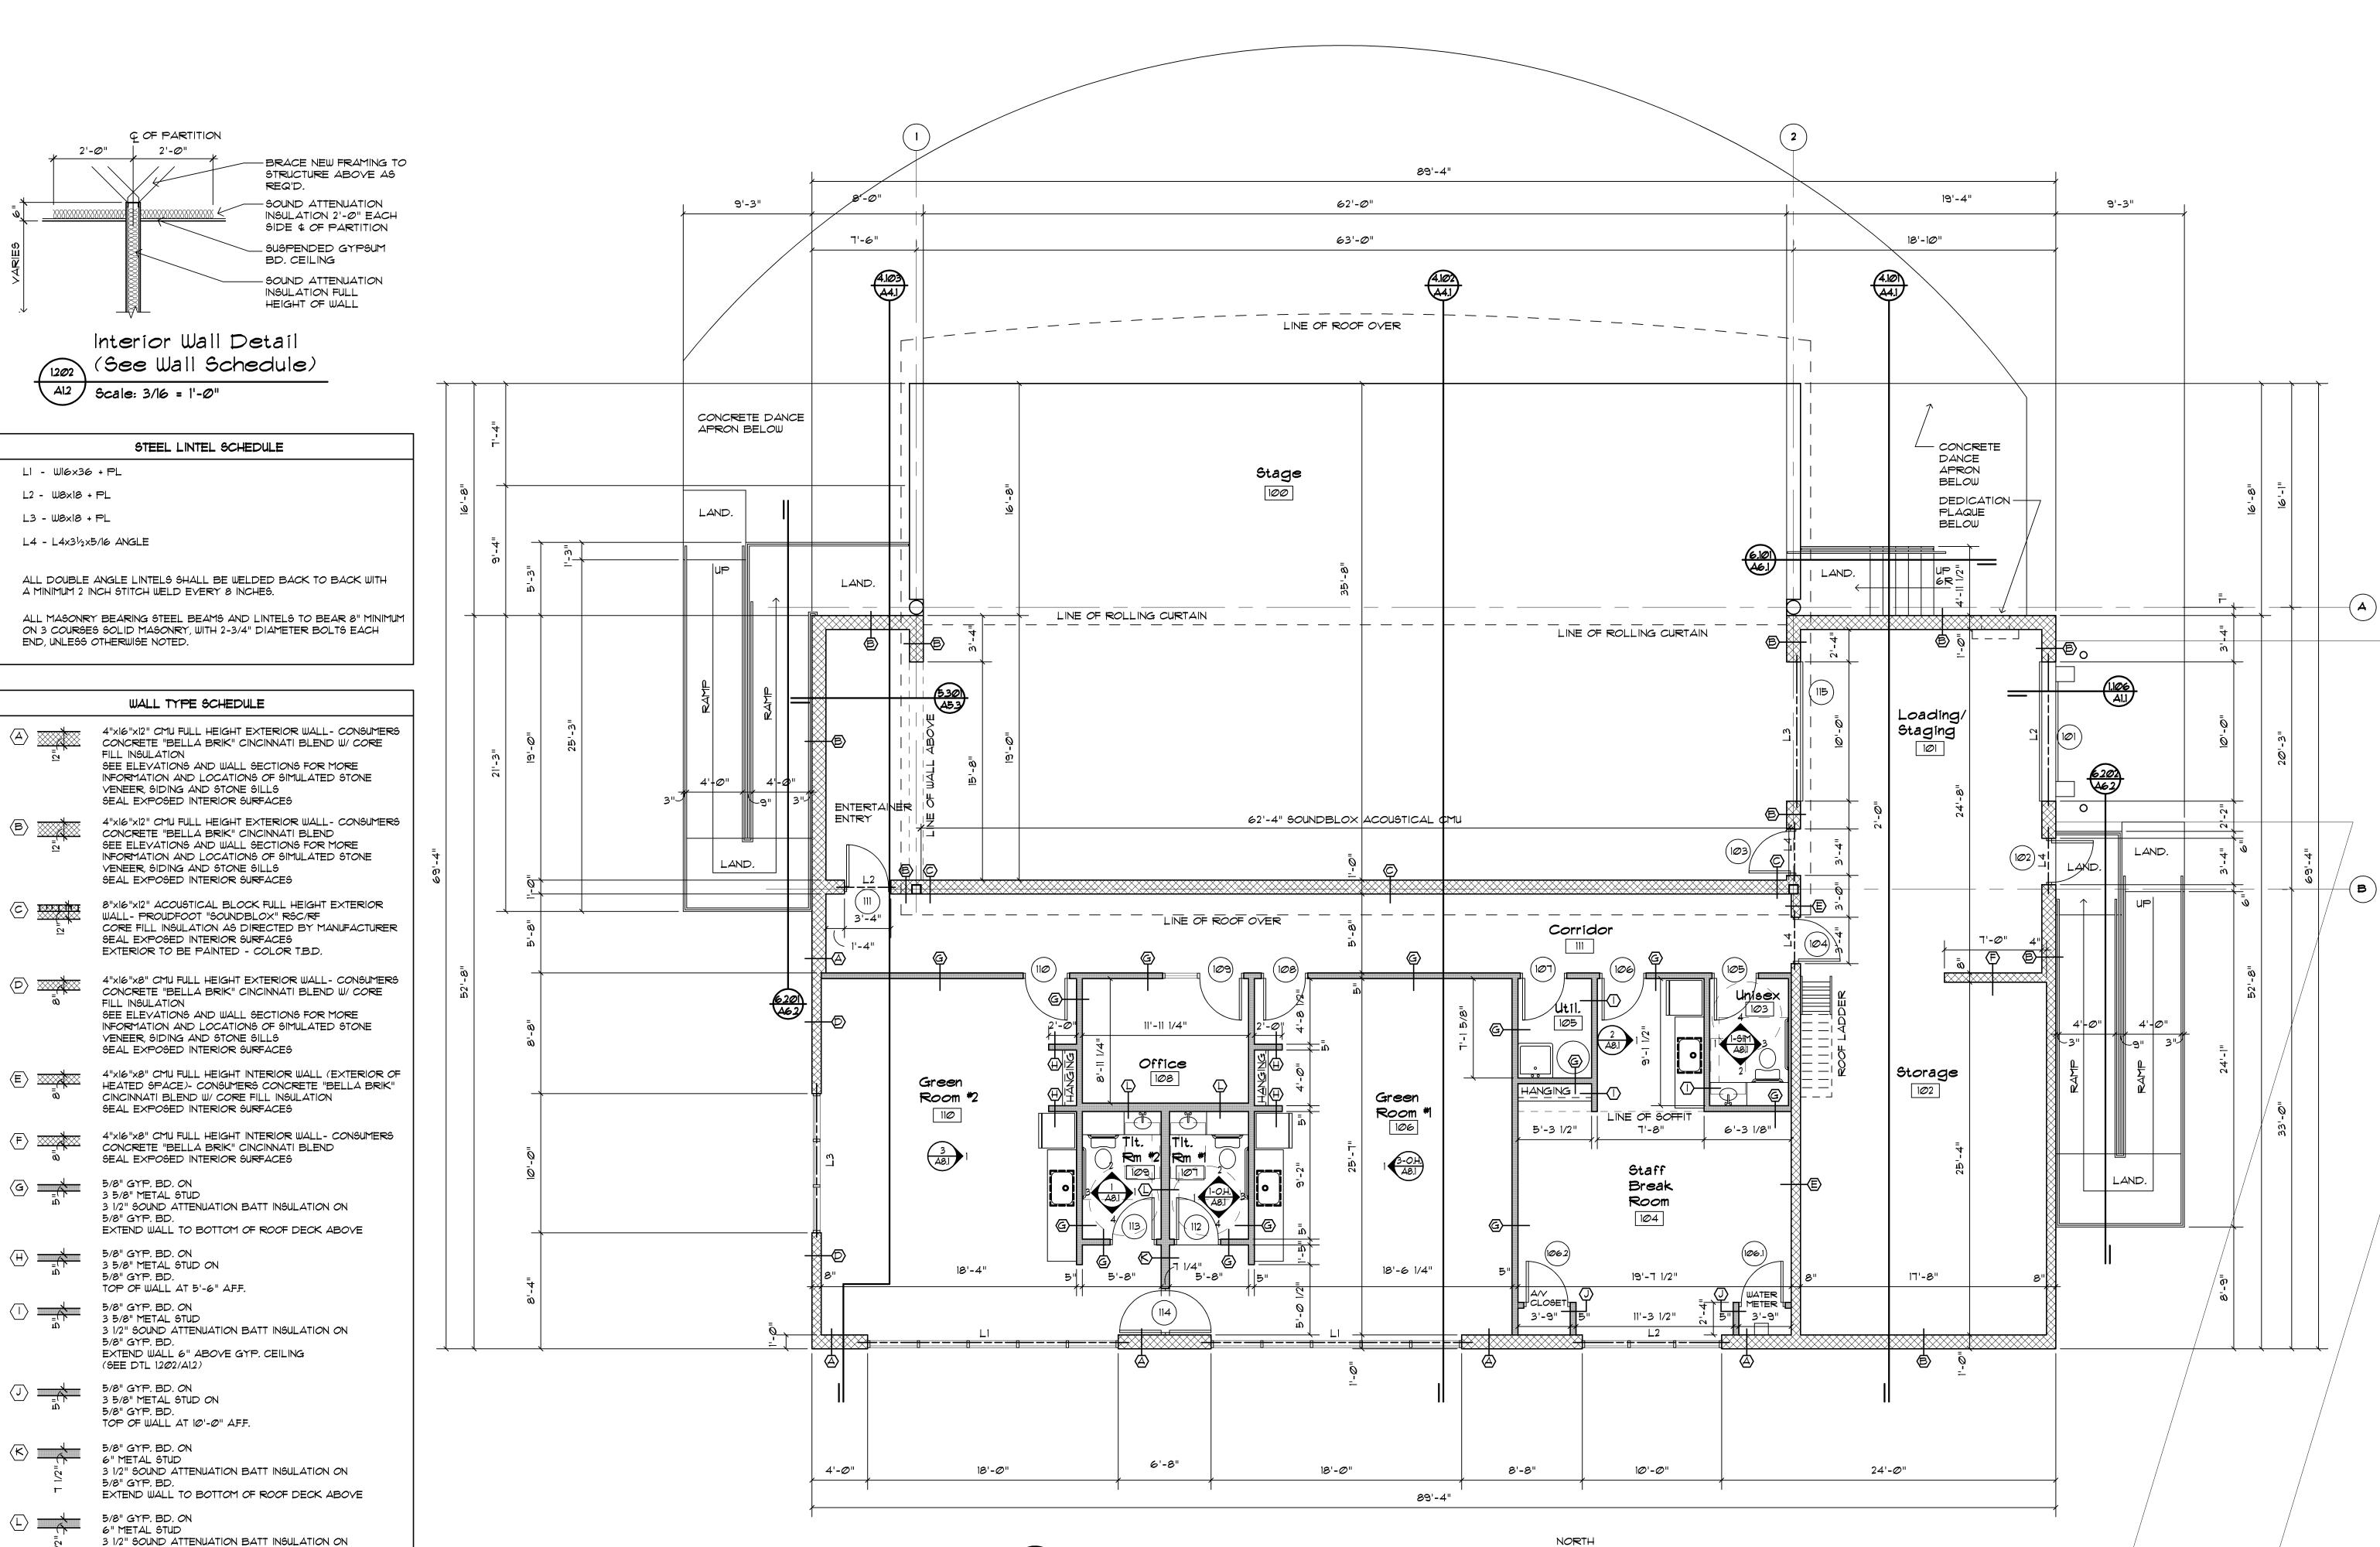
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Floor Plan

5/8" GYP. BD.

(SEE DTL 1202/A12)

EXTEND WALL 6" ABOVE GYP. CEILING

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3-7-17 Prelim. Review

3-21-17 Prelim. Review

5-9-17 Prelim. Review

5-9-17 Prelim. Review
5-16-17 Prelim. Review
6-7-17 City Review
6-19-17 Bids

drawn by checked by

drawn by checked by

Sterling Heights Park Improvements Heights, Michigan

City of Sterling
Dodge Park In
Sterling Height
Amphitheat
Floor Plan



29895 Greenfield Rd., Suite 107 Southfield, Michigan 48076 (248) 557-1062 Fax: (248) 557-1231

job no. sheet no. 16078A AMP-A1.2

Stage Loading/ Staging Corridor [ Unisex Office \_ Storage Green Room \*2 Green Room #1 Tlt. | Tlt. | Rm \*1 | | Staff Break Room

NORTH

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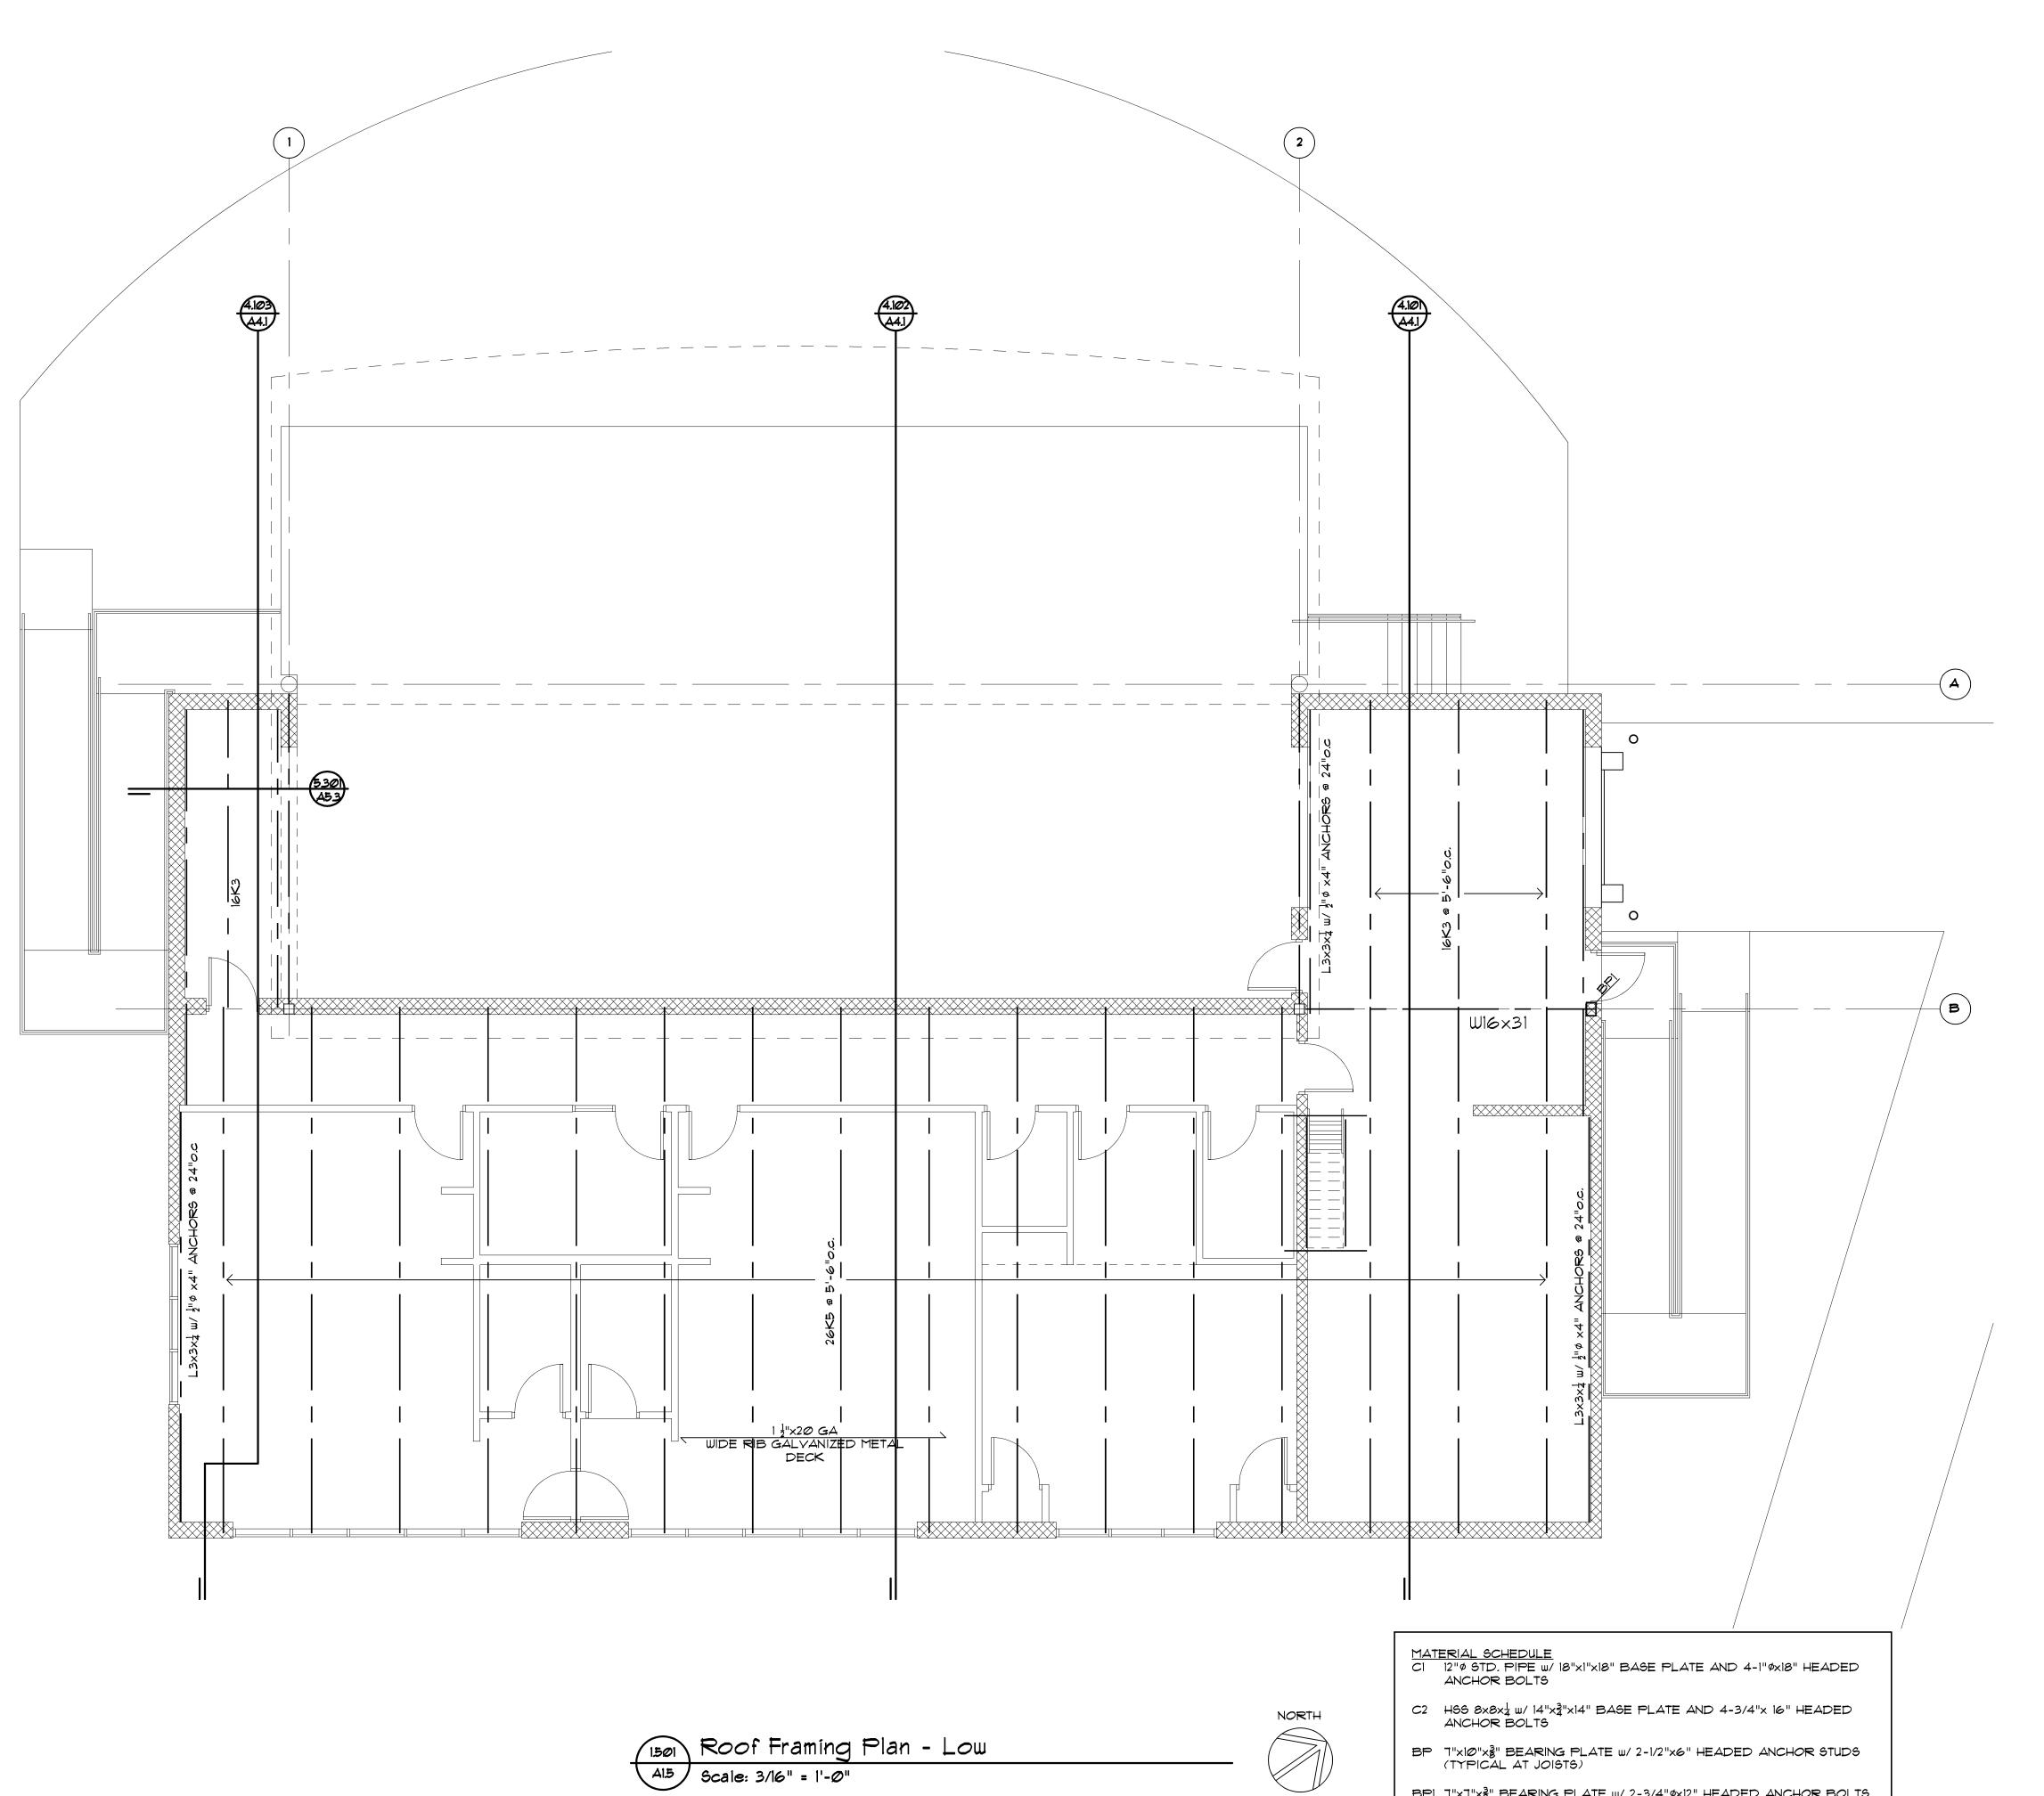
3-21-17 Prelim. Review 5-16-17 Prelim. Review 6-7-17 City Review

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ভূ City of Sterling Heights টু Dodge Park Improvements Sterling Heights, Michigan Amphitheater Reflected Ceiling

Dorchen/Martin Associates, Inc.
Architects/Planners

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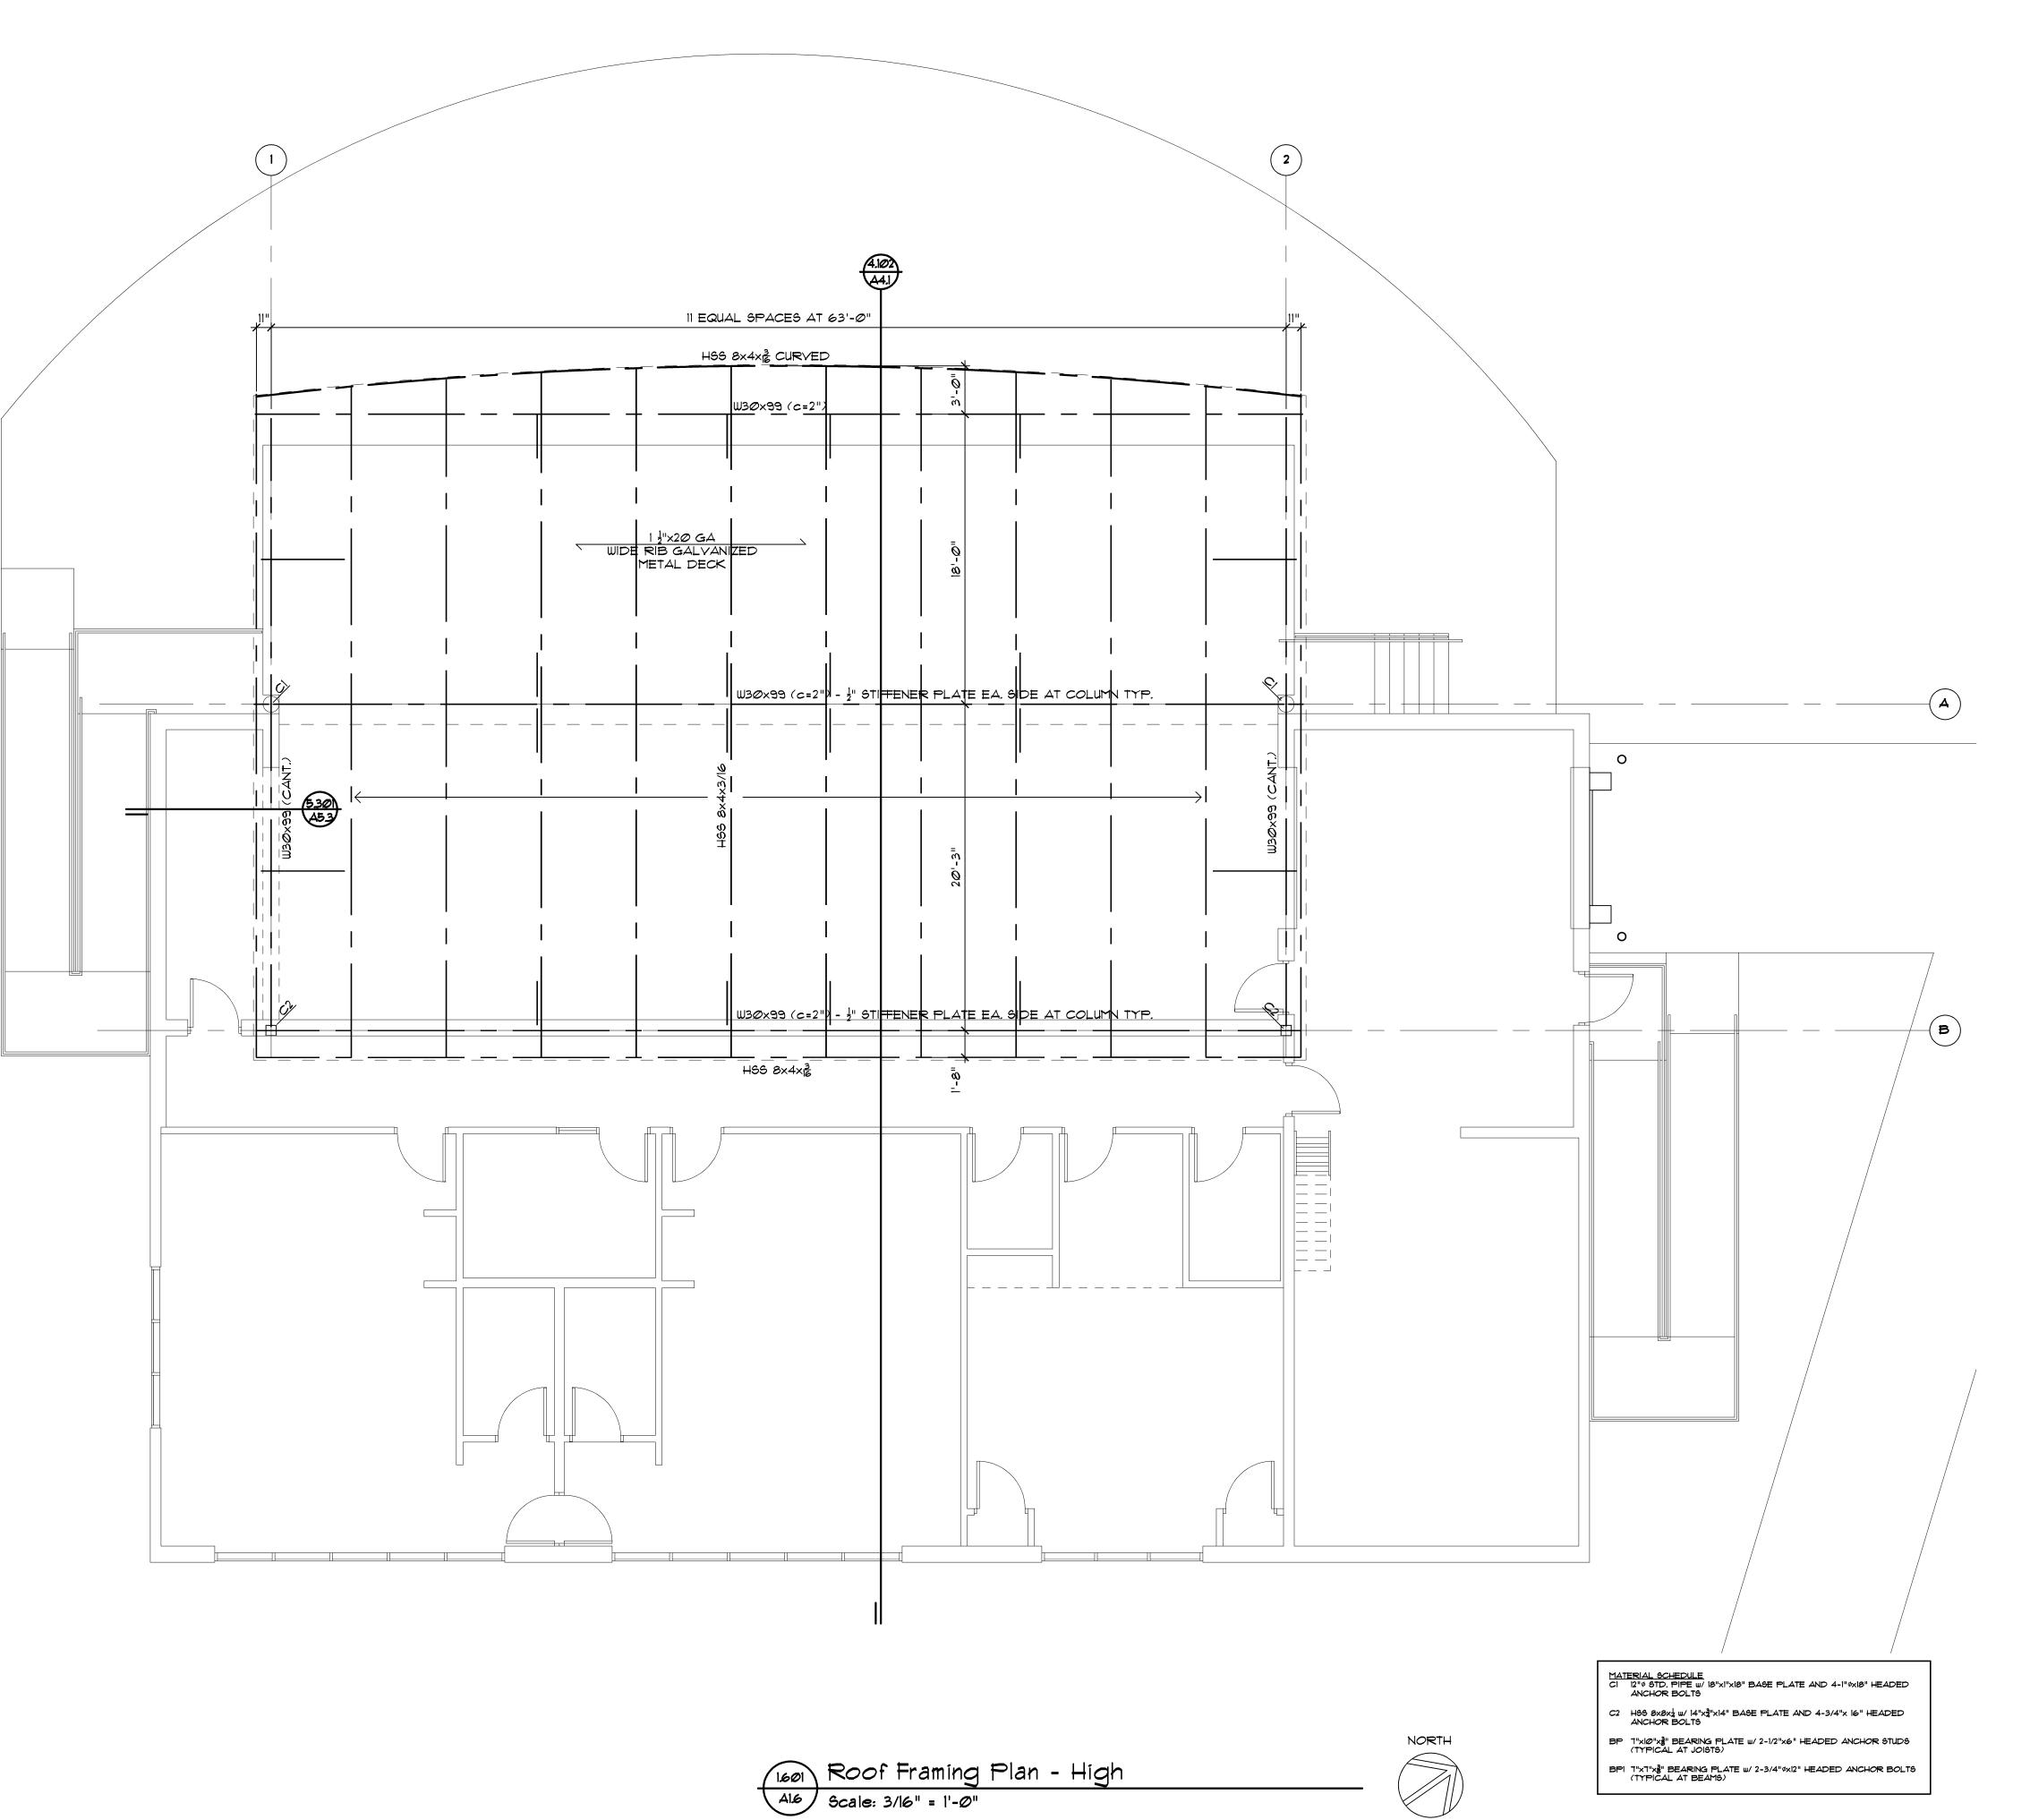
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BP 7"x10"x3" BEARING PLATE w/2-1/2"x6" HEADED ANCHOR STUDS (TYPICAL AT JOISTS)

BPI 7"x7"x}" BEARING PLATE W/ 2-3/4" Øx12" HEADED ANCHOR BOLTS (TYPICAL AT BEAMS)



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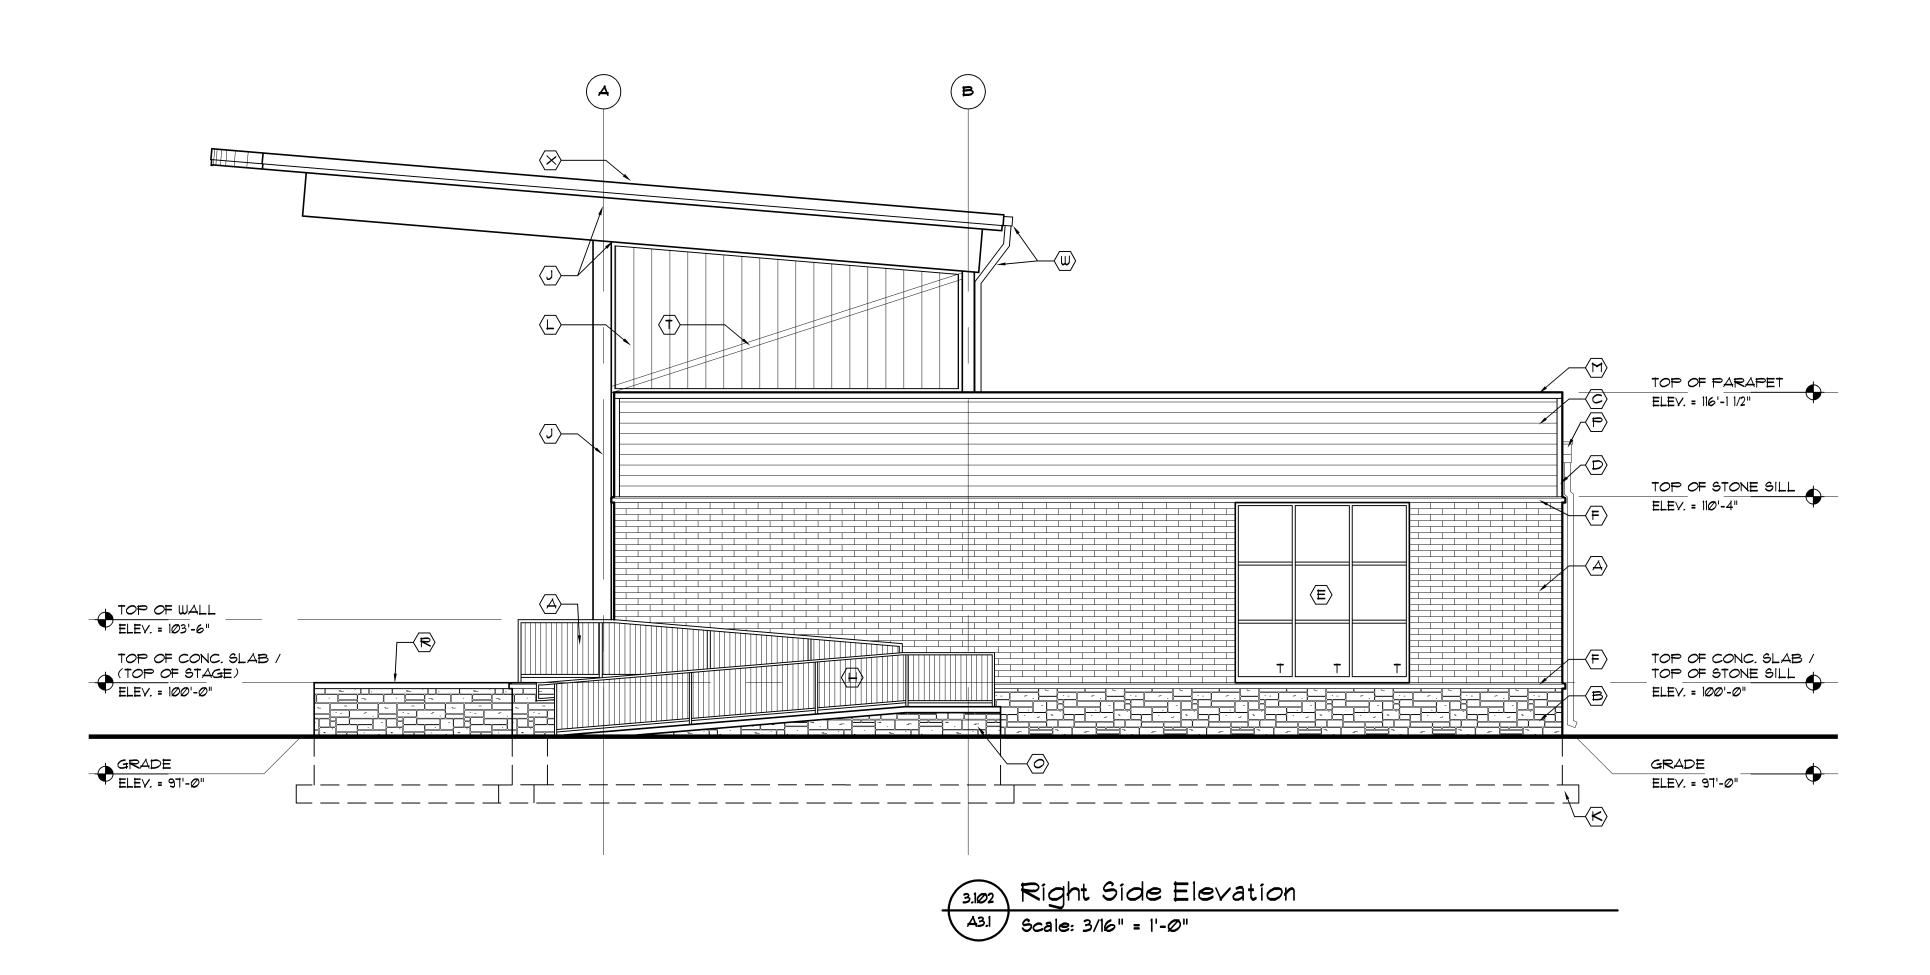
Amphitheater Roof Framing Plan

Dorchen/Martin Associates, Inc. Architects/Planners 29895 Greenfield Rd., Suite 107 Southfield, Michigan 48076 (248) 557-1062 Fax: (248) 557-1231

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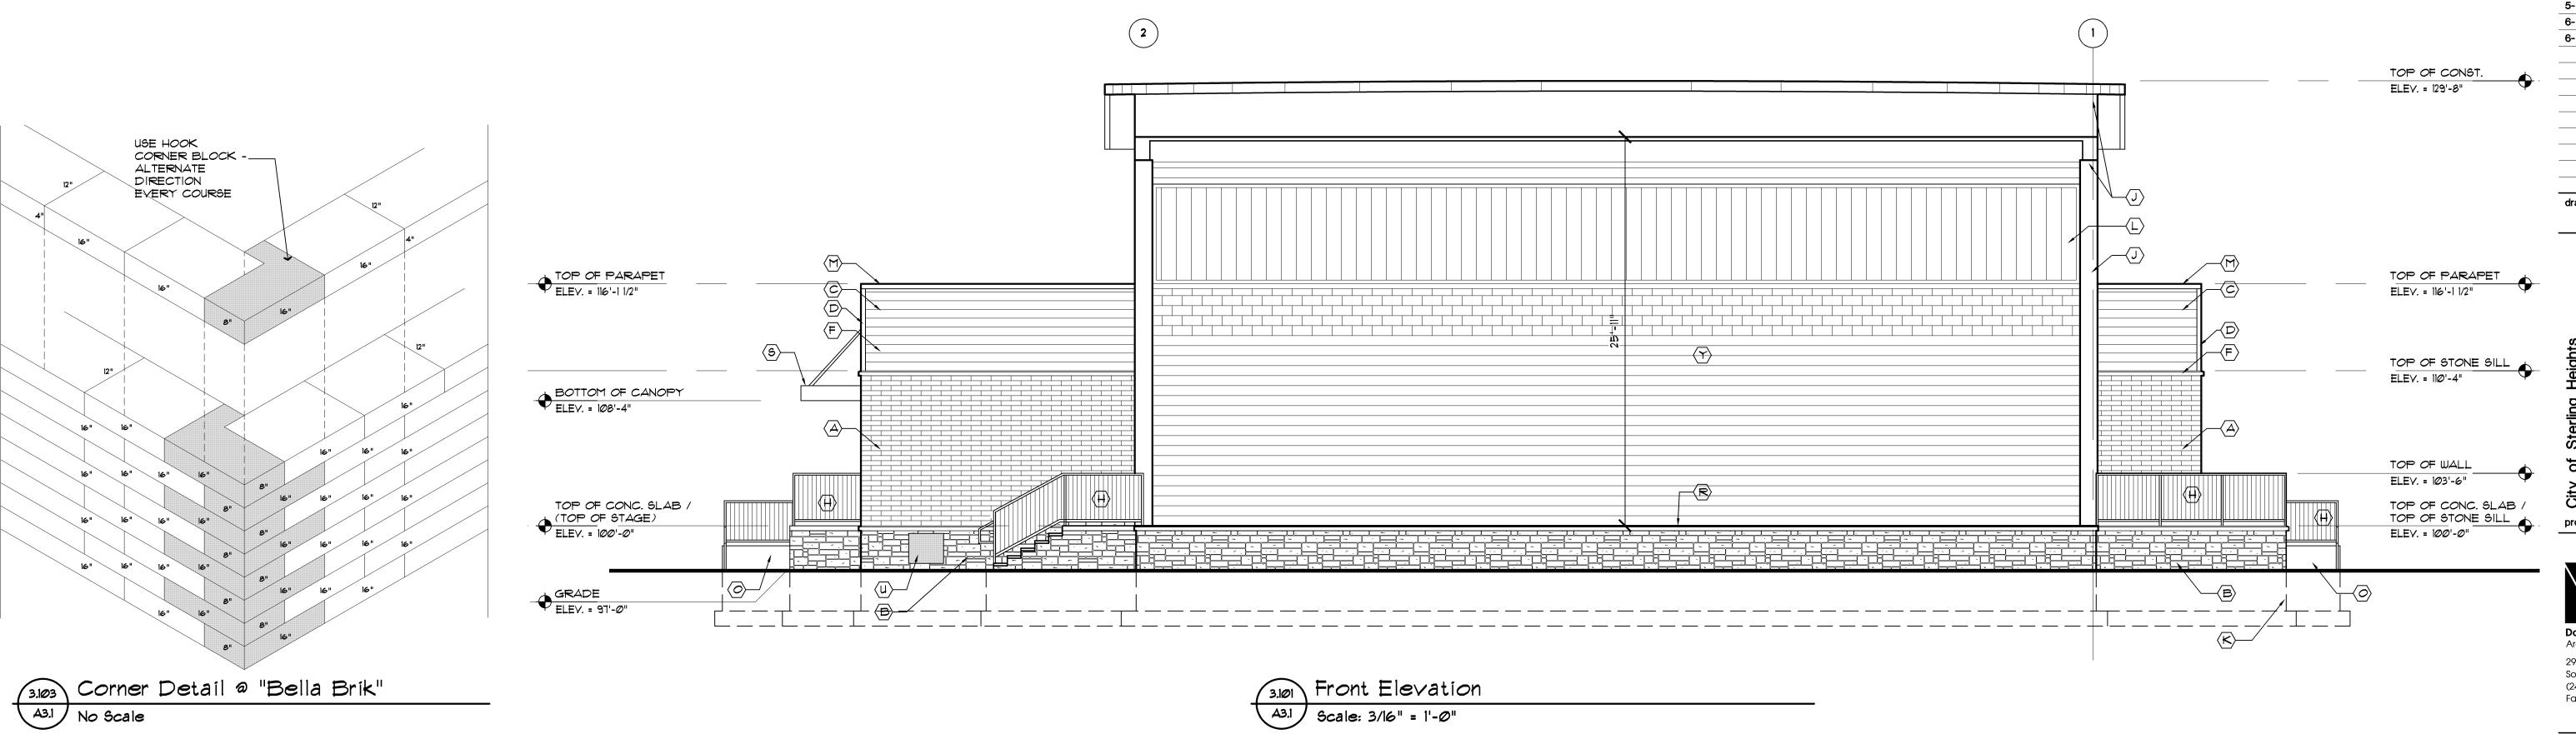
EXTERIOR FINISH MATERIAL SCHEDULE 4"x8"x16" CMU - CONSUMER'S CONCRETE "BELLA BRIK" CINCINNATI BLEND SIMULATED STONE VENEER - "CULTURED STONE" COUNTRY LEDGESTONE - BUCKS COUNTY FIBER CEMENT SIDING - WOODTONE "RUSTIC SERIES" WINCHESTER BROWN, 1" EXPOSURE 5/4×4 SMOOTH FACE FIBER CEMENT TRIM BOARD - PAINT 1" INSUL. GLAZING IN ANOD. ALUM. FRAME F 4" PRECAST SILL 4" PRECAST SLOPED CAP STEEL PIPE GUARD AND HAND RAIL - PAINT HOLLOW METAL DOOR & FRAME - SEE DOOR SCHEDULE STEEL STRUCTURE - PAINT LINE OF FOUNDATION WALL BEYOND 12" WIDE x 1/4" THICK CHANNEL GLASS FRAME SYSTEM PRE-FIN. METAL CAP / FLASHING CONCRETE RAMP CONSTRUCTION ALUM. SCUPPER AND DOWNSPOUT CONCRETE STAGE PRE-FABRICATED EXTRUDED ALUMINUM CANOPY DIAGONAL STEEL BRACE BRONZE DEDICATION PLAQUE - PROVIDED BY CITY OVERHEAD / COILING DOOR - SEE DOOR SCHEDULE ALUM. GUTTER AND DOWNSPOUT STANDING SEAM METAL ROOFING (COLONIAL RED)

ACOUSTIC CMU - SEE WALL TYPES

issue / revision date

Prelim. Review

3-7-17



3.101 Front Elevation

A3.1 Scale: 3/16" = 1'-0"

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EXTERIOR FINISH MATERIAL SCHEDULE

- 4"x8"x16" CMU CONSUMER'S CONCRETE "BELLA BRIK" CINCINNATI BLEND


BOT, CONST. AT FACE OF STAGE ELEV. = ±125'-10"


TOP OF CONC. SLAB /

ELEV. = 91'-@"

(TOP OF STAGE) ELEV. = 100'-0"

GRADE

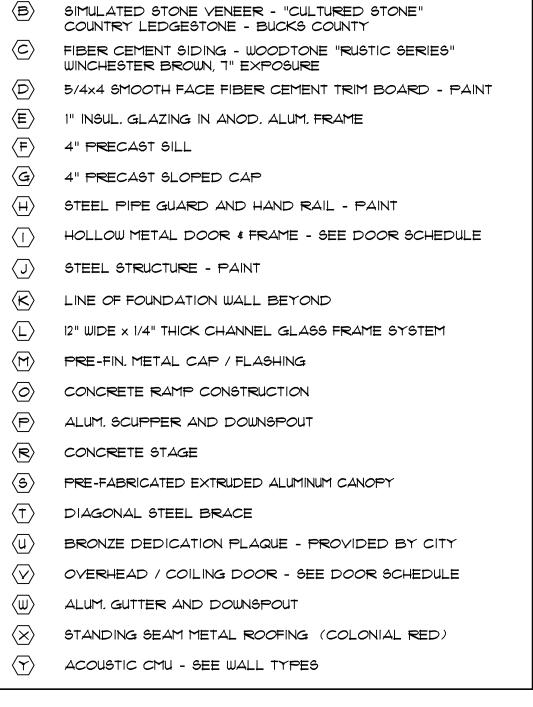

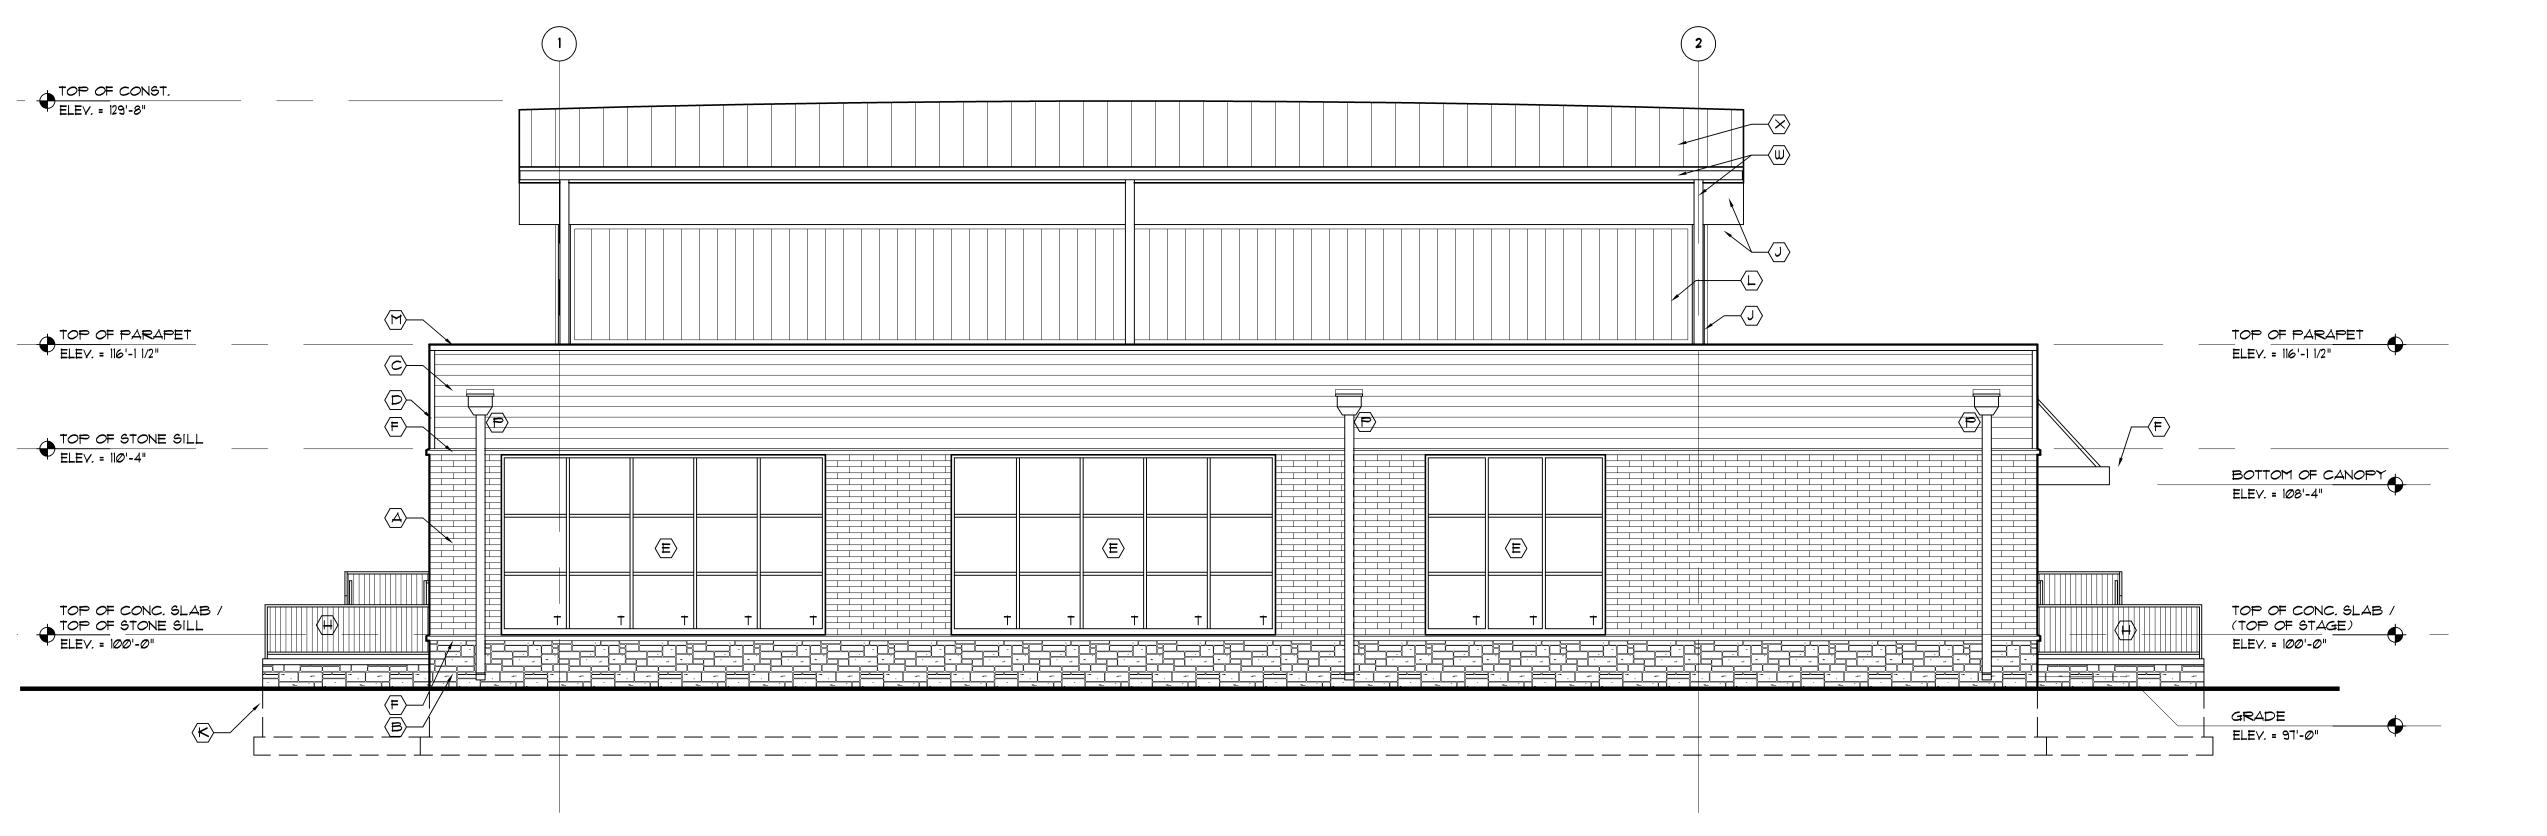



(B)

(3202) Left Side Elevation

A32 | Scale: 3/16" = 1'-0"

TOP OF PARAPET ELEV. = 116'-1 1/2"

TOP OF STONE SILL
ELEV. = 110'-4"

TOP OF CONC. SLAB /

TOP OF STONE SILL
ELEV. = 100'-0"

GRADE | ST'-0"

 $\triangle$ 




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6-7-17 City Review

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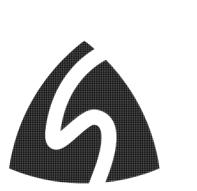
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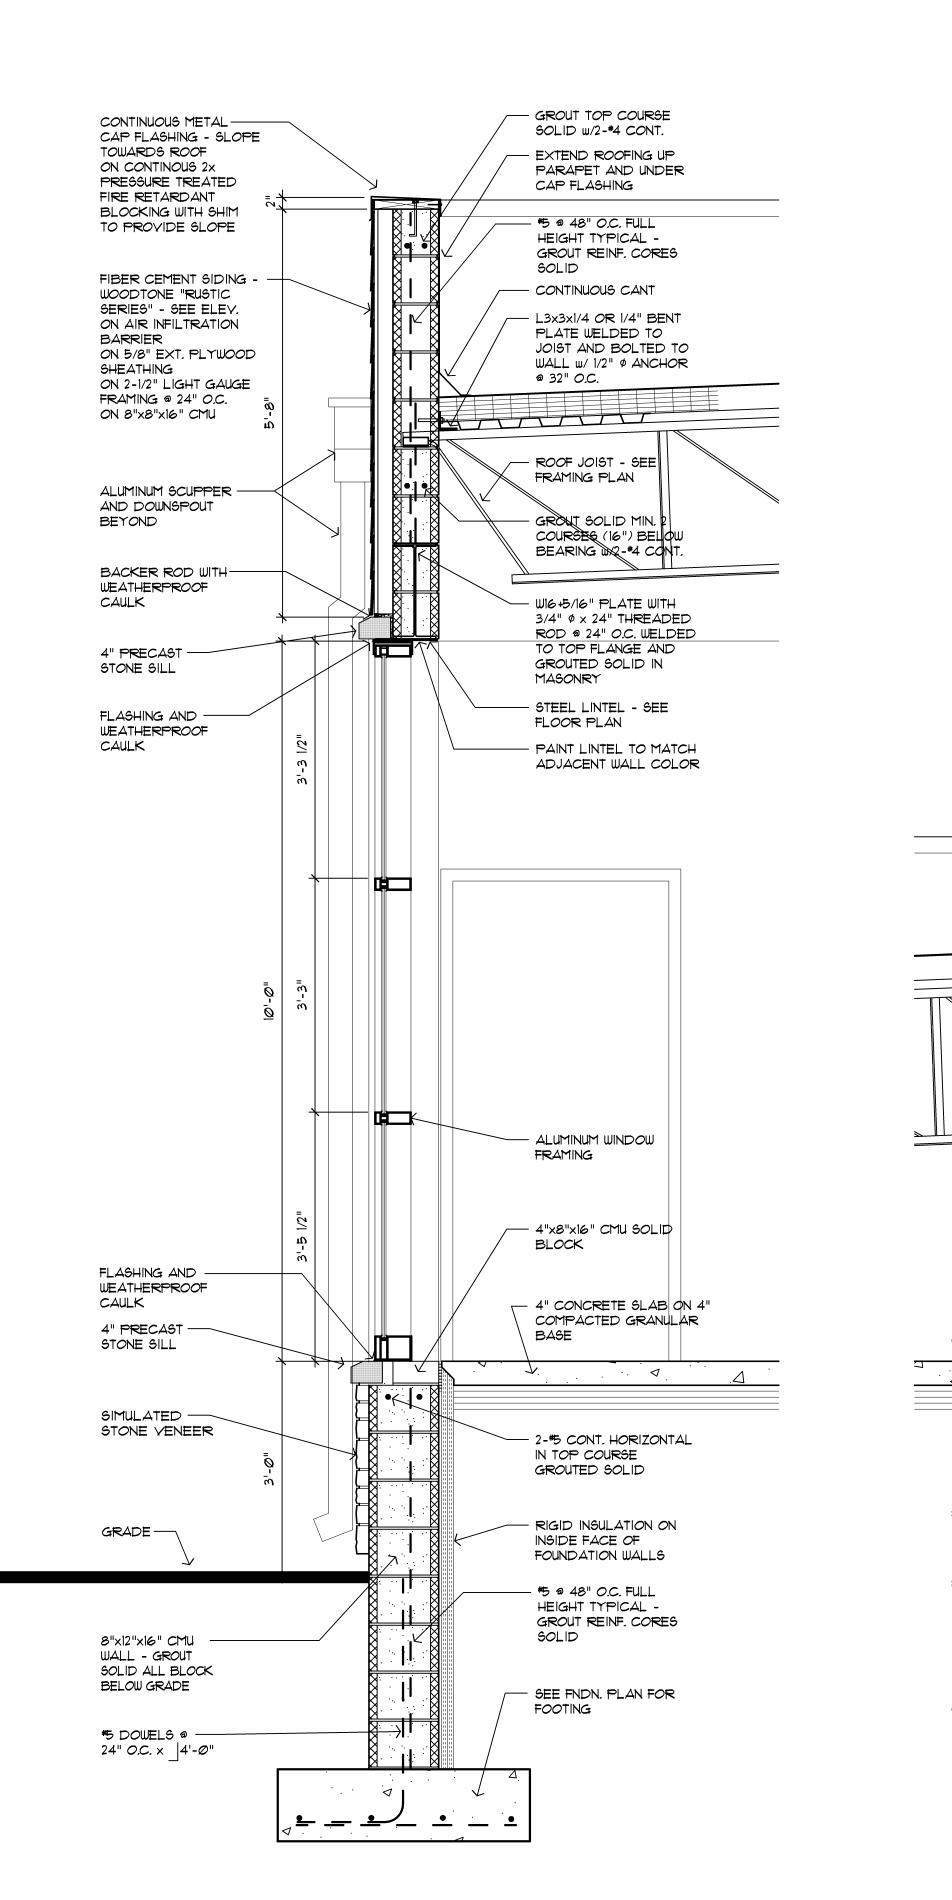
City of Sterling Heights
Dodge Park Improvemer
Sterling Heights, Michiga project

Amphitheater Building Sections sheet title




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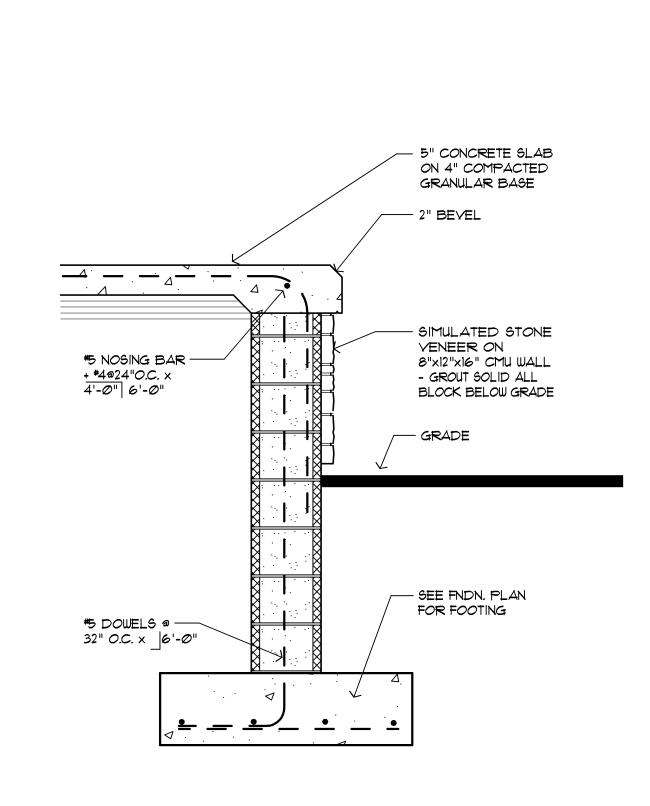
sheet no. job no. 16078A AMP-A4.1

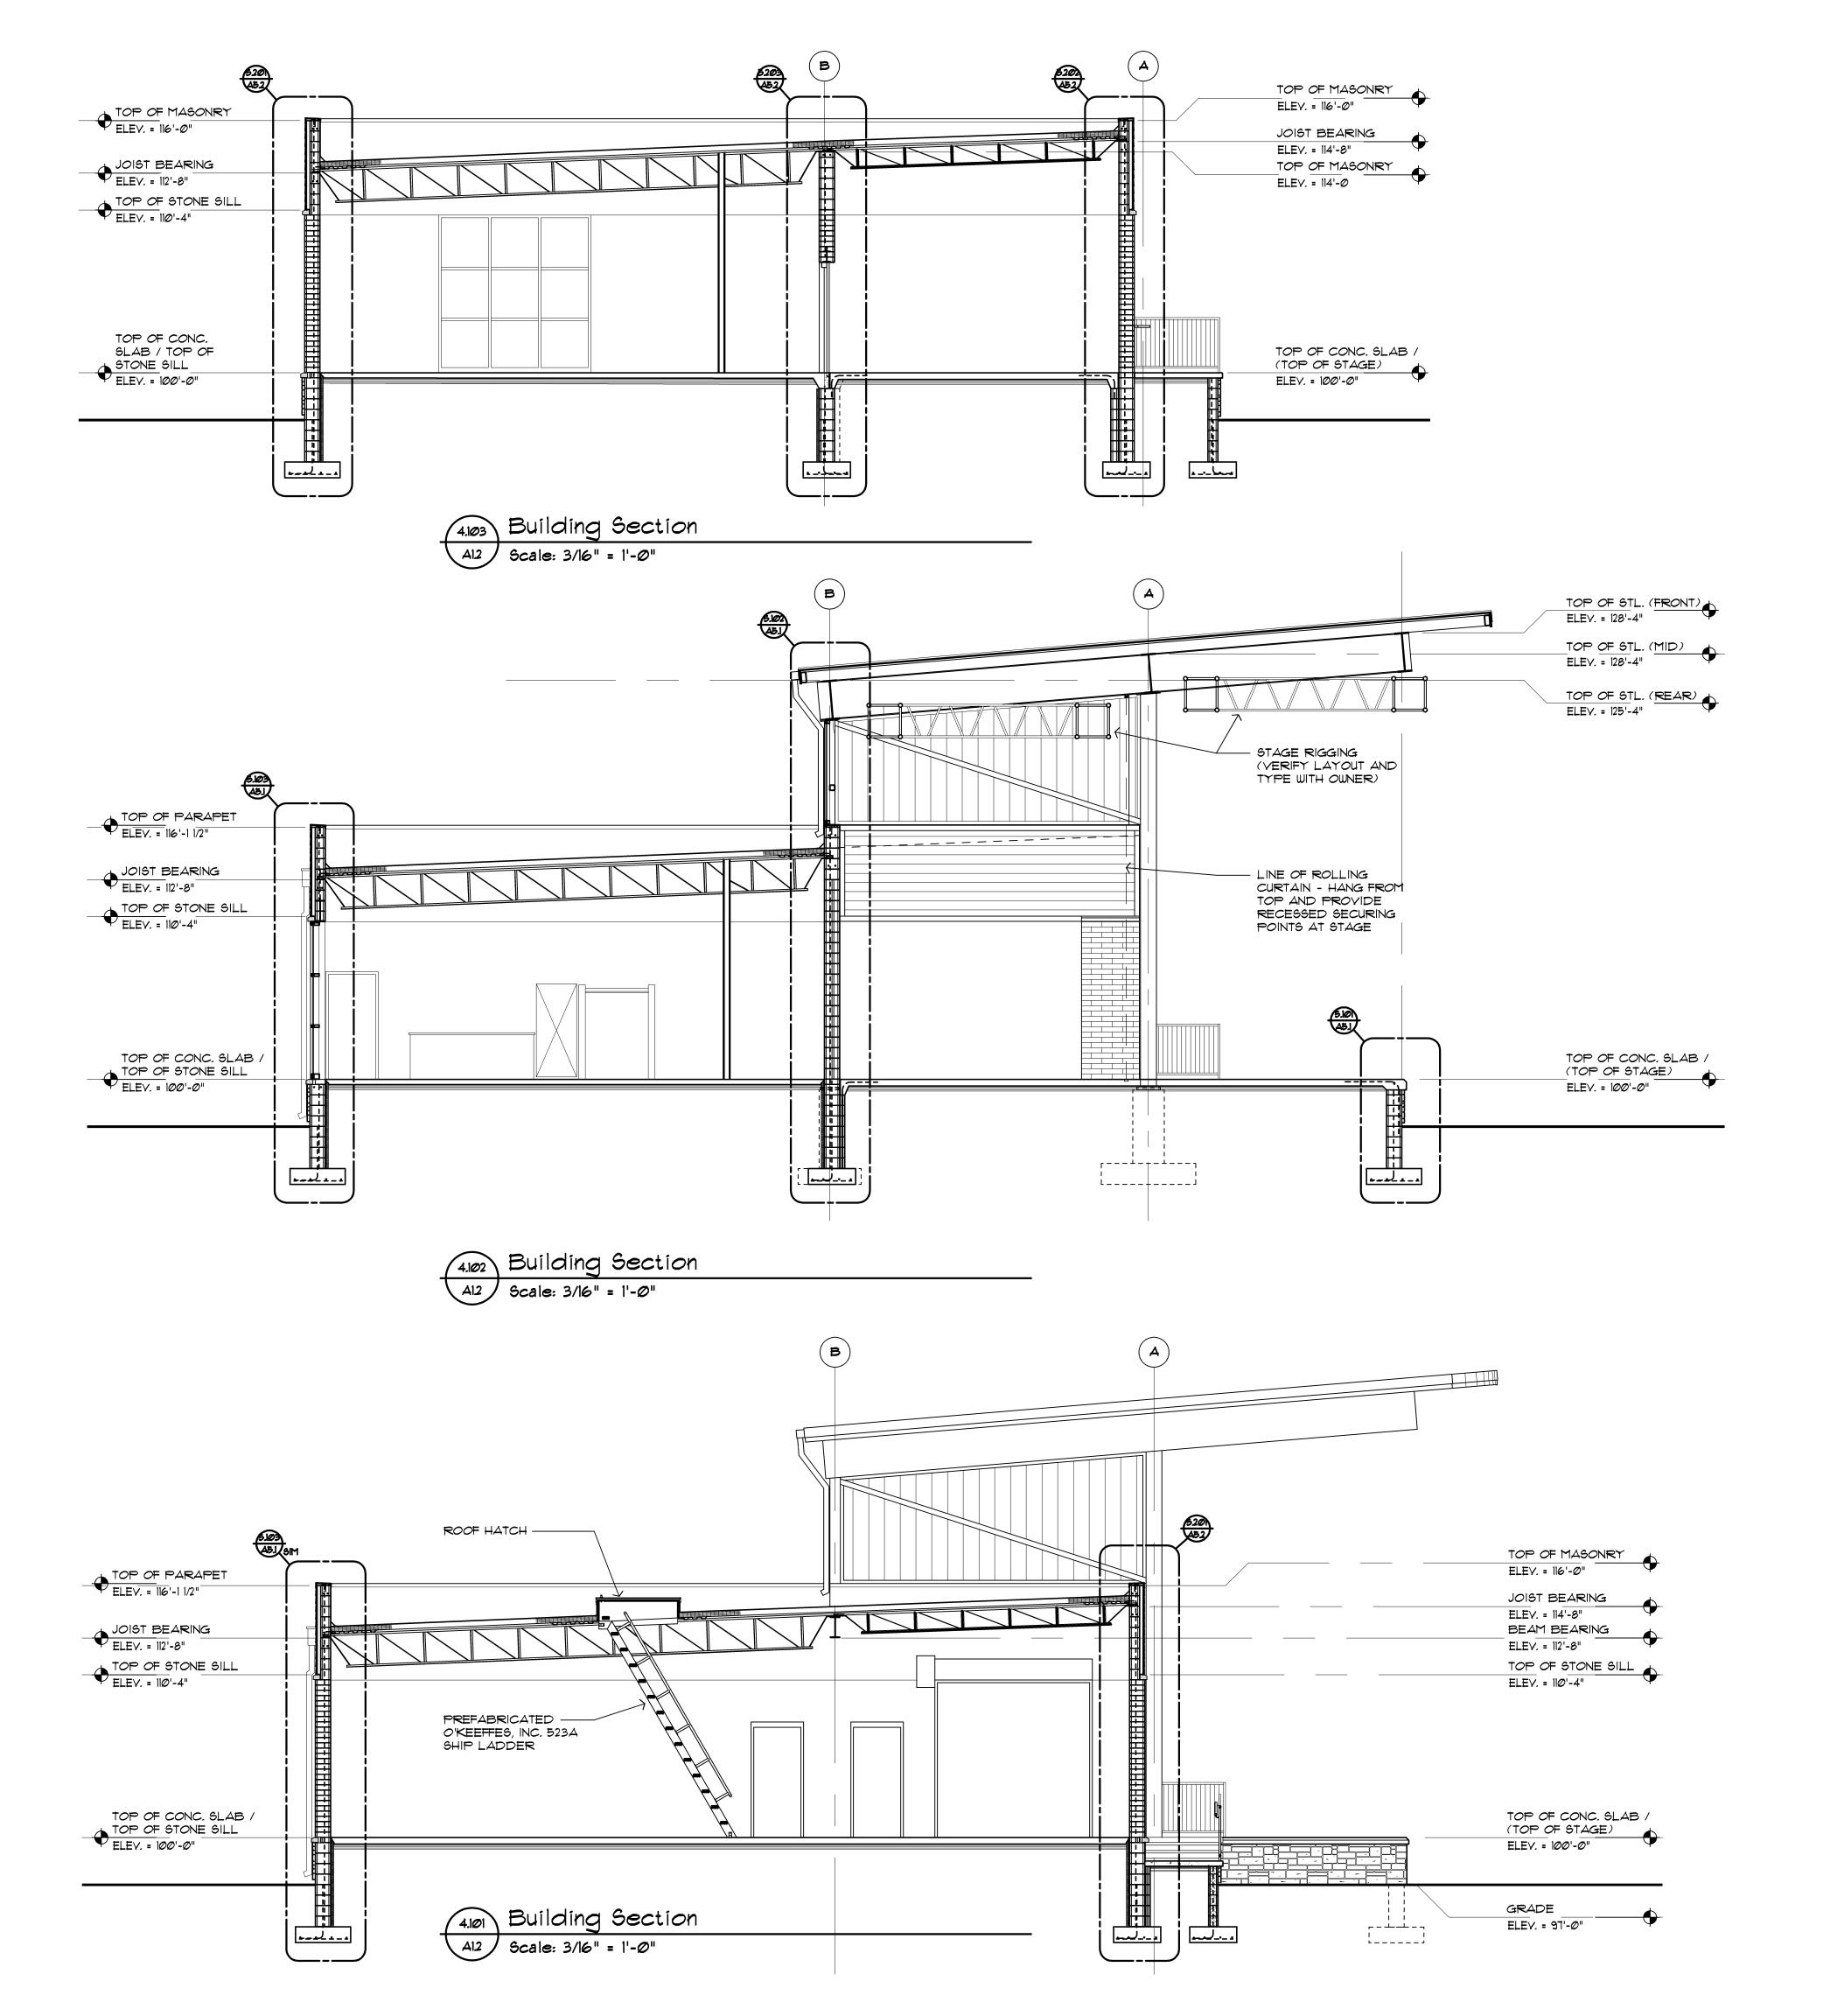

5.103 Wall Section at Rear

A4.1 Scale: 3/4" = 1'-0"



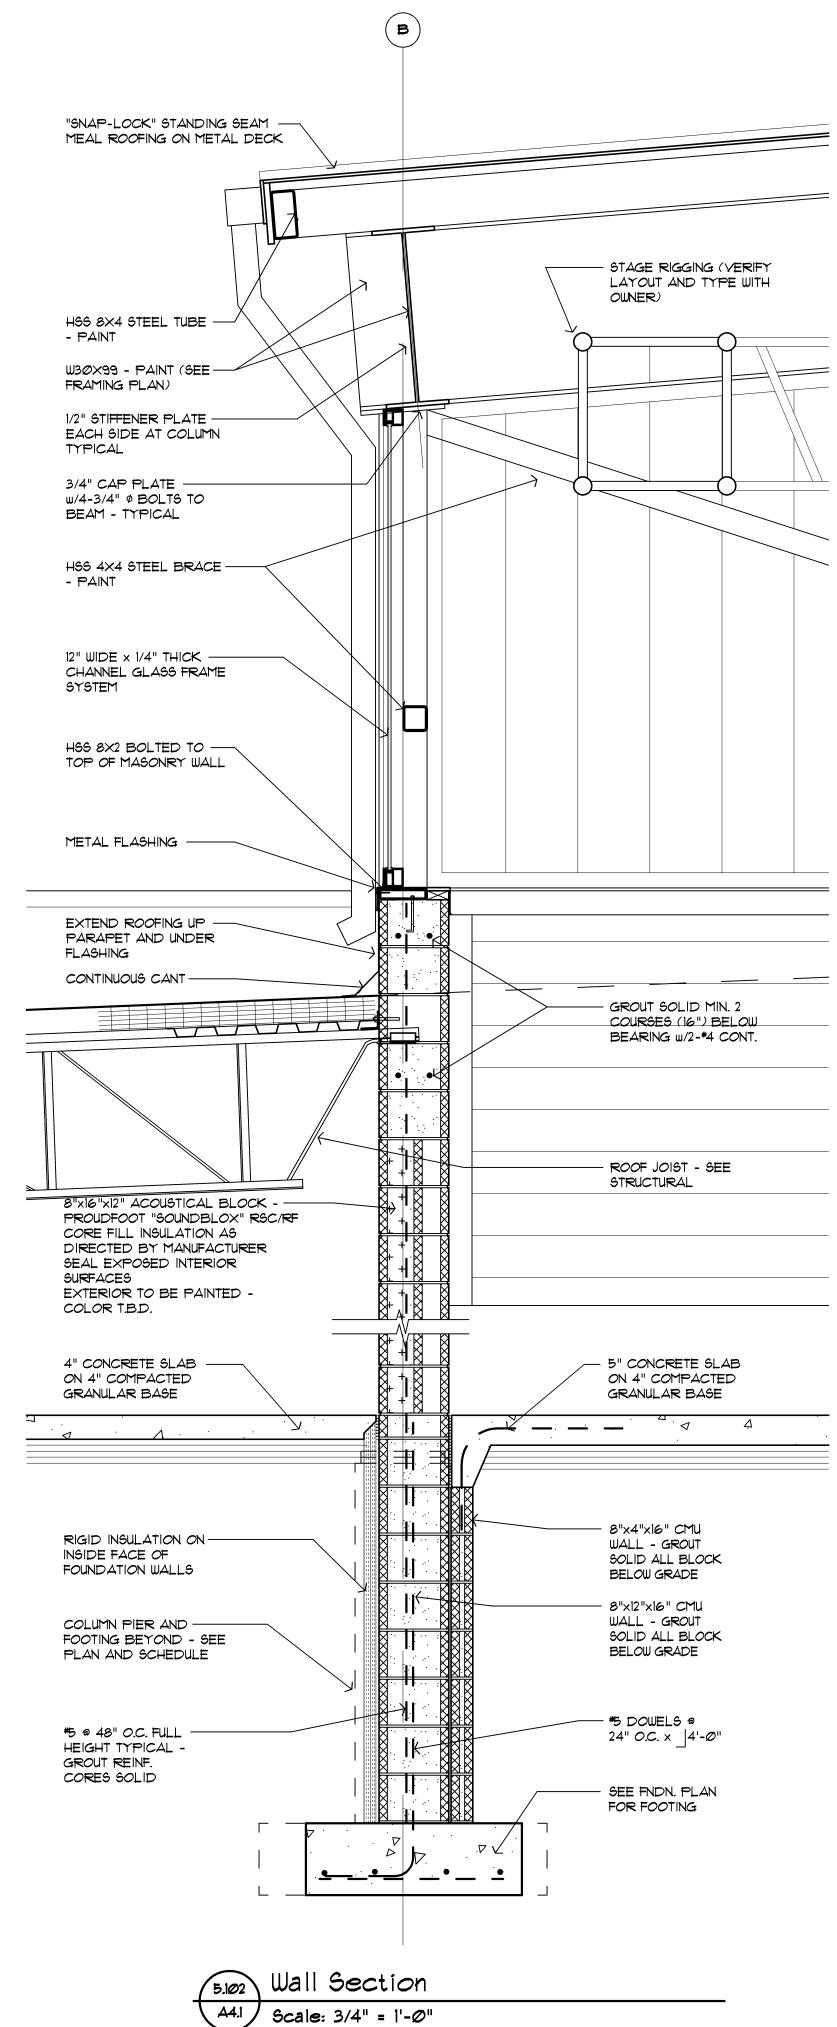

Wall Section at Stage / Stair

A4.1 Scale: 3/4" = 1'-0"

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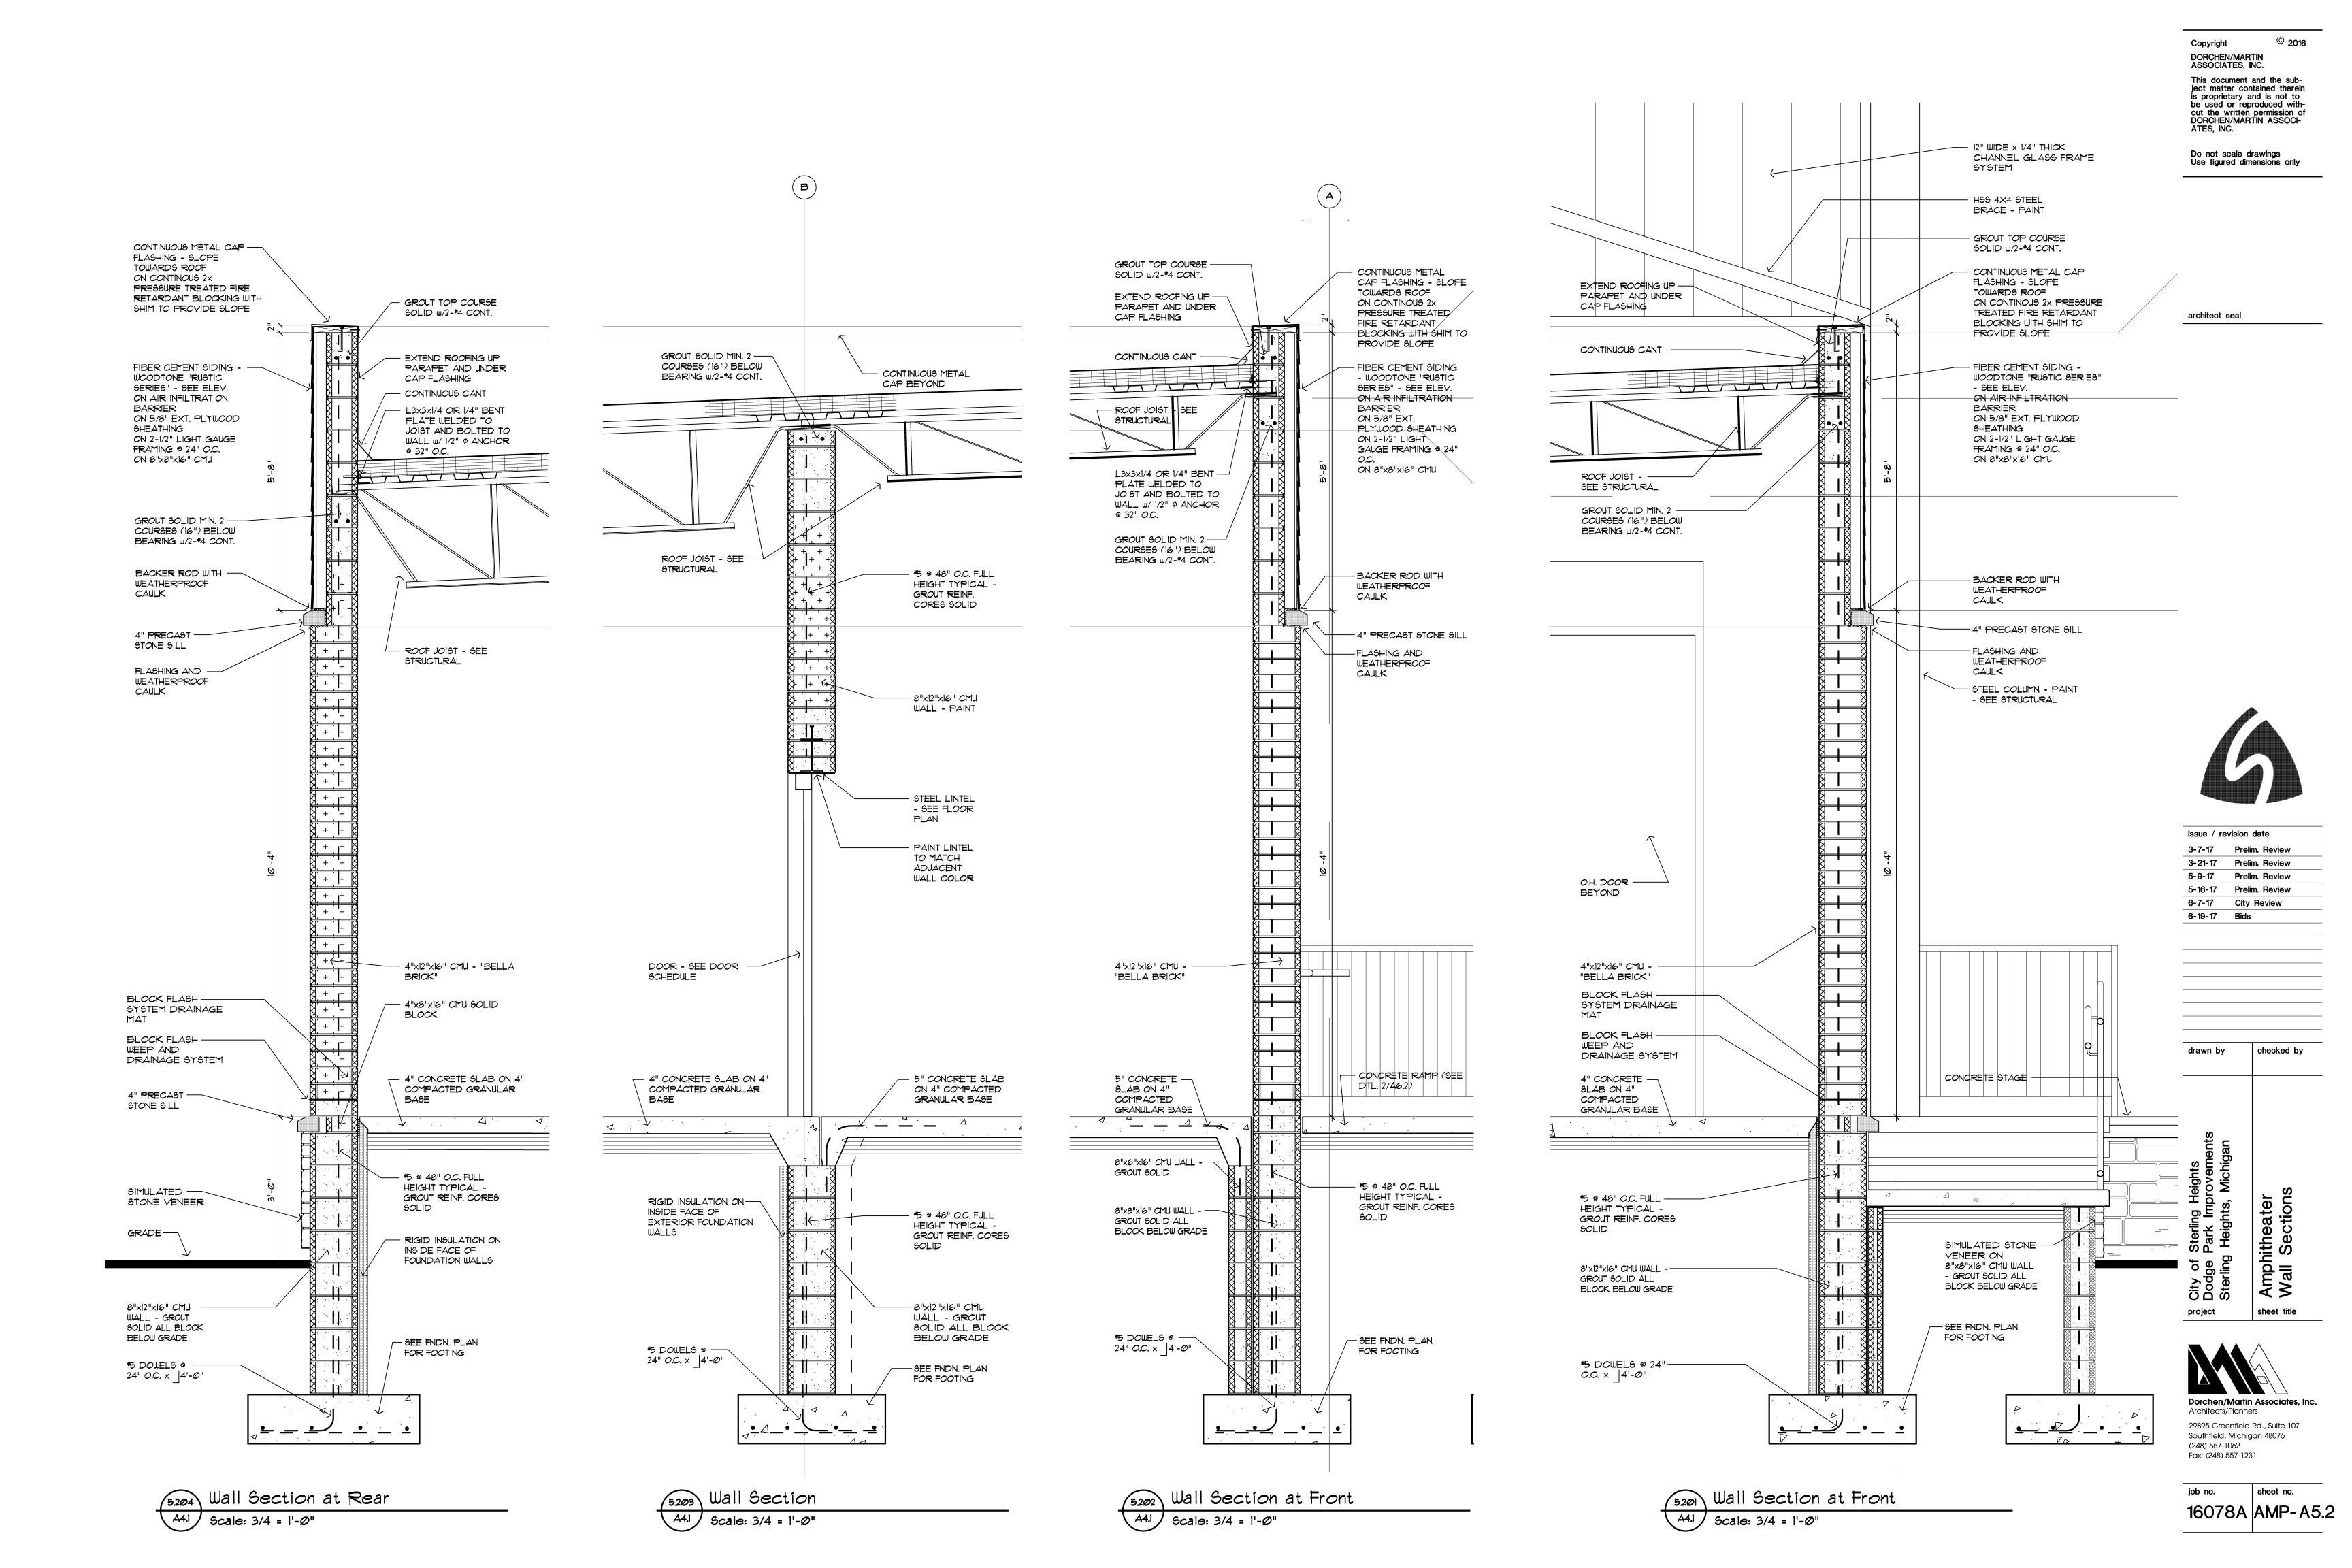
Dodge Park Improvements
Sterling Heights, Michigan

project sheet title

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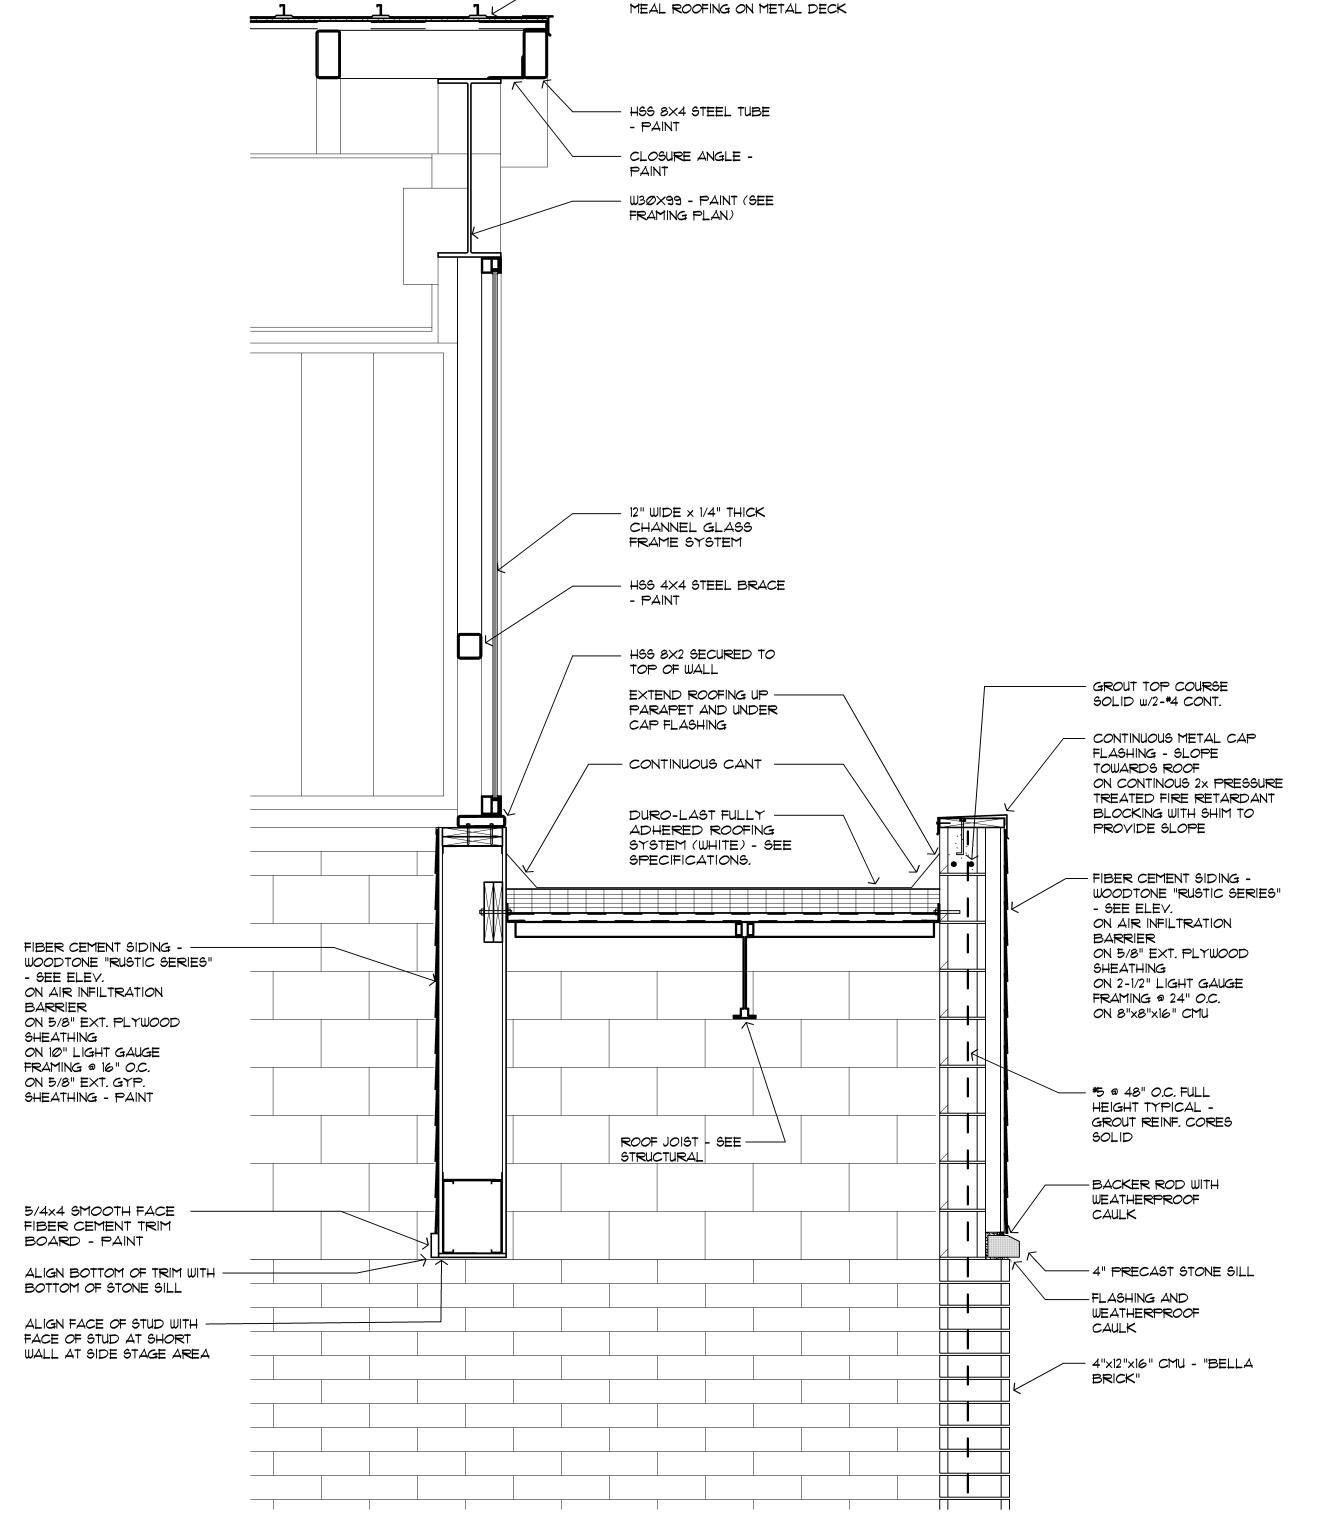
checked by

Amphitheater Wall Sections


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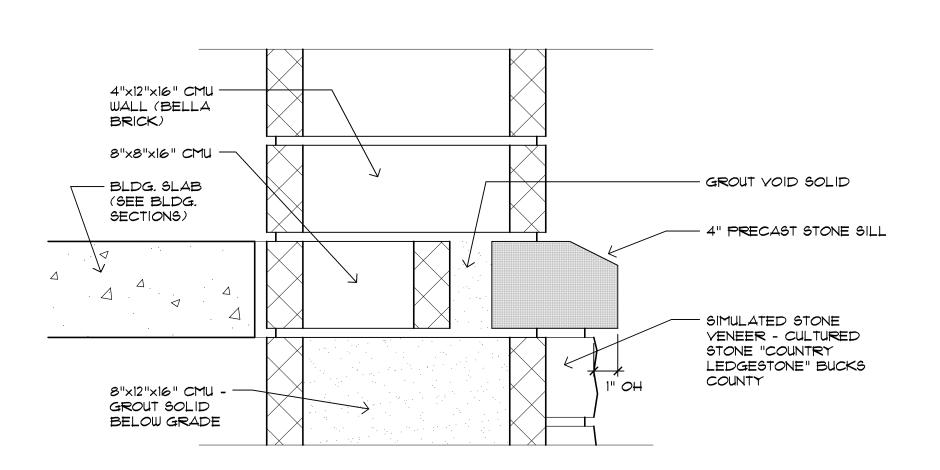


"SNAP-LOCK" STANDING SEAM






job no. sheet no. 16078A AMP-A5.3

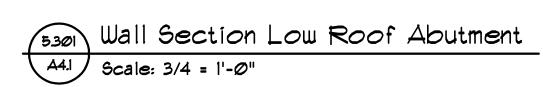


Stone Sill at Simulated Stone Veneer

A6.1 Scale: 3" = 1'-0"

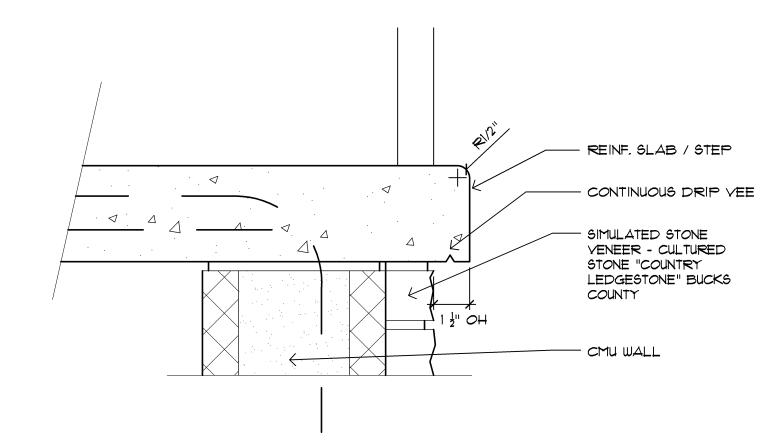


6.106 Slab Edge at Stone Veneer
A6.1 Scale: 3" = 1'-0"

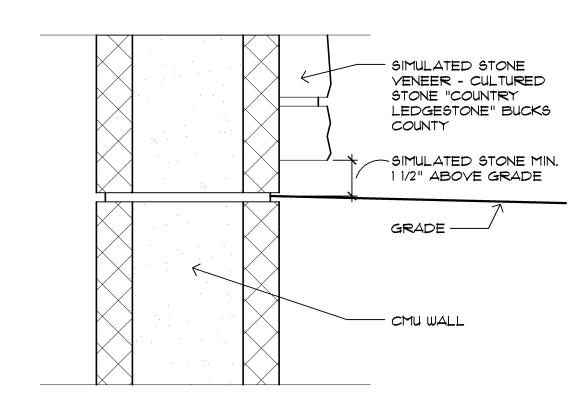


Slab Edge at Stone Veneer


A6.1 Scale: 3" = 1'-0"

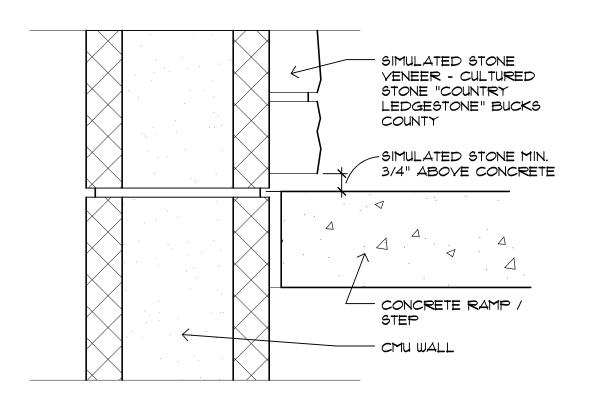


Slab Edge at Stone Veneer

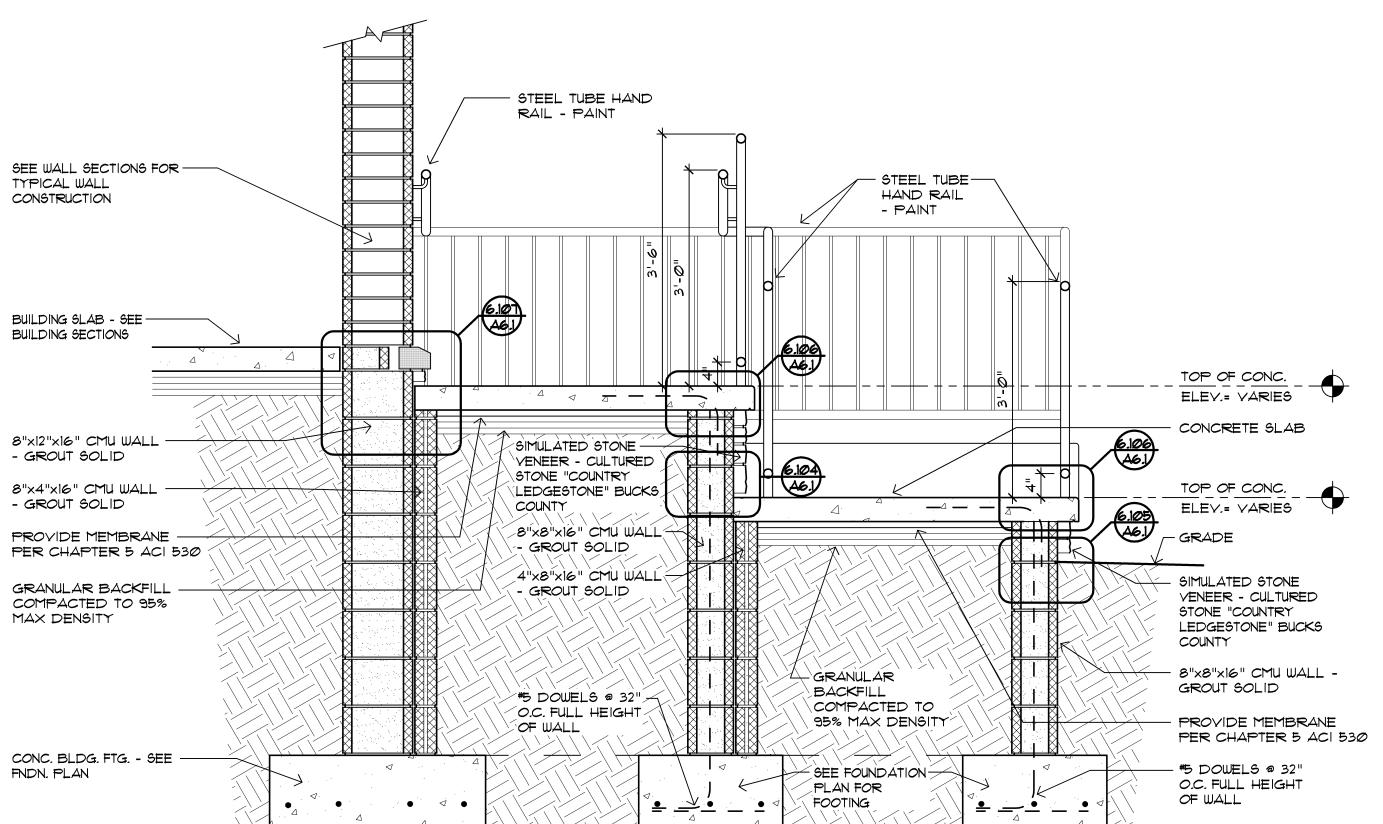

6.103 Ramp Section
A6.1 Scale: 3/4" = 1'-0"

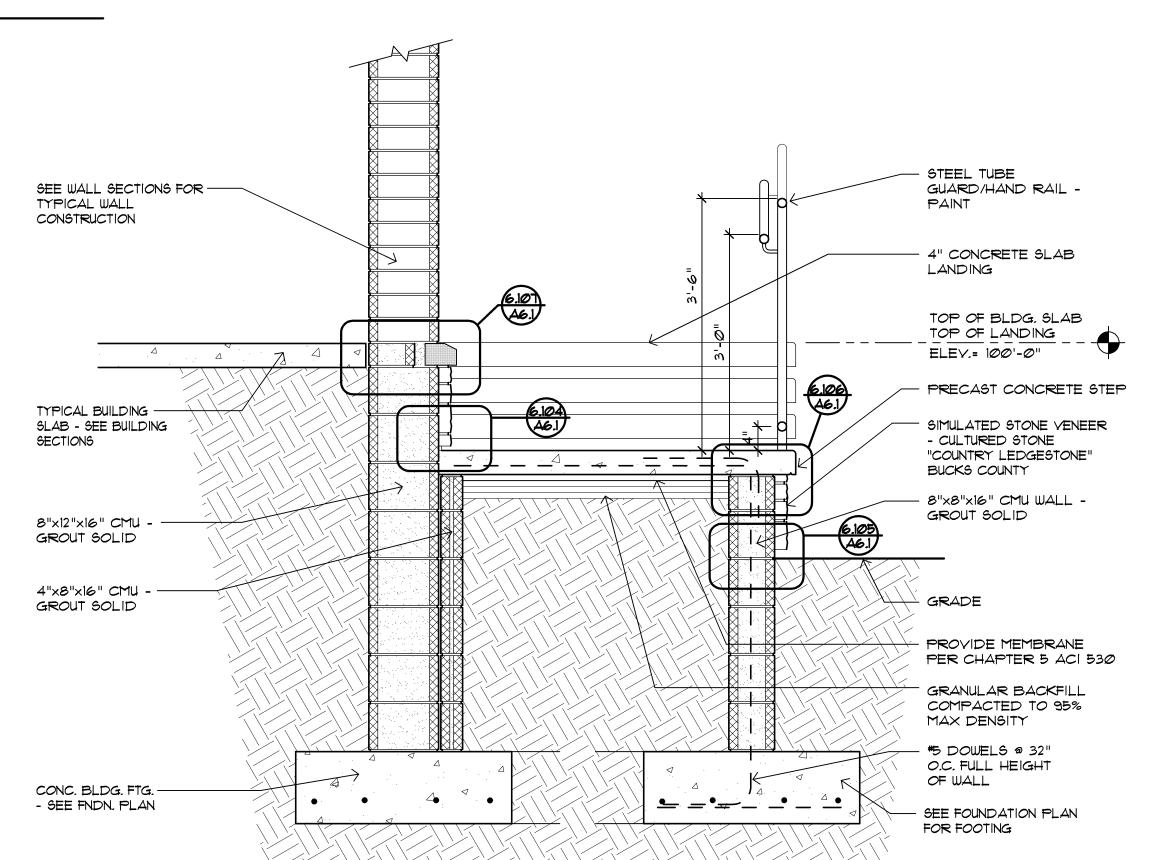



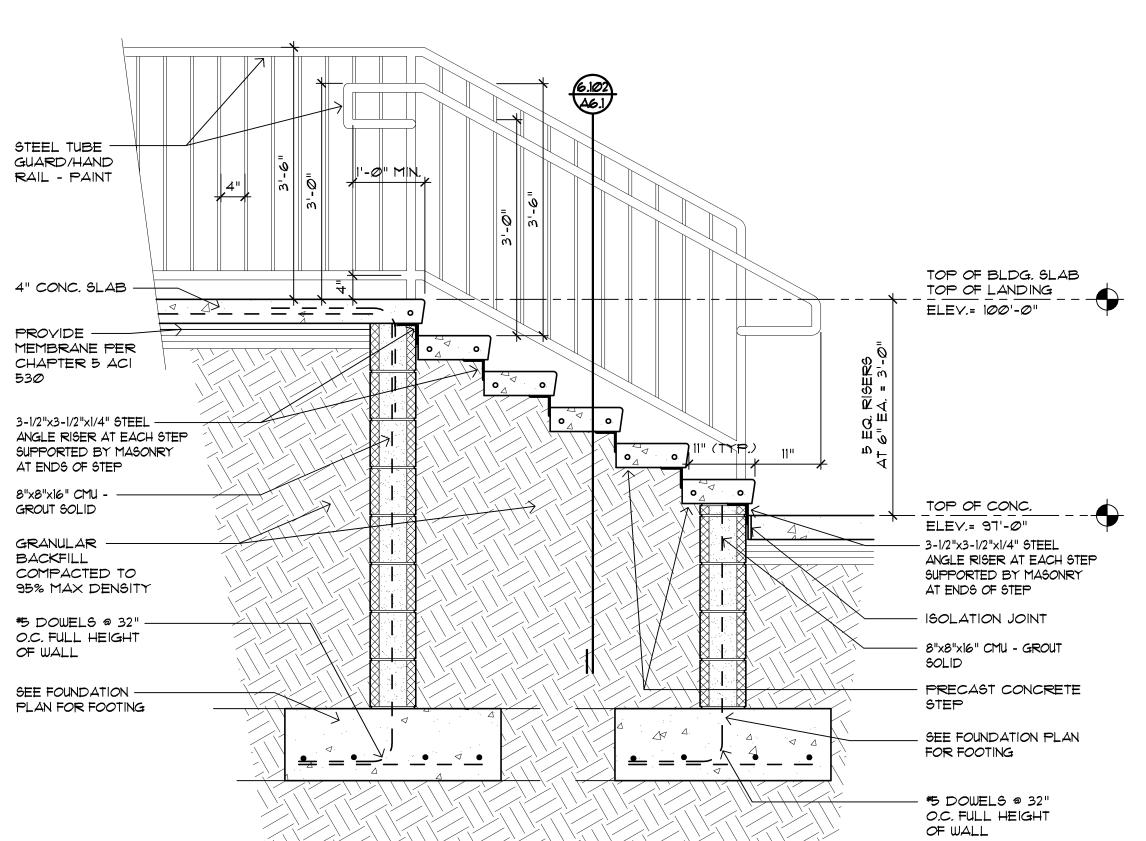

Loading/Staging Stair Section

A6.1 Scale: 3/4" = 1'-0"

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5-9-17	Prelim. Review
3-21-17	Prelim. Review

City of Sterling Heights
Dodge Park Improvements
Sterling Heights, Michigan
Amphitheater
Stair and Ramp Details

Dorchen/Martin Associates, Inc. Architects/Planners

29895 Greenfield Rd., Suite 107
Southfield, Michigan 48076


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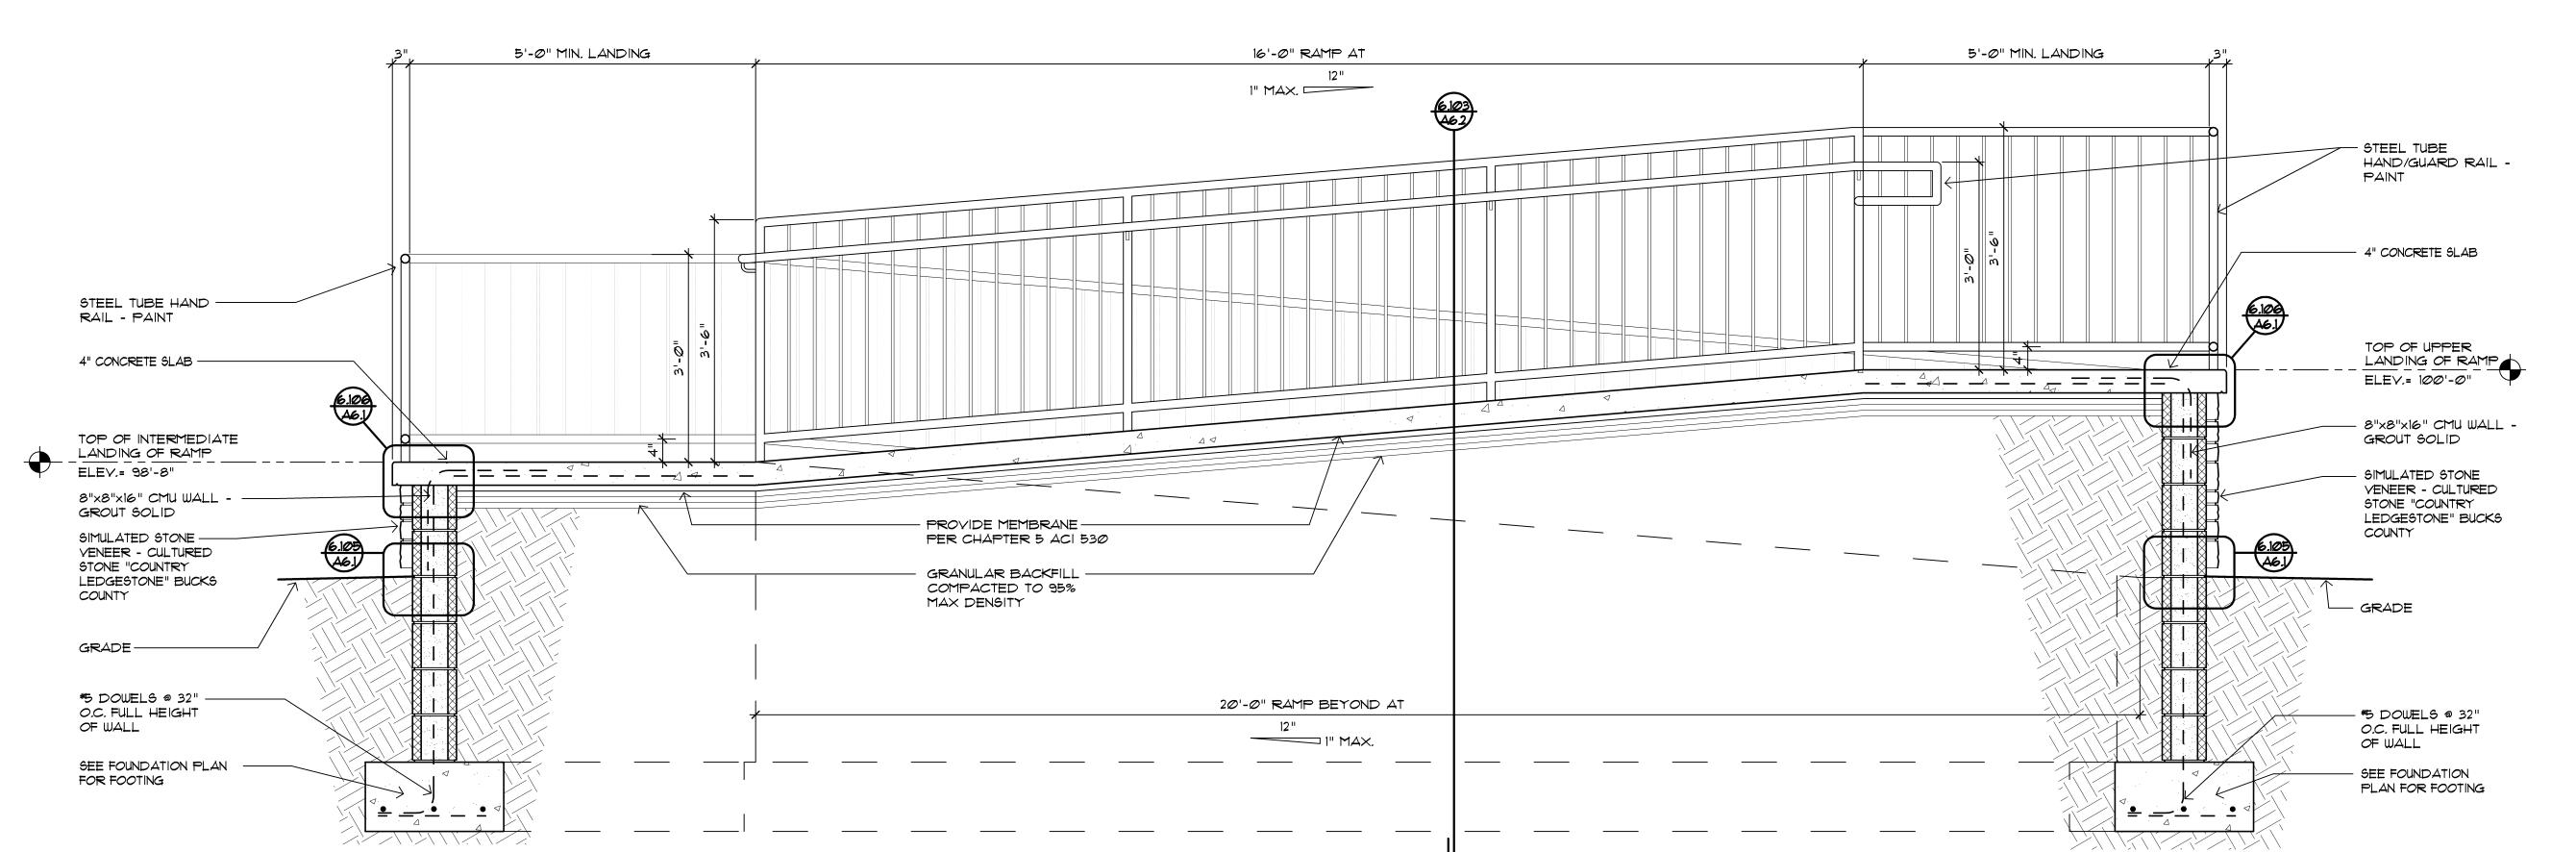
sheet title

project

job no. sheet no. 16078A AMP-A6.1





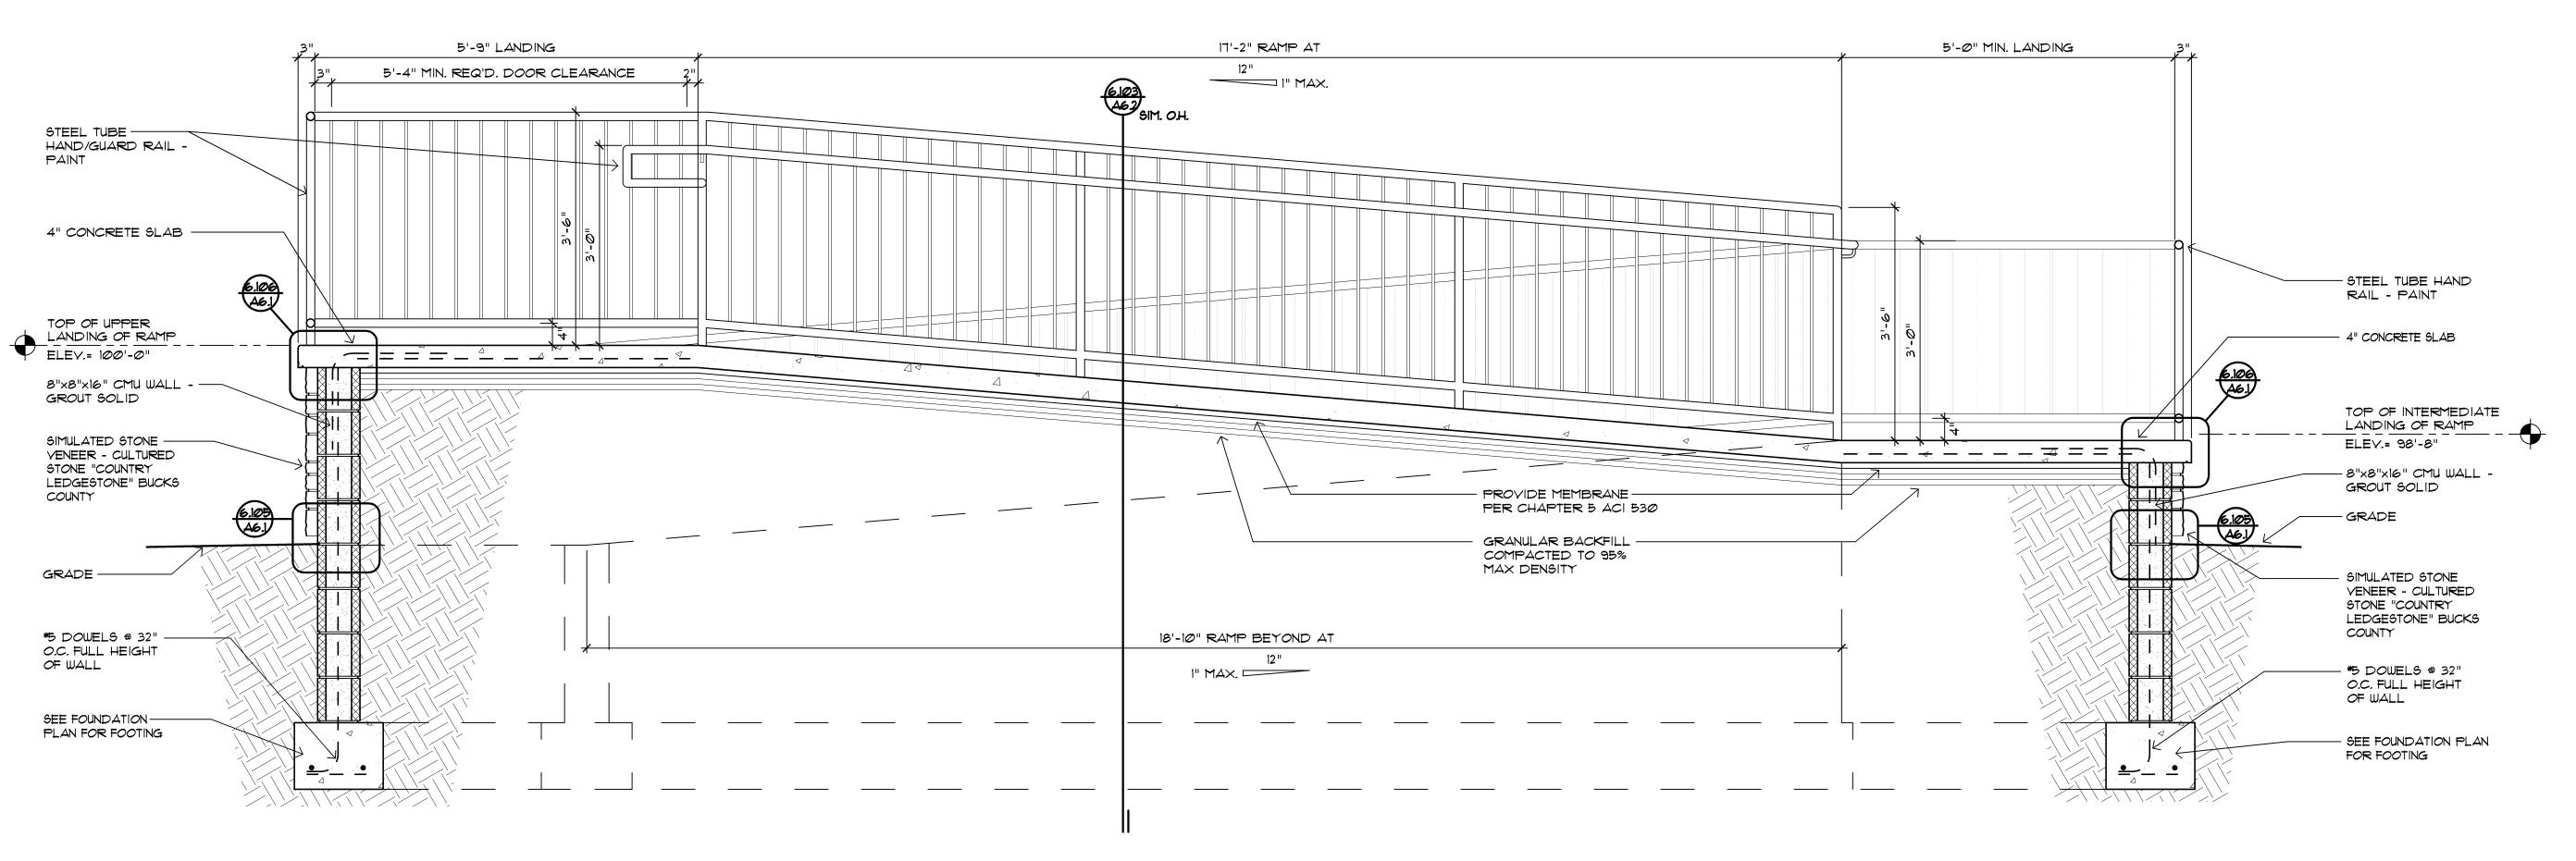



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5-16-17 Prelim. Review

6-7-17 City Review

6-19-17 Bids

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City of Sterling Heights
Dodge Park Improvements
Sterling Heights, Michigan
Amphitheater
Ramp Details

project sheet title

Dorchen/Martin Associates, Inc.

Architects/Planners 29895 Greenfield Rd., Suite 107 Southfield, Michigan 48076 (248) 557-1062 Fax: (248) 557-1231

job no. sheet no. 16078A AMP-A6.2

ROOM	ROOM	FLOOR	BASE	CEILING			WALLS				REMARKS
NO.	NAME			MTL.	HGT.	FINISH	N	E	S	W	
100	STAGE	CONC.	-	E.C.	VARIES	PT 6	MAS./PT 9	MAS./PT 9	MAS./PT 9	MAS./PT 9	
101	LOADING / STAGING	CONC.	-	E.C.	VARIES	PT 6	МДБ.	MAS.	МДБ.	MAS.	
102	STORAGE	CONC.	-	E.C.	VARIES	PT-6	MAS.	МДЭ.	MAS.	MAS.	
103	UNISEX TOILET ROOM	C.T 1	C.T 2	GYP. BD.	8'-0"	PT 4	GYP./PT 2 C.T 2 & 3	GYP/PT 2 C.T 2 & 3	GYP./PT 2 C.T 2 & 4	GYP./PT 2 C.T 2 \$ 3	
104	STAFF BREAK ROOM	CPT 1 C.T 1	C.T 1 R.B 1	E.C. / ACC GYP. BD.	VARIES 8'-0"	PT 4 PT 4	GYP/PT 1	GYP./PT 1 MAS.	МДБ.	GYP./PT 1	SEE PLAN FOR FLOORING TRANSITIONS
105	UTILITY	CONC.	R.B 2	GYP. BD.	8'-Ø"	PT 4	GYP./PT 1	GYP./PT 1	GYP/PT 1	GYP./PT 1	
106	GREEN ROOM #1	CPT, - 1 C.T 1	C.T 1 RB 1	E.C. / ACC GYP. BD.	VARIES 8'-Ø"	PT 6 PT 4	GYP./PT 1	GYP./PT 1	GYP./PT 1 MAS.	GYP./PT 1	SEE PLAN FOR FLOORING TRANSITIONS
107	TOILET ROOM #	C.T 1	C.T 2	GYP. BD.	8'-0"	PT 4	GYP./PT 2 C.T 2 & 4	GYP./PT 2 C.T 2 \$ 3	GYP./PT 2 C.T 2 & 3	GYP./PT 2 C.T 2 & 3	
108	OFFICE	CPT 1	R.B 2	GYP. BD.	8'-0"	PT 4	GYP./PT 1	GYP./PT 1	GYP./PT 1	GYP/PT I	
109	TOILET ROOM #2	C.T 1	C.T 2	GYP. BD.	8'-0"	PT 4	GYP./PT 2 C.T 2 & 4	GYP/PT 2 C.T 2 & 3	GYP./PT 2 C.T 2 & 3	GYP./PT 2 C.T 2 & 3	
1100	GREEN ROOM #2	CPT 1 C.T 1	C.T 1 R.B 1	E.C. / ACC GYP. BD.	VARIES 8'-0"	PT 6 PT 4	GYP./PT 1	GYP./PT 1	MAS.	MAS.	SEE PLAN FOR FLOORING TRANSITIONS
111	CORRIDOR	CPT 2	R.B 2	E.C.	VARIES	PT 6	MAS.	MAS.	MAS.	GYP./PT 1 W.P 1	

# MATERIAL KEY

- = ACOUSTIC CEILING TILE
- ACC = ACOUSTIC CEILING CANOPY
- AL/GL. = ALUMINUM & GLASS
- CAB.
- = CABINETRY
- CONC. = CONCRETE
- CPT. = CARPET C.T. = CERAMIC TILE
- C.T.B. = CERAMIC TILE BASE
- E.C. = EXPOSED CONSTRUCTION
- EPNT. = EPOXY PAINT FWC.
- = FABRIC WALL COVERING G.B. = GYPSUM BOARD
- MAS. = MASONRY
- PFKD = PRE-FIN. METAL KNOCK DOWN FRAME
- P. LAM. = PLASTIC LAMINATE
- PT. = PAINT PRE-FIN. = PRE-FINISHED
- = RUBBER BASE WD. = STAINED WOOD
- V.B. = VINYL BASE
- YCT. = VINYL COMPOSITION TILE ∨SF = VINYL SHEET FLOORING YWC.
  - = VINYL WALL COVERING = WALL PROTECTION

# GENERAL REMARKS

- 1. FLOOR MATERIAL CHANGES OCCUR AT CENTERLINE OF DOOR.
- 2. ACCESS PANELS, ELECTRICAL PANELS, HYAC REGISTERS & FIRE EXTINGUISHER CABINETS SHALL BE PRE-FINISHED OR PAINTED TO MATCH ADJACENT WALLS OR
- CEILINGS. 3. ALL DOOR & WINDOW FRAMES TO RECEIVE A CONTINUOUS BEAD OF SEALANT AT ALL PERIMETER EDGES.
- 4. ALL EXPOSED STEEL SHALL BE PAINTED.
- 5. REFER TO REFLECTED CEILING PLANS AND SECTIONS WHERE CEILING HEIGHT VARIES.
- 6. ALL GYPSUM BOARD SOFFITS SHALL BE
- PAINTED.
- ROOMS 104, 106, 110 USE CT-1 BASE ON CT-1 FLOORING & USE RB-1 BASE ON CPT-1. ALL BASE TRANSITIONS TO OCCUR AT INTERIOR CORNERS.



# ABBREVIATIONS

- AL./GL. = ALUMINUM & GLASS
- = ALUMINUM CANOD. = CLEAR ANODIZED
- = BI-FOLD
- = HOLLOW METAL
- = HOLLOW METAL KNOCK DOWN = GLASS
- MANF.
- = BY MANUFACTURER = OVERHEAD DOOR
- = PRE-FIN. METAL KNOCK DOWN FRAME
- = PLASTIC LAMINATE
- PRE-FIN. = PRE-FINISHED

SCHED.

(A)

- = STEEL
- = STAIN & VARNISH (FIELD FINISHED) = WOOD, SOLID CORE

SCHED.

(B)

# CODED REMARKS


- CLOSER
- 2. SAFETY GLASS VISION LITE
- 3. SAFETY GLASS SIDE LITE 4. VINYL CARPET TO TILE JOINER
- 5. METAL THRESHOLD
- 6. MARBLE THRESHOLD
- 7. VINYL REDUCING STRIP 8. TERRAZZO STRIP
- 9. GROUT FILLED FRAME
- 10. LIMIT DOOR TO 90° SWING DOOR TO OPEN 135°
- 12. PUSH / PULL
- 13. WALL MOUNTED DOOR STOP
- 14. WEATHER STRIPPING
- 15. KICK DOWN DOOR STOP
- 16. UNDERCUT DOOR I"


# 17. SUITE STYLE DOOR

# JJ SEE SCHED.


# DOOR TYPES

NO SCALE

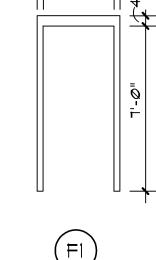


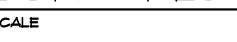

NO SCALE

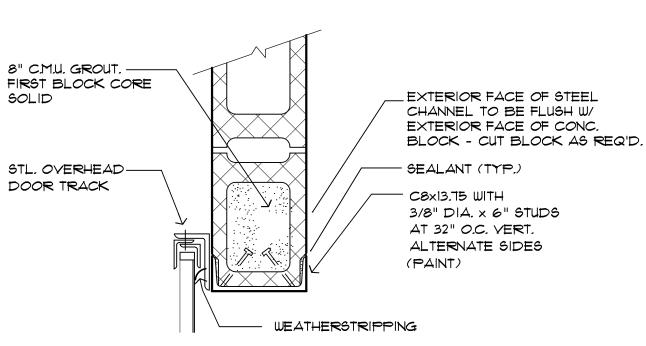



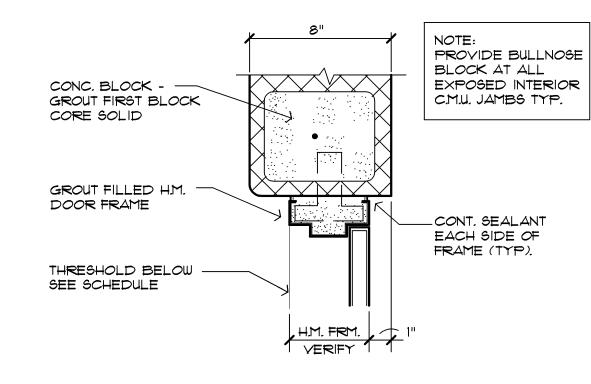

GENERAL DOOR & FRAME NOTES


1. ALL DOOR FRAMES ARE TO RECEIVE CONTINUOUS BEAD

OF SEALANT AT PERIMETER - BOTH SIDES.

3. ALL H.M. DOORS TO BE GALVANIZED, PAINTED

2. ALL H.M. FRAMES SHALL BE GROUT FILLED.

JAMB DETAIL SCALE: 1 1/2" = 1'-@"

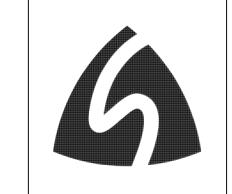

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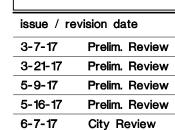
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Amphitheater Room and Dc



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sheet no. 16078A AMP-A7.1



THRESHOLD DETAIL SCALE: 3" = 1'-0"

ALUM./GLASS DOOR

OR H.M. DOOR (SEE

DOOR SCHEDULE) -

EXTERIOR FIN. SLAB -

INTERIOR FIN. ELEV.

ELEY. 1/2" BELOW




DBL. METAL STUDS STRAP

TOGETHER


NOTE: FOR WALL TYPE SEE WALL TYPE SHCHED. SHEET A200

			PLUN	/BINC	3 FIX	(TUR	E SCHEDULE	
TAG	BARRIER FREE	ITEM		PE CONNE			MANUFACTURER & MODEL NO.	ACCESSORIES
	TIVEL		WASTE	VENT	CW	HW	& WODEL NO.	
FD-1	-	FLOOR DRAIN	3"	1 1/2"	_	_	ZURN: Z-415-B	
LAV-1	Y	INTERNAL BOWL LAVATORY	1 1/2"	1 1/2"	1/2"	1/2"	CORIAN 810	FAUCET: KOHLER: PURIST: MODEL #K-14410-4-CP. PROVIDE ASSE 1070 MIXING VALVE.
SK-1	Г	UNDERMOUNT	2"	1 1/2"	1/2"	1/2"	_	FAUCET: KOHLER PURIST; MODEL# K-7505-CP. GARBAGE DISPOSAL: INSINKERATOR BADGER 5, 1/2 HP
SS-1	-	SERVICE SINK	3"	1 1/2"	3/4"	3/4"	FIAT: MSB-2424	FAUCET: FIAT # 830-AA W/VACUUM BREAKER, STAINLESS STEEL GRID STRAINER, PAIL HOOK AND HOSE THREAD, HOSE AND MOP HANGERS.
WC-1	Y	FLOOR MOUNTED WATER CLOSET	4"	2"	1"	_	- AMERICAN STANDARD: CADET 3: 270CA.001	- TOILET SEAT & LID

- 1. SUPPLY ALL FIXTURES WITH LOOSE KEY STOPS.
- 2. PROVIDE ALL ACCESSORIES NECESSARY FOR COMPLETE AND OPERABLE INSTALLATION.
- 3. PROVIDE CARRIERS FOR ALL FIXTURES PER MANUFACTURER'S RECOMMENDATIONS.
- 4. WHERE REQUIRED AND WHERE DESIGNATED, FIXTURES SHALL BE FURNISHED AND INSTALLED IN ACCORDANCE TO THE LATEST EDITION OF "THE BARRIER" FREE DESIGN REQUIREMENTS OF THE STATES CONSTRUCTION CODE.
- 5. REFER TO ARCHITECTURAL ELEVATIONS FOR EXACT LOCATION/MOUNTING HEIGHT OF ALL FIXTURES.

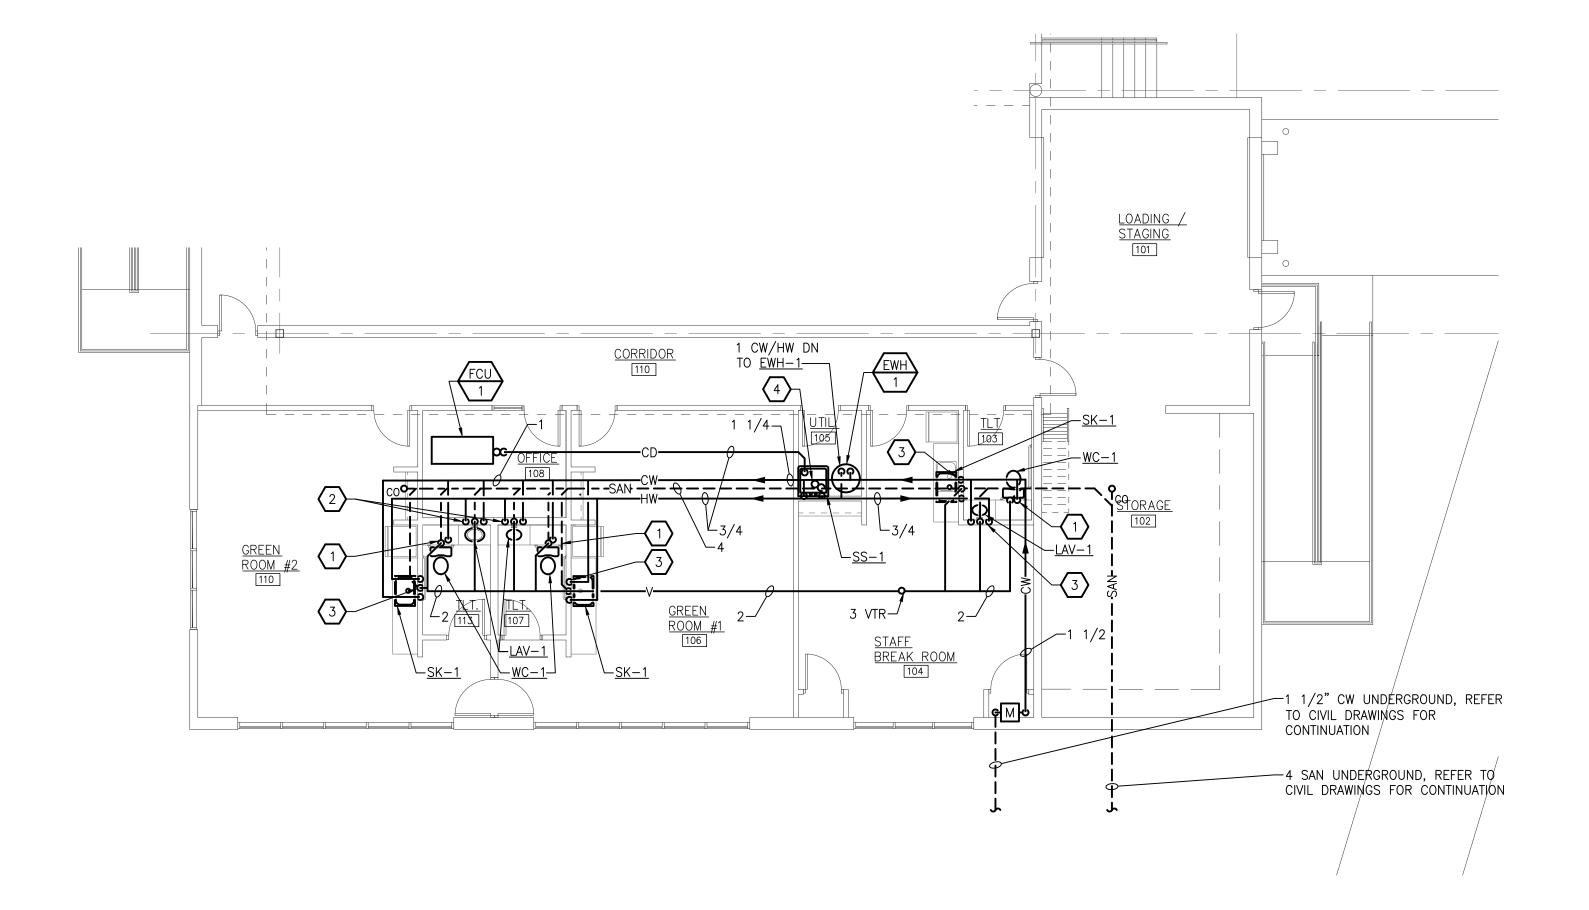



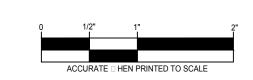

# MECHANICAL GENERAL NOTES

1. THESE DRAWINGS ARE DIAGRAMMATIC & INDICATE THE GENERAL EXTENT OF THE WORK. PROVIDE PLUMBING AND HVAC SYSTEMS COMPLETE PER SPECIFICATION, SMACNA STANDARDS, AND PER APPLICABLE CODES INCLUDING ALL NECESSARY OFFSETS, FITTINGS, SPECIAL RADIUS OR MITERED ELBOWS WHICH ARE REQUIRED DUE TO SPACE CONSTRAINTS OR OTHER STRUCTURAL CONDITIONS.

DOMESTIC - ATER HEATER ELECTRIC SCHEDULE

60

2. 9 KW HEATER IS ACHIEVED THROUGH TWO SIMULTANEOUSLY OPERATING 4.5 KW HEATING ELEMENTS.

HERTZ KW INPUT

MODEL NO.

LE240S3-3

REMARKS

UNIT ID CAPACITY

EWH-1

NOTES:

(GAL)

40

VOLTS

208

1. MODEL NUMBERS ARE LOCHINVAR UNLESS OTHERWISE NOTED.

PHASE

- 2. CONTRACTOR SHALL COORDINATE HIS WORK WITH THE WORK OF ALL OTHER TRADES. VERIFY ALL CLEARANCES PRIOR TO THE FABRICATION OF ANY WORK.
- EQUIPMENT. DUCTWORK/PIPING SHALL NOT INTERFERE WITH ELECTRICAL EQUIPMENT CLEARANCE.
- 4. THE CONTRACTOR SHALL PROVIDE ALL MISCELLANEOUS SUPPORTING STEEL,
- 5. REFER TO ARCHITECTURAL PLANS FOR SPECIFICATIONS AND EXACT LOCATIONS OF FIXTURES (STANDARD AND BARRIER FREE), SINKS, ETC.
- 7. PIPING/DUCTWORK SHALL NOT BE LOCATED OVER ELECTRICAL EQUIPMENT/ PANELS. PROVIDE REQUIRED CLEARANCE IN FRONT/ABOVE OF ELECTRICAL EQUIPMENT. PIPING SHALL NOT INTERFERE WITH ELECTRICAL EQUIPMENT CLEARANCE.
- 8. PIPING SHALL NOT BE INSTALLED IN A LOCATION THAT RESTRICTS THE ACCESS
- 9. HOT AND COLD WATER PIPING RUN-OUTS TO LAVS AND SINKS SHALL BE 3/4" UNLESS NOTED OTHERWISE. REFER TO PLUMBING FIXTURE SCHEDULE FOR CONNECTION SIZES. PROVIDE BRANCH LINE ISOLATION VALVES ON DOMESTIC PIPING TO EACH GROUP OF FIXTURES AND TOILET ROOMS. PROVIDE FULL OPEN VALVES PER PLUMBING CODE.
- 10. PROVIDE CODE REQUIRED CLEARANCE/ACCESS DOORS FOR DAMPERS, VALVES, AND CLEANOUTS LOCATED IN WALLS OR ABOVE HARD CEILINGS, AND LOCATIONS OF CLEANOUTS INSTALLED IN STORM AND SANITARY PIPING. COORDINATE LOCATIONS WITH ARCHITECT. PROVIDE CLEANOUTS AT THE BASE OF ALL STACKS. REFER TO ARCHITECTURAL PLANS FOR CEILING TYPES.

# □E□ED NOTES

- 1) ROUTE 4" SANITARY, 2" VENT AND 3/4" CW DOWN TO WATER CLOSET.
- 2 ROUTE 1/2" SANITARY, 1 1/4" VENT, 1/2" HOT WATER DOWN TO LAVATORY.
- ROUTE 1 1/2" SANITARY, 1 1/4" VENT, 1/2" COLD WATER AND 1/2" HOT WATER DOWN TO SINK.

ROUTE 3" SANITARY, 1 1/2" VENT, 3/4" COLD WATER, 3/4" HOT WATER AND 3/4" CONDENSATE DRAIN DOWN TO SERVICE SINK.

- 3. DUCTWORK/PIPING SHALL NOT BE LOCATED OVER ELECTRICAL EQUIPMENT/PANELS. PROVIDE REQUIRED CLEARANCE IN FRONT OF ELECTRICAL
- ETC. FOR THE PROPER INSTALLATION OF ALL MECHANICAL SYSTEMS.
- 6. REFER TO ARCHITECTURAL REFLECTED CEILING PLANS FOR EXACT LOCATION OF GRILLES, REGISTERS, AND DIFFUSERS.
- TO MECHANICAL DEVICES REQUIRING ACCESS.

- 11. FOR EQUIPMENT VALVING, COMPONENT, AND PIPING ARRANGEMENT, REFER TO PIPING DIAGRAMS AND DETAILS.



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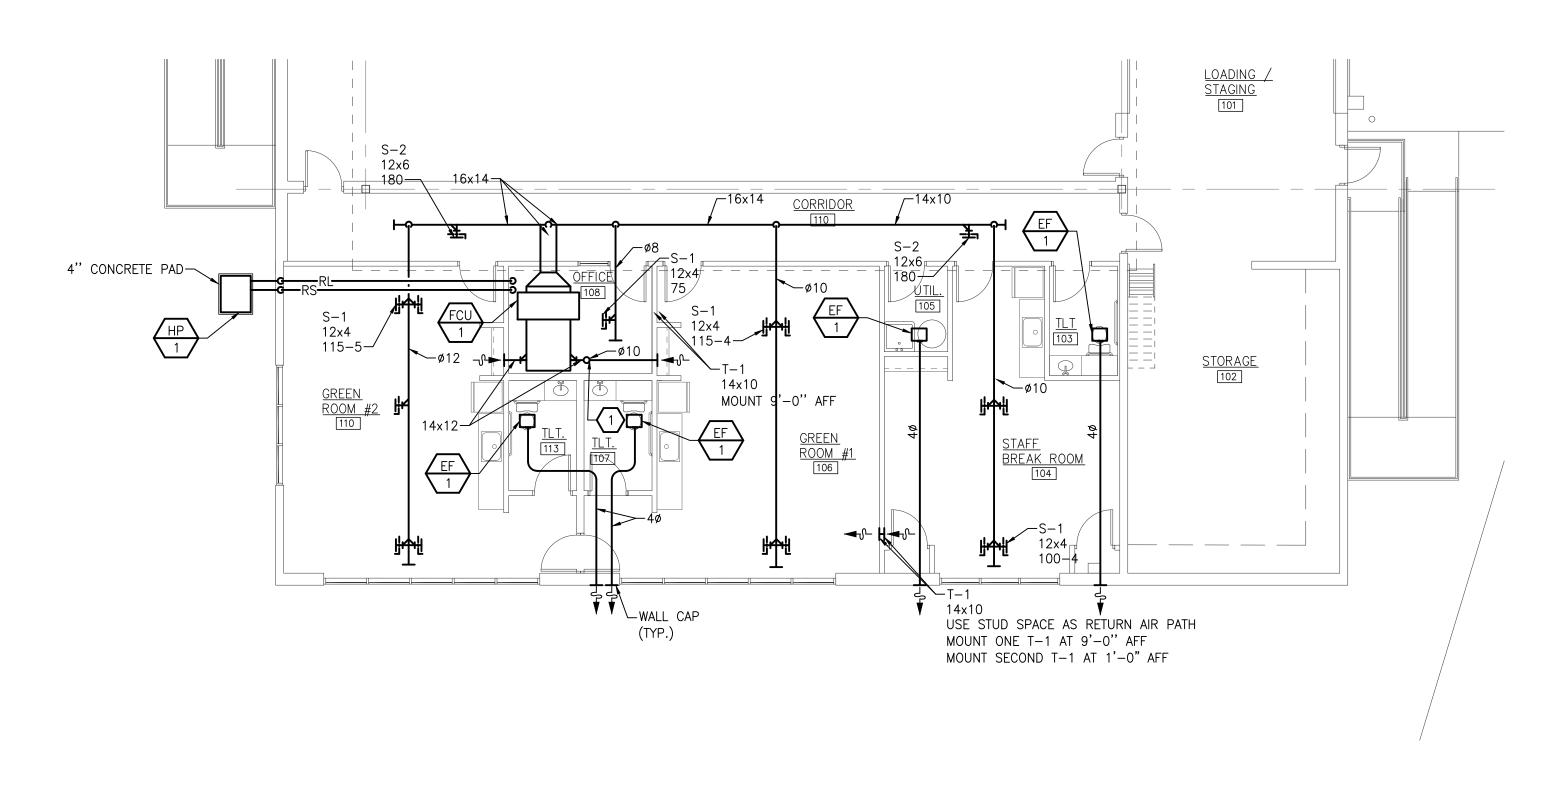
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RHM

checked by JDK

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16078A M2.1





	GR	ILLE, RE	EGISTEF	R AND DI	IFFUSI	ER SCH	HEDULE	
UNIT ID	FACE SIZE	NECK SIZE	MOUNTING	ACCESSORY	FINISH	MATERIAL	MODEL NO.	REMARKS
S-1	NECK+2"	SEE PLANS	DUCT	-	WHITE	STEEL	SDG	
S-2	NECK+2"	SEE PLANS	DUCT	-	WHITE	STEEL	520D	
R-1	NECK+2"	SEE PLANS	NOTE 2	_	WHITE	STEEL	530	

- 1. MODEL NUMBERS ARE PRICE UNLESS OTHERWISE NOTED.
- 2. REFER TO ARCHITECTURAL CEILING PLAN AND COORDINATE FRAME TYPE

					E	XHAU	ST F	AN SO	CHED	ULE					
	NIT ID SERVING TYPE CEM ESP FAN MOTOR ELECTRICAL MODEL NO. REMARKS														
UNIT ID	SERVING	TYPE	CFM	(IN WG)	RPM	WATTS	HP	RPM	DRIVE TYPE	VOLTS	PHASE	MODEL NO.	REMARKS		
EF-1	RESTROOM	CEILING	90	0.25	1,161	20.7	ı	_	_	120	1	FV-11VQ5	INTLERLOCK WITH LIGHT SWITCH		
EF-2	RESTROOM	CEILING	90	0.25	1,161	20.7	-	-	-	120	1	FV-11VQ5	INTLERLOCK WITH LIGHT SWITCH		
EF-3	RESTROOM	CEILING	90	0.25	1,161	20.7	_	-	-	120	1	FV-11VQ5	INTLERLOCK WITH LIGHT SWITCH		
EF-4	JANITOR'S CLOSET	CEILING	90	0.25	1,161	20.7	ı	_	-	120	1	FV-11VQ5	INTLERLOCK WITH LIGHT SWITCH		

# NOTES:

- 1. MODEL NUMBERS ARE PANASONIC UNLESS OTHERWISE NOTED.
- 4. PROVIDE WALL CAP AT TERMINATION POINT.

- 2. PROVIDE WITH GRAVITY BACKDRAFT DAMPER.
- 3. CONTROL SHALL BE BY MANUAL MOTOR STARTER PROVIDED BY ELECTRICAL TRADES.

						FA	N COI	L UNI	ГЅСН	EDUL	E.				
	NOMBA	OLITOIDE.	FA	AN	COOLING COIL	HEATING COIL	MAXIMUN	M UNIT DIME	ENSIONS	FILTER	E	LECTRICAL	_		
UNIT ID	NOMINAL AIRFLOW	OUTSIDE AIRFLOW			TOTAL	0.15.1015.								MODEL NO.	REMARKS
0,11,	(CFM)	(CFM)	QTY	ESP	CAPACITY (MBH)	CAPACITY (MBH)	LENGTH (IN)	DEPTH (IN)	HEIGHT (IN)	TYPE	AMPS	VOLTS	PHASE		,, <u>_</u> ,,,,
FCU-1	1,800	300	2	0.30	76.4	86	61.5	27.125	18.125	MERV 8	5.2	208	1	ARNU763B8A4	

- 1. MODEL NUMBERS ARE LG UNLESS NOTED OTHERWISE.
- 2. CAPACITIES BASED ON HIGH SPEED SETTING.
- 3. COOLING COIL CAPACITY BASED ON 75° F DB, 62.5° F WB EAT.

	AIR SOURCE HEAT PUMP SCHEDULE											
1 N I T 1 D	NOMINAL	MINIMUM		ELECTRIC		FAN	COMPR	ESSORS	MODEL NO	DEMON		
UNII ID	UNIT ID TONNAGE	SEER	MCA	MAX FUSE SIZE	VOLTS	PHASE	CFM	NO.	TYPE	MODEL NO.	REMARKS	
HP-1	6	17	22.6	35	208	3	8,470	1	SCROLL	ARUM072BTE5		

# NOTES:

1. MODEL NUMBERS ARE TRANE LG OTHERWISE NOTED.


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- 4. THE CONTRACTOR SHALL PROVIDE ALL MISCELLANEOUS SUPPORTING STEEL, ETC. FOR THE PROPER INSTALLATION OF ALL MECHANICAL SYSTEMS.
- 5. COORDINATE FLOOR, WALL, ROOF PENETRATIONS, LOUVER SIZES, PAD LOCATIONS ETC. WITH ARCHITECTURAL TRADES.
- 6. REFER TO ARCHITECTURAL REFLECTED CEILING PLANS FOR EXACT LOCATION OF GRILLES, REGISTERS, AND DIFFUSERS.
- 7. PIPING/DUCTWORK SHALL NOT BE LOCATED OVER ELECTRICAL EQUIPMENT/ PANELS. PROVIDE REQUIRED CLEARANCE IN FRONT/ABOVE OF ELECTRICAL EQUIPMENT. PIPING SHALL NOT INTERFERE WITH ELECTRICAL EQUIPMENT CLEARANCE.
- 8. PROVIDE CODE REQUIRED CLEARANCE/ACCESS DOORS FOR DAMPERS, VALVES, AND CLEANOUTS LOCATED IN WALLS OR ABOVE HARD CEILINGS. COORDINATE LOCATIONS WITH ARCHITECT.
- 9. BRANCH DUCTWORK TO GRILLES, REGISTERS AND DIFFUSERS SHALL BE THE SAME SIZE AS THE GRILLE, REGISTER OR DIFFUSER NECK SIZE WHERE NO DUCT SIZE IS INDICATED ON PLAN.

10. MAXIMUM LENGTH OF FLEXIBLE DUCT SHALL BE 5'-0".

# □E□ED NOTES

OUTSIDE AIR INTAKE, TERMINATE WITH GOOSE NECK MINIMUM 18" ABOVE ROOF DECK. BALANCE TO 300 CFM.

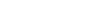

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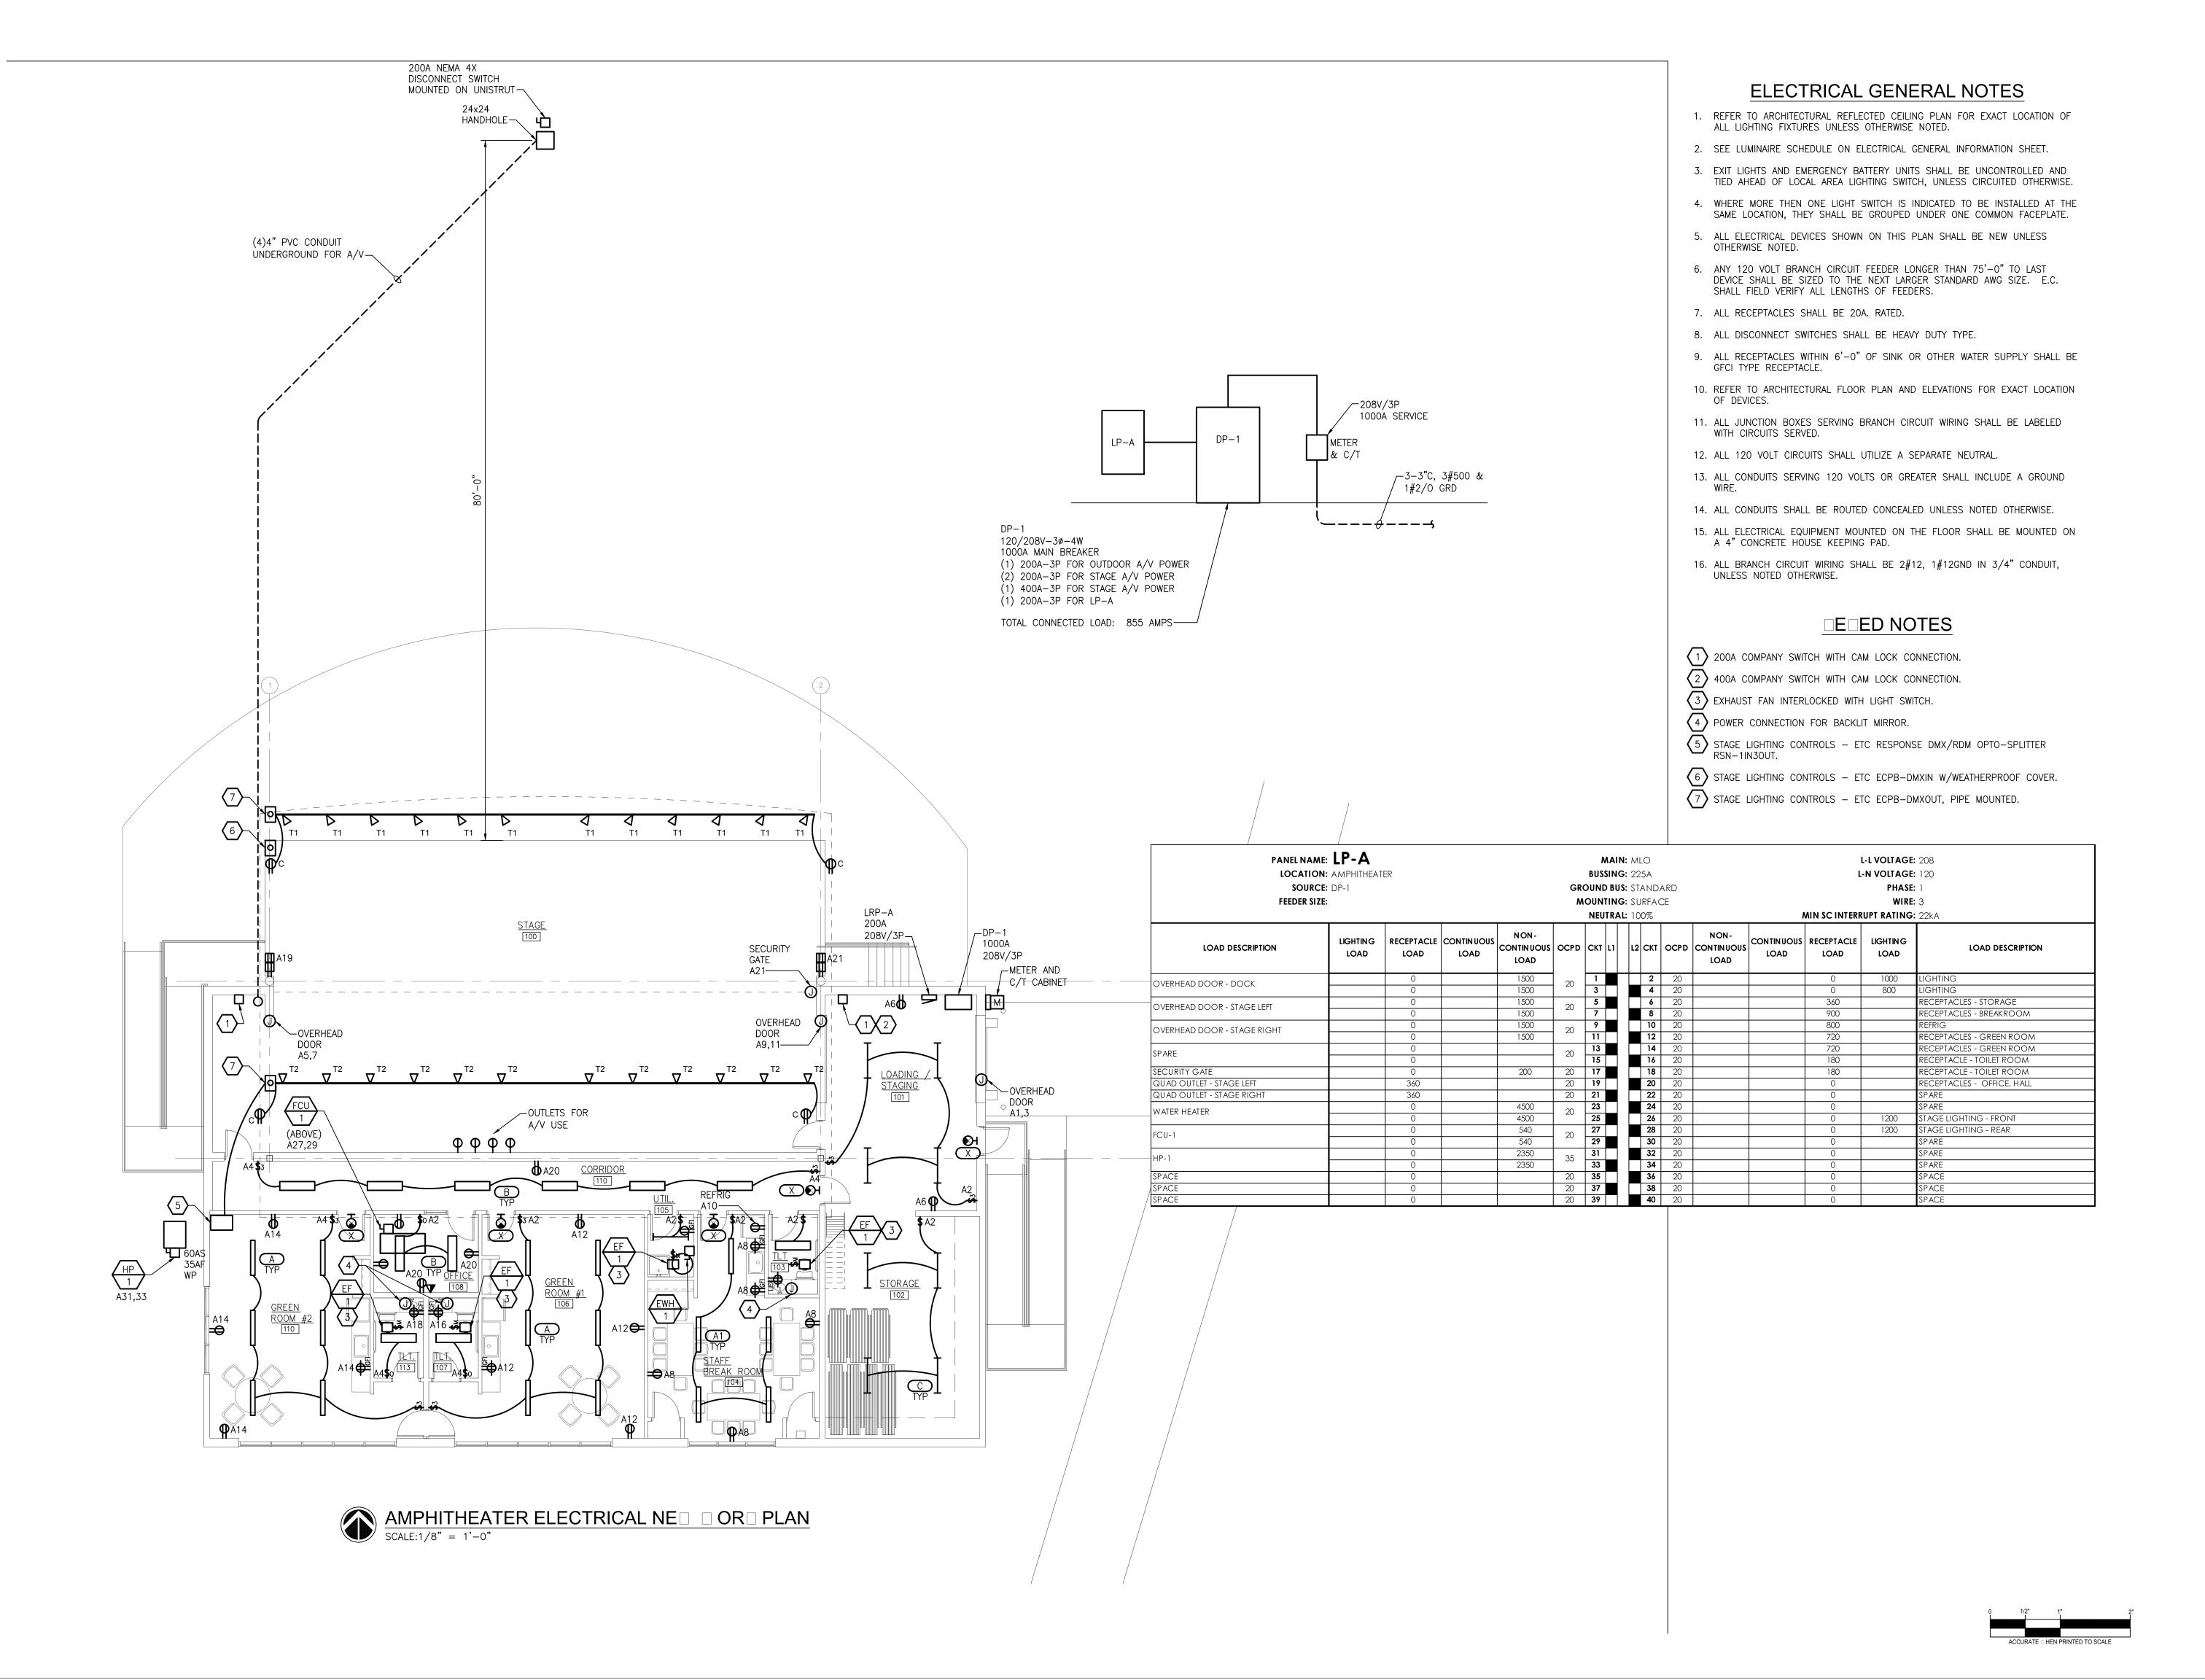
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6-19-17 Bids

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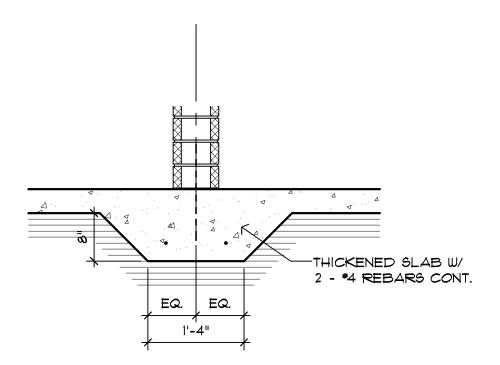
6" CONC. SLAB W/ 6x6-W2.9x2.9 WWF
IN UPPER 1/3 OF SLAB ON
COMPACTED GRANULAR BASE (TYP.)

REFRIGERATOR SLAB, INSULATION
AND BASE BY ICE RINK
CONTRACTOR


1'-0"

2 - \*4 REBARS CONT.

Foundation Detail at Ice Rink Floor
Al.1 SCALE: 3/4" = 1'-0"




©03 Foundation Detail at Thickened Slab

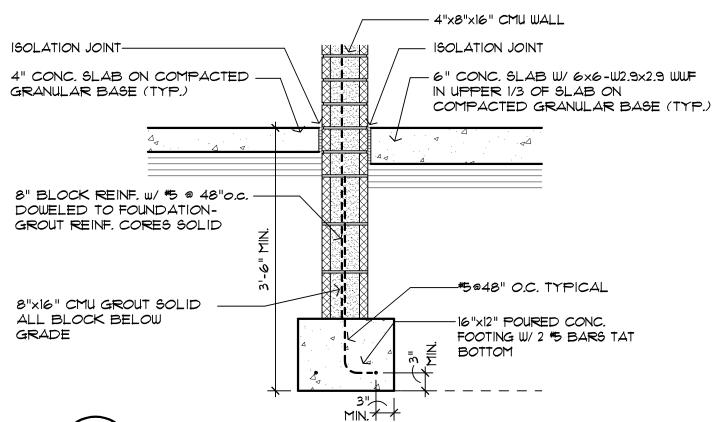


Foundation Detail at Exterior Wall

Al.1 SCALE: 3/4" = 1'-0"

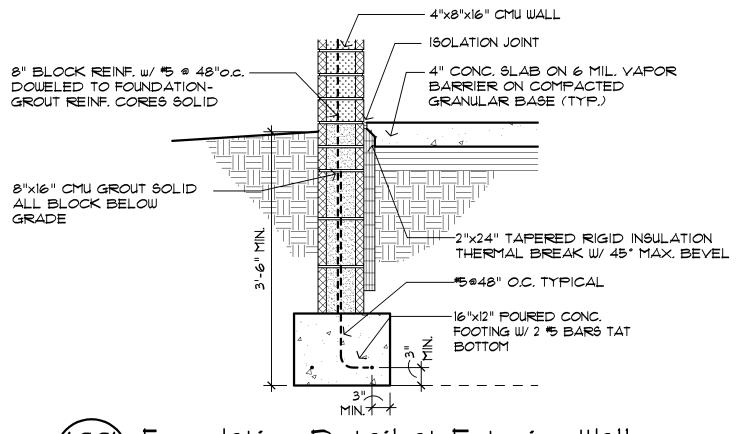

(1.001) Foundation Detail at Exterior Wall


Al.1) SCALE: 3/4" = 1'-0"

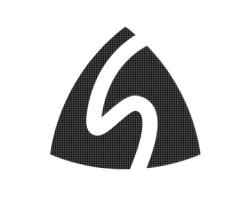


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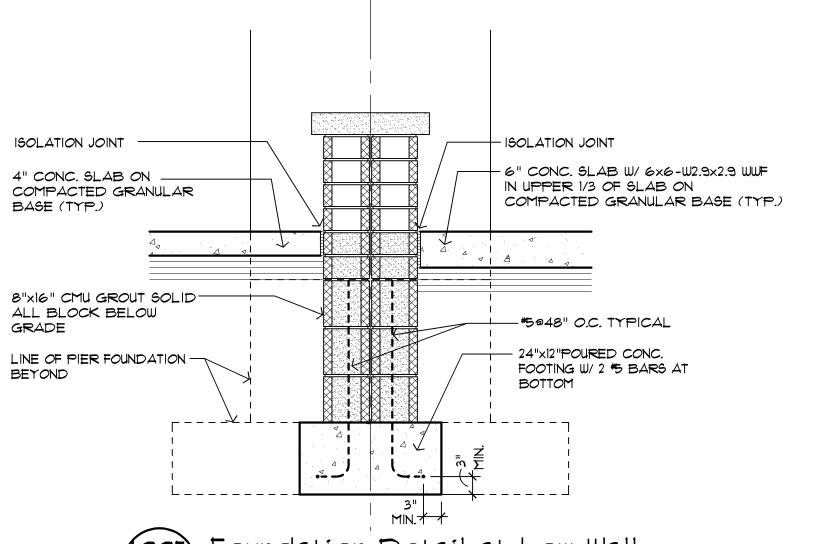
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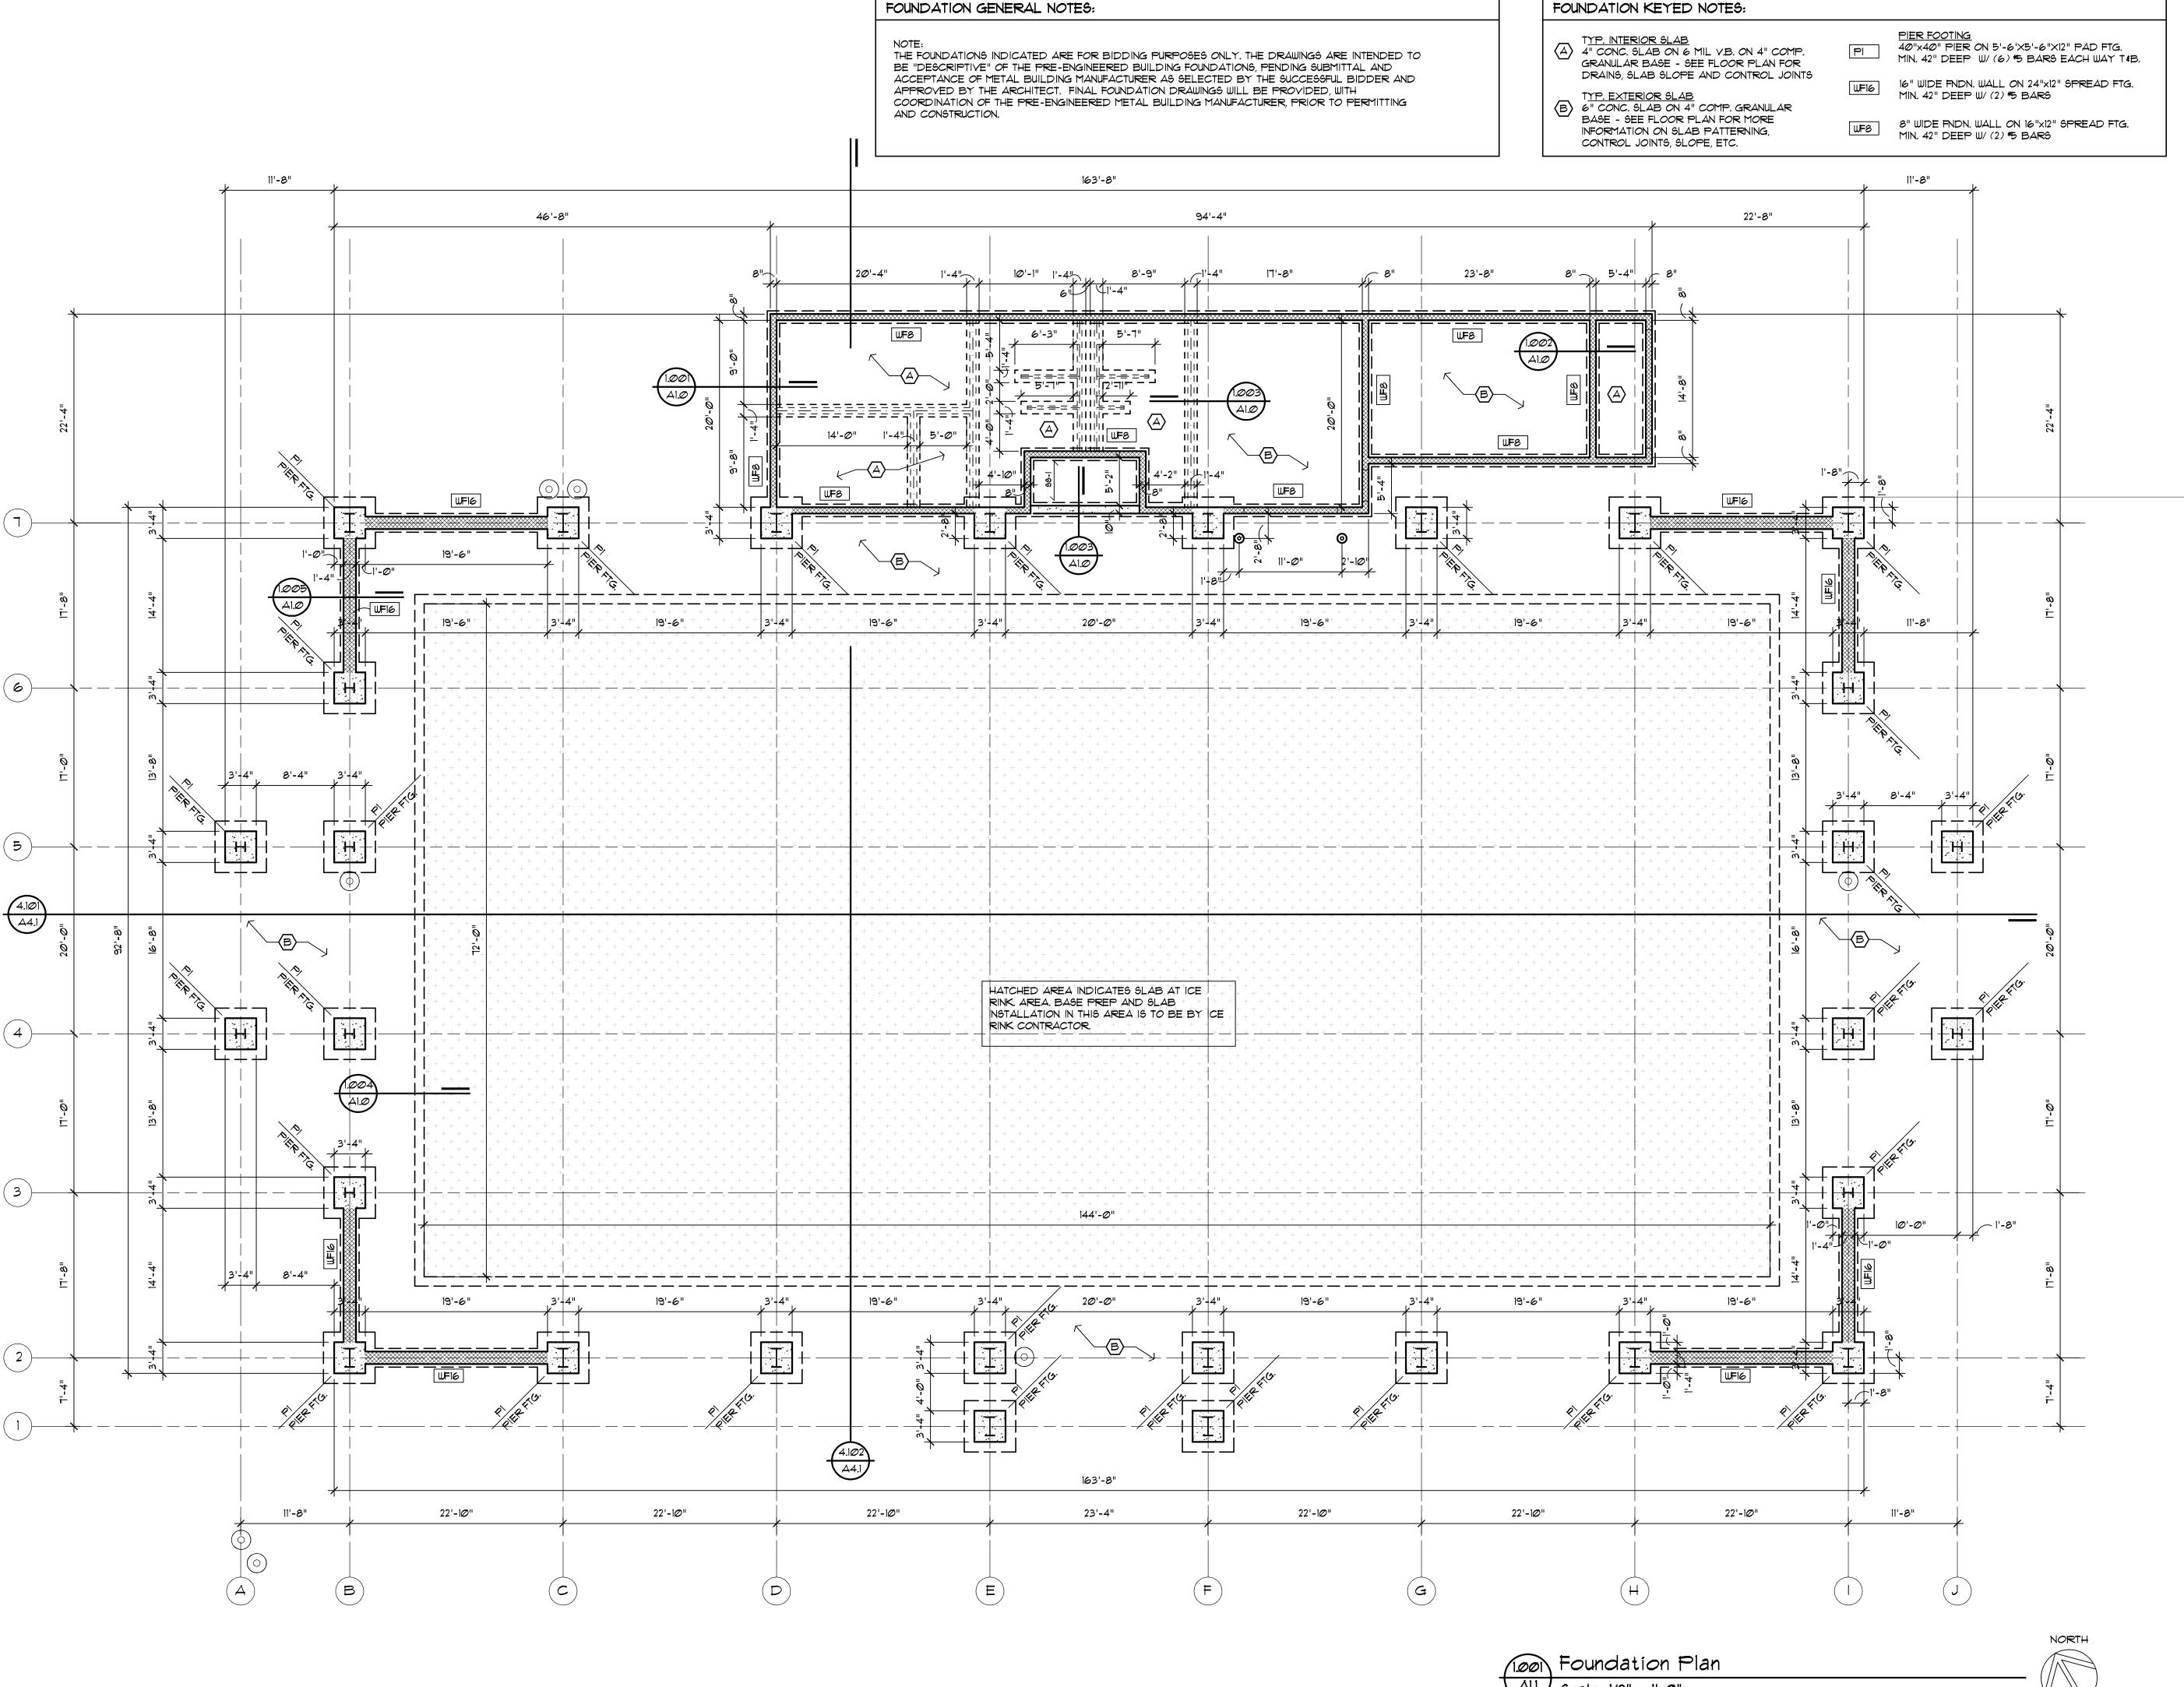




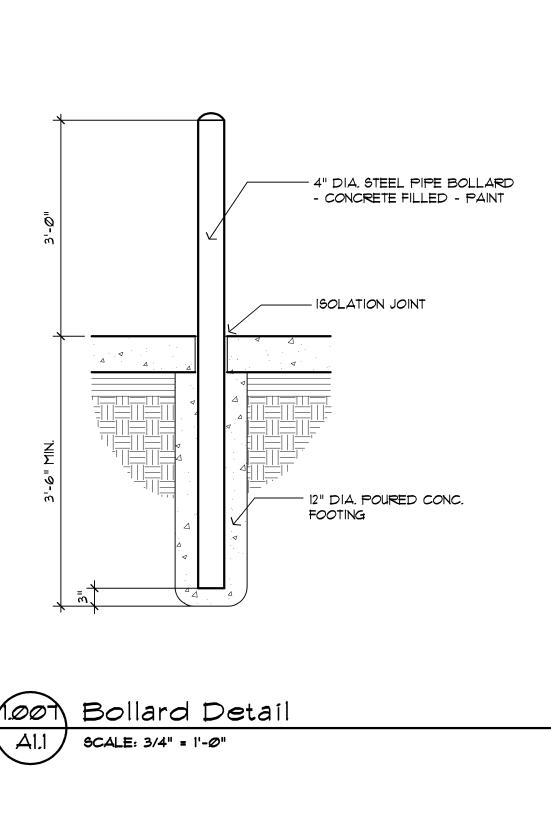

Foundation Detail at Low Wall

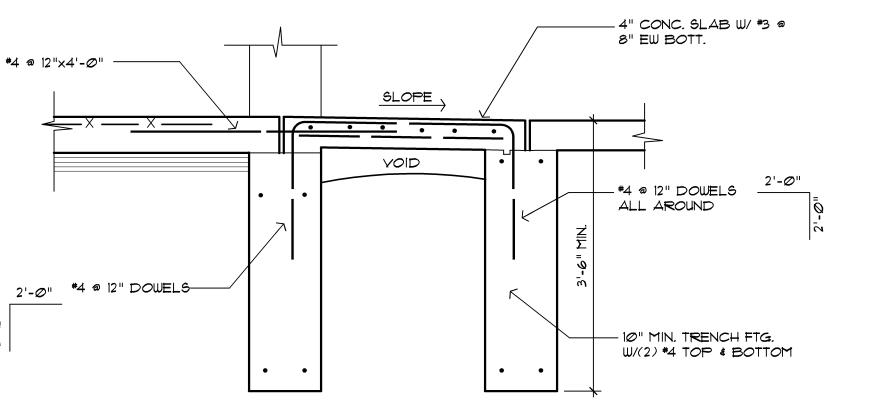Al.1 SCALE: 3/4" = 1'-0"



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5-9-17 Prelim. Review
5-9-17 Prelim. Review
5-16-17 Prelim. Review
6-7-17 City Review

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Gram by should by

Sterling Heights Park Improvements Heights, Michigan


Dodge Park In Sterling Height

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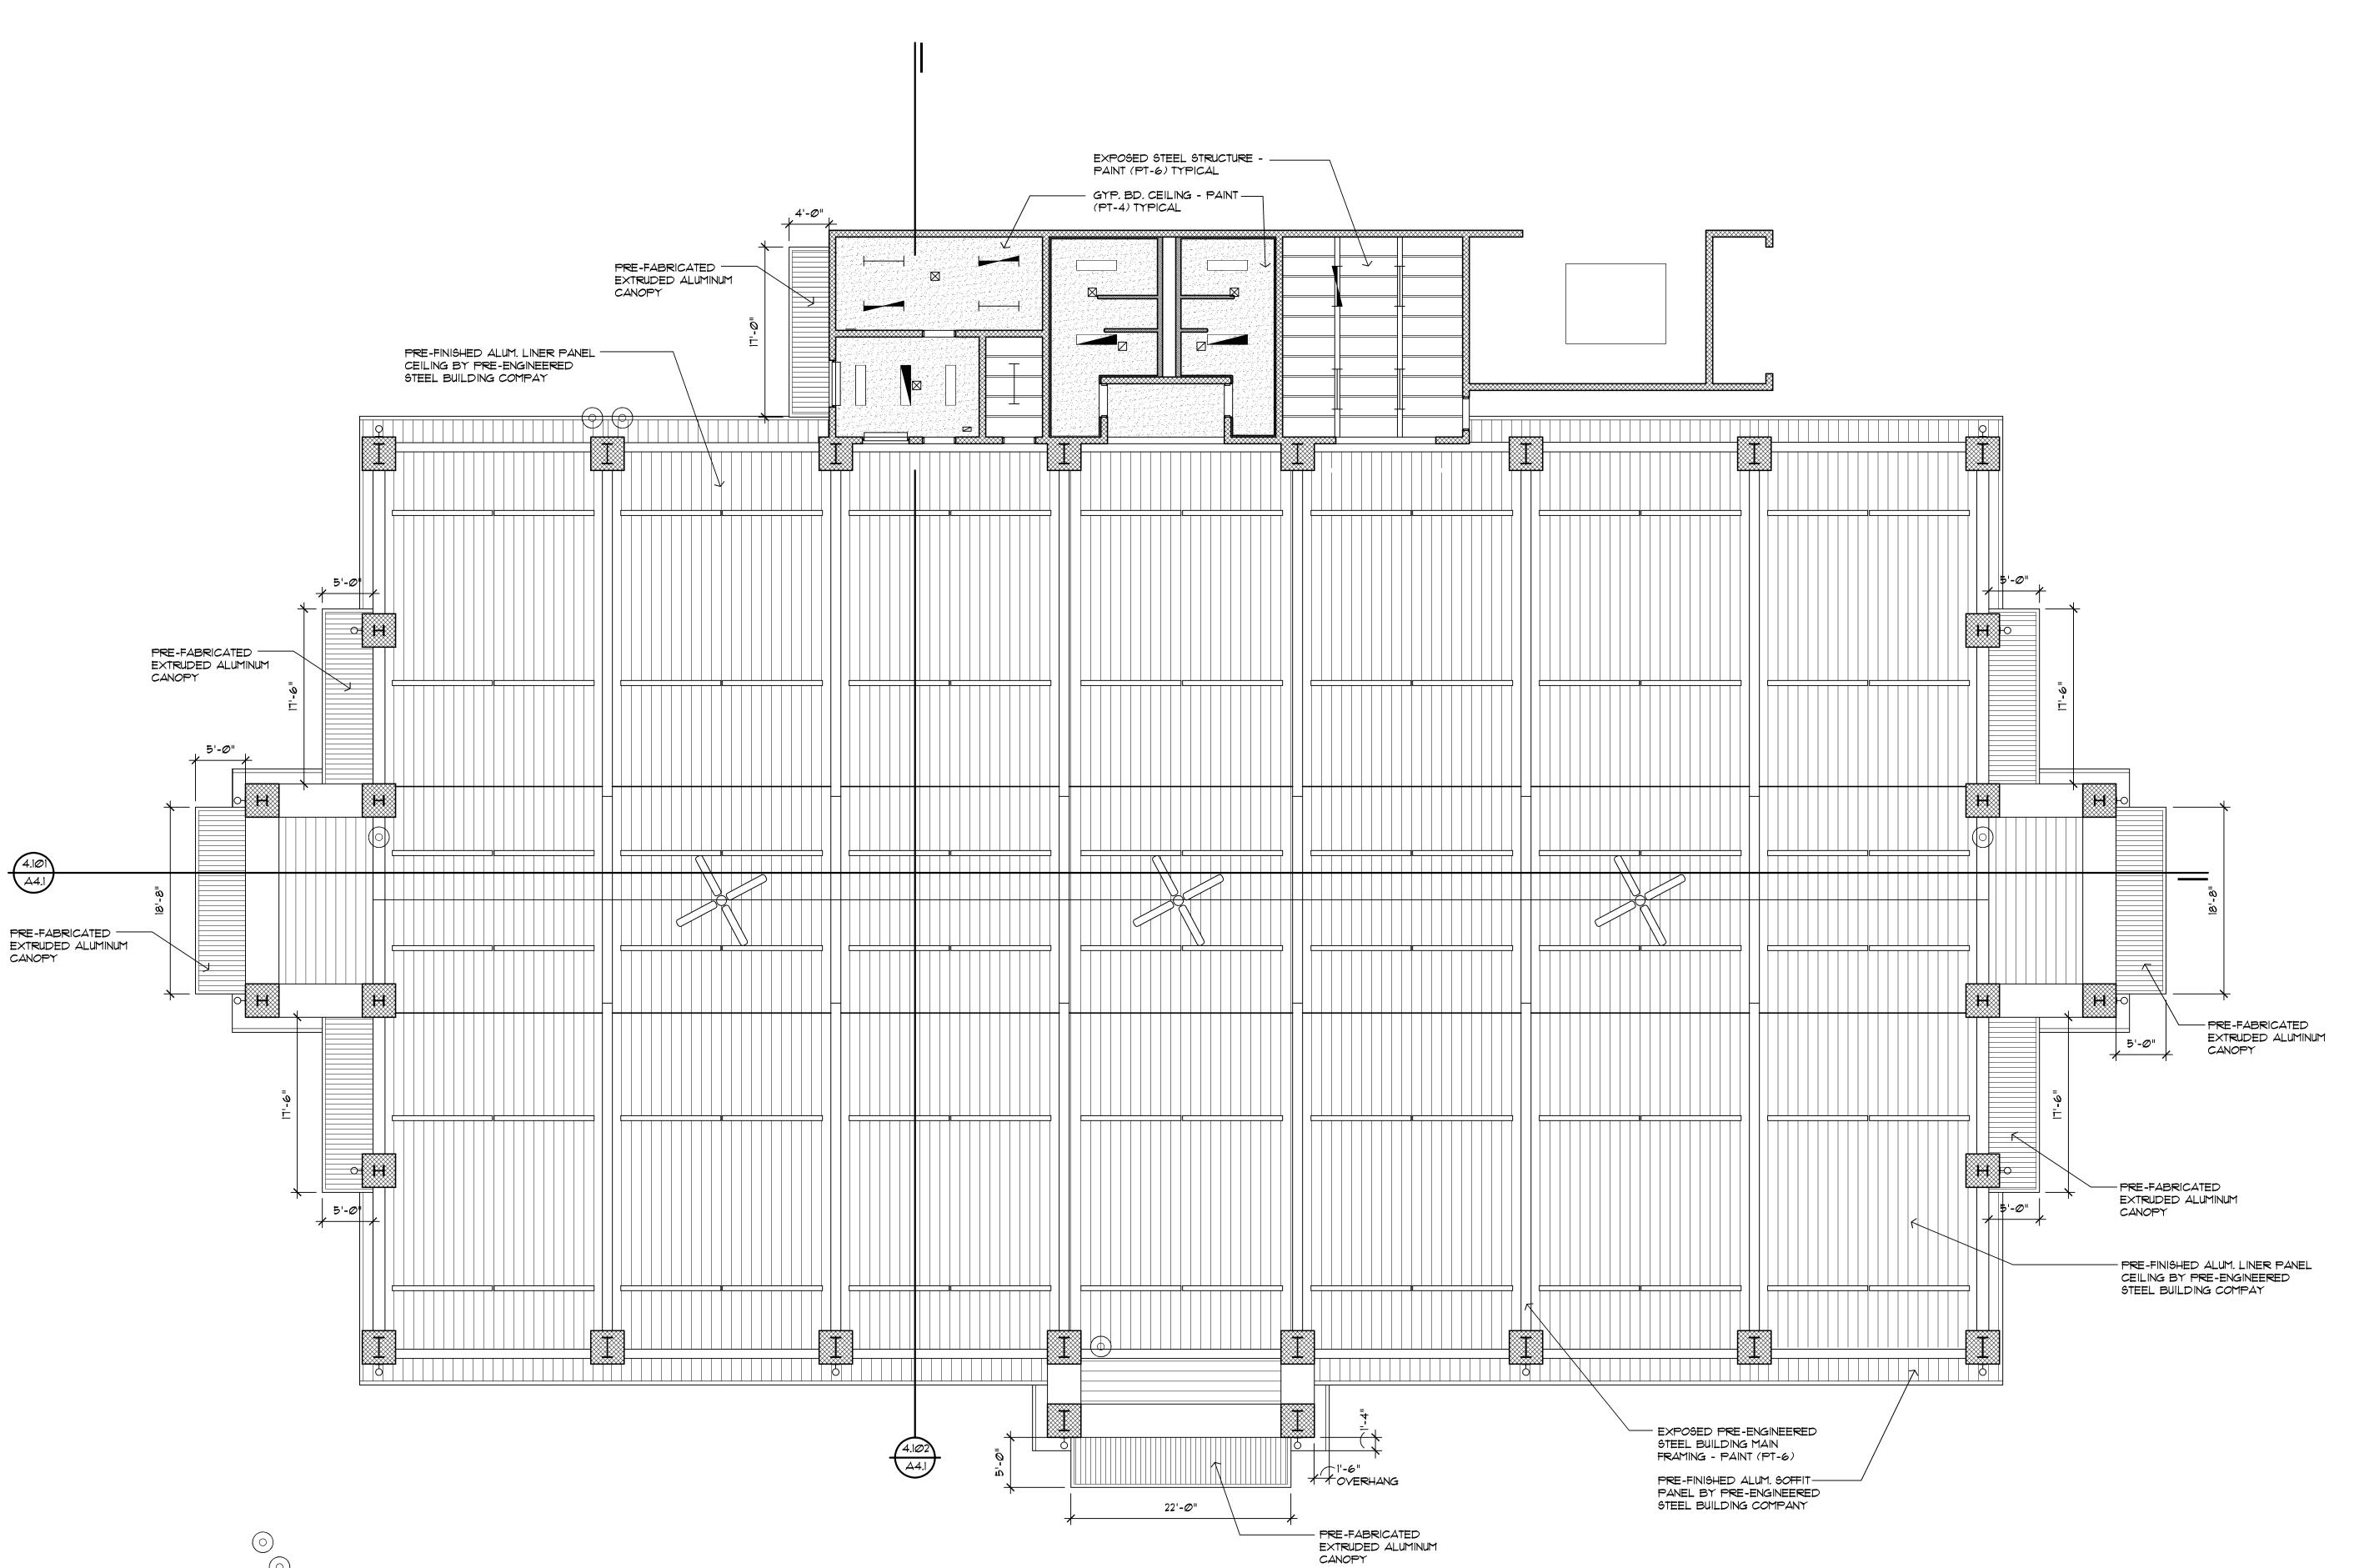
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5-16-17 Prelim. Review
6-7-17 City Review
6-19-17 Bids

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City of Sterling Heights
Dodge Park Improvements
Sterling Heights, Michigan
Farmers Market
Reflected Ceiling Plan

Dorchen/Martin Associates, Inc. Architects/Planners

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NORTH

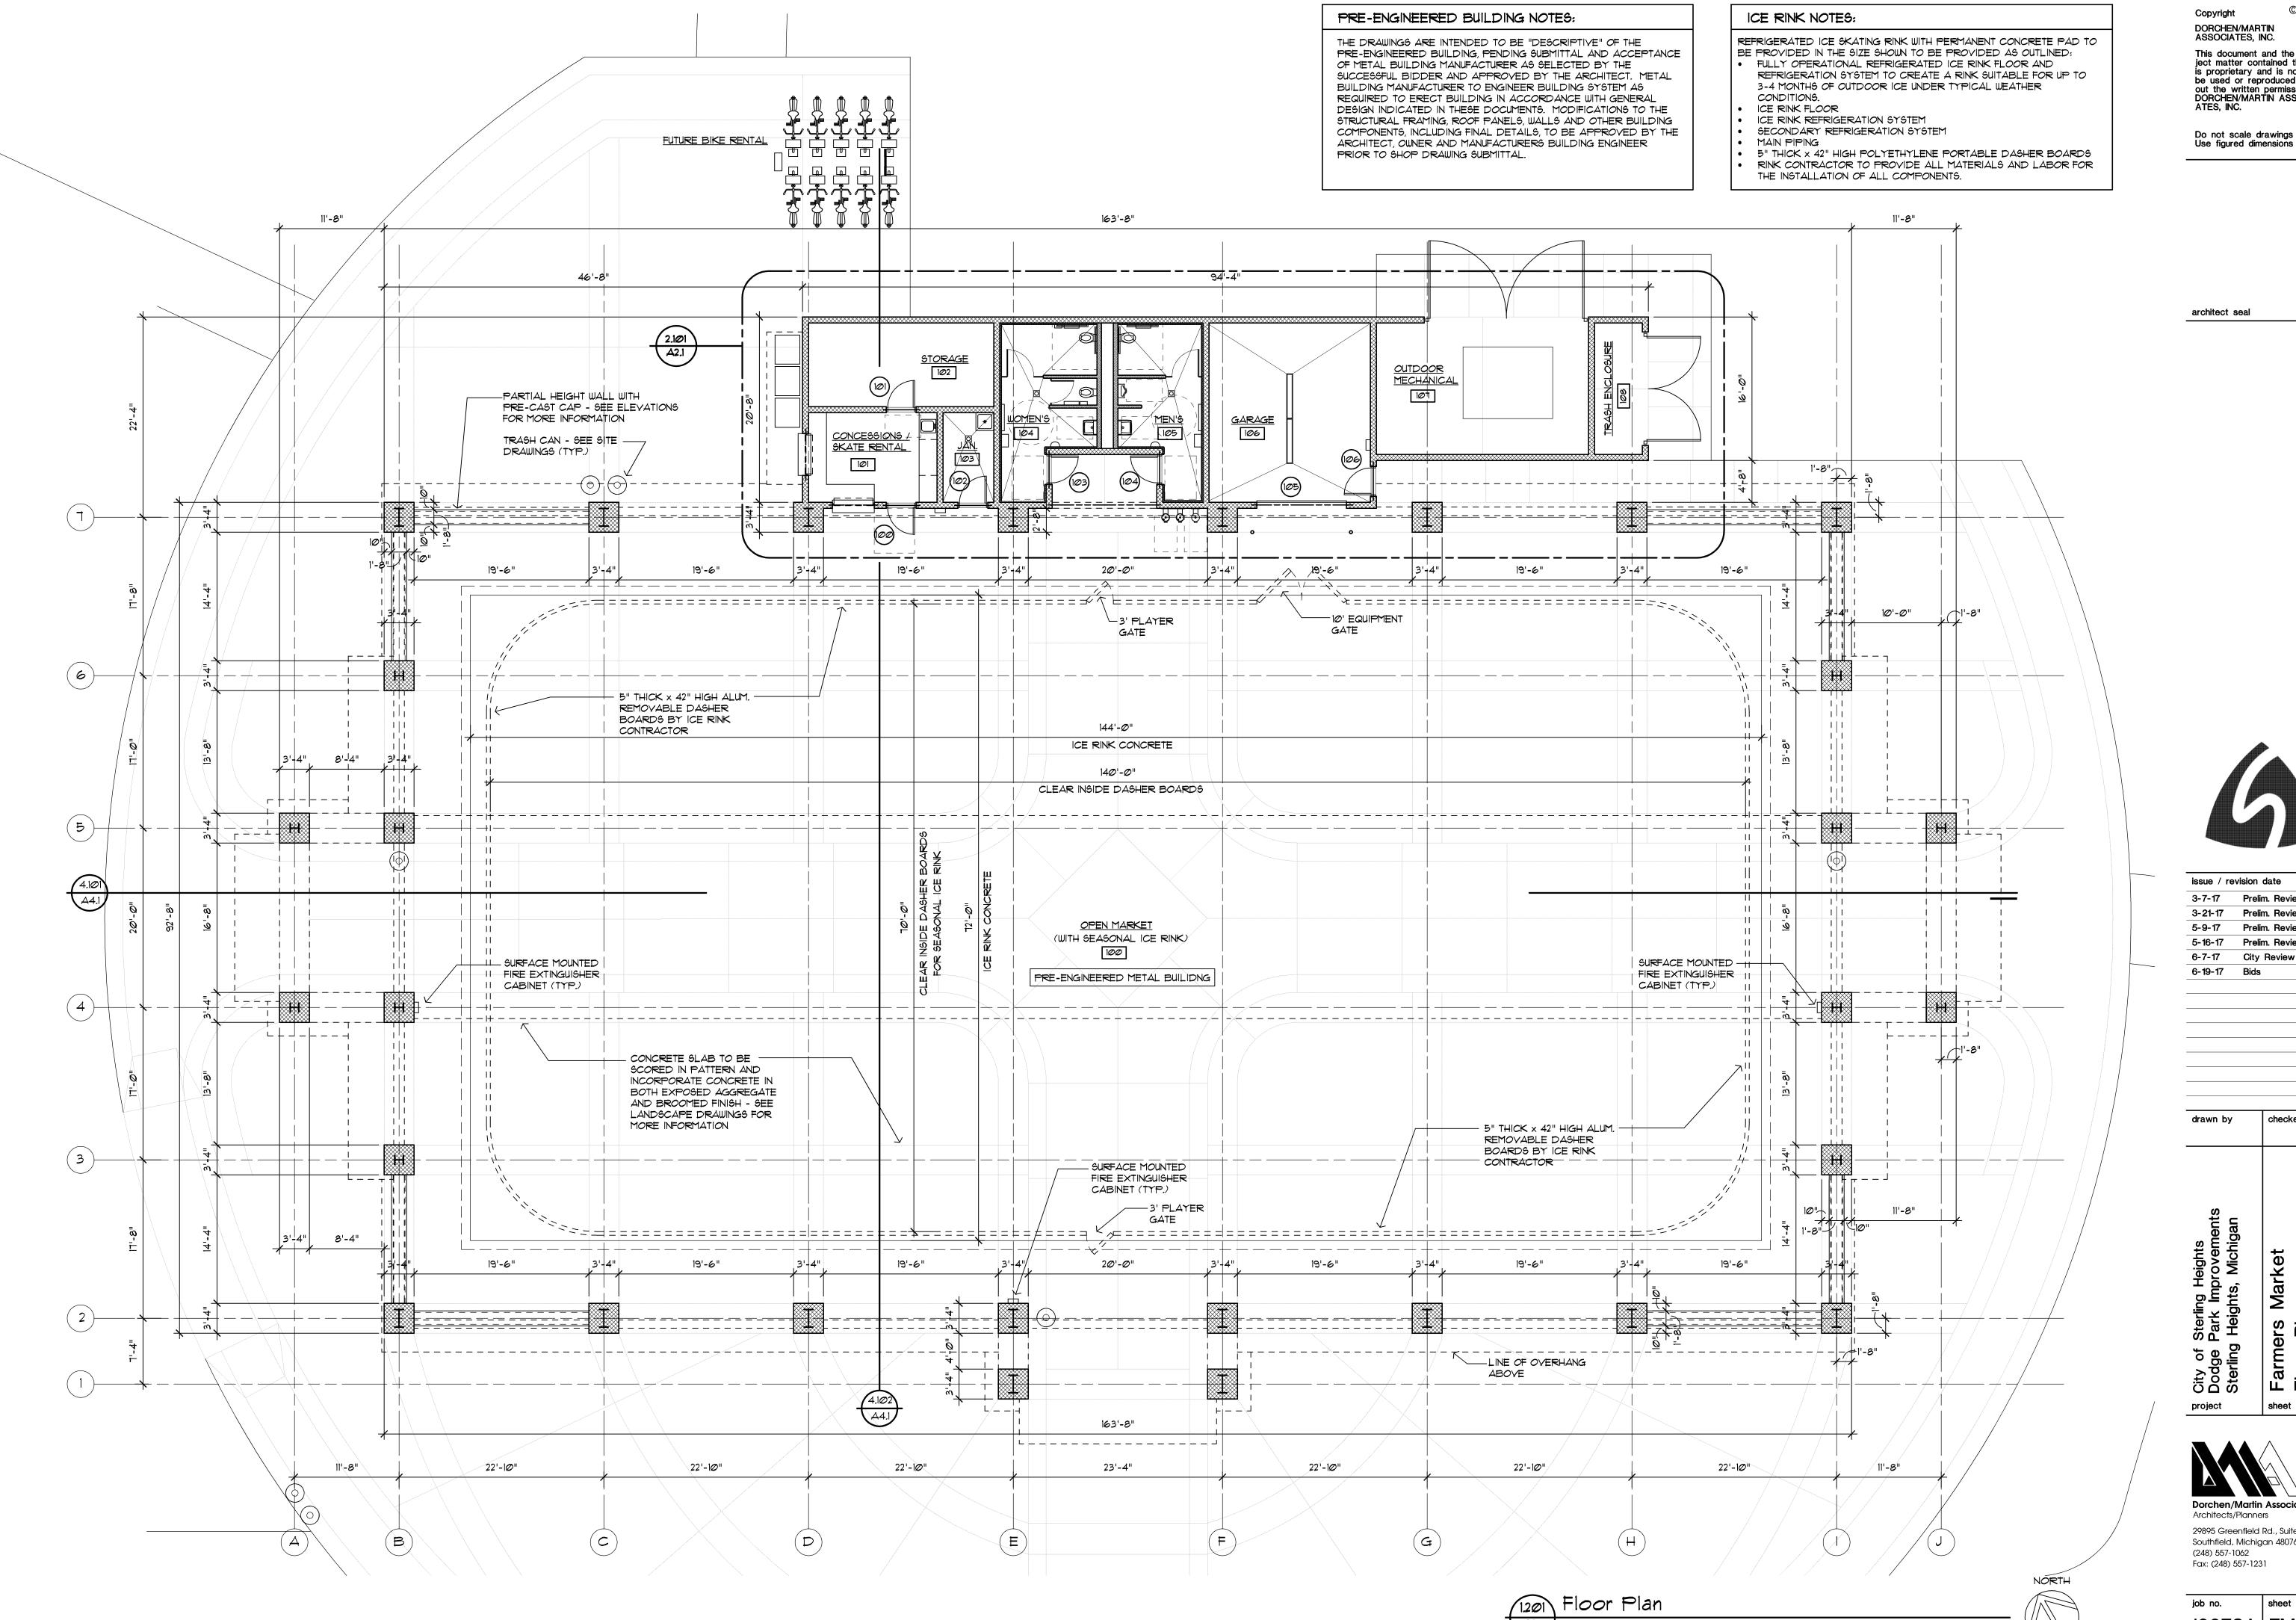Reflected Ceiling Plan

Al3 Scale: 1/8" = 1'-0"

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PRE-ENGINEERED METAL BUILDING COMPANY - STANDING SEAM METAL ROOF BY PRE-ENGINEERED METAL BUILDING COMPANY - PRE-FABRICATED EXTRUDED ALUMINUM CANOPY PRE-FABRICATED EXTRUPED — ALUMINUM CANOPY — ALUMINUM GUTTERS & DOWNSPOUTS BY PRE-ENGINEERED METAL BUILDING COMPANY - PRE-FABRICATED EXTRUDED ALUMINUM CANOPY issue / revision date 3-7-17 Prelim. Review PRE-FABRICATED EXTRUDED ---3-21-17 Prelim. Review ALUMINUM CANOPY 5-9-17 Prelim. Review 5-16-17 Prelim. Review 6-7-17 City Review 6-19-17 Bids CURVED STANDING SEAM METAL -ROOF BY PRE-ENGINEERED METAL BUILDING COMPANY - CURVED STANDING SEAM METAL ROOF BY PRE-ENGINEERED METAL BUILDING COMPANY PRE-FABRICATED EXTRUDED ALUMINUM CANOPY PRE-FABRICATED EXTRUDED ALUMINUM CANOPY checked by STANDING SEAM METAL ROOF BY— PRE-ENGINEERED METAL BUILDING COMPANY - ALUMINUM GUTTERS & DOWNSPOUTS ALUMINUM GUTTERS & DOWNSPOUTS — BY PRE-ENGINEERED METAL BUILDING COMPANY BY PRE-ENGINEERED METAL BUILDING COMPANY <u>A4.1</u> CURVED STANDING SEAM METAL PRE-FABRICATED EXTRUDED ROOF BY PRE-ENGINEERED METAL BUILDING COMPANY ALUMINUM CANOPY Dorchen/Martin Associates, Inc. Architects/Planners 29895 Greenfield Rd., Suite 107 Southfield, Michigan 48076 (248) 557-1062 NORTH Fax: (248) 557-1231

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sheet no.

### STEEL LINTEL SCHEDULE

- L1 L4x3½x5/16 ANGLE
- L2 W8x28 + 3/8" PLATE
- ALL DOUBLE ANGLE LINTELS SHALL BE WELDED BACK TO BACK WITH A MINIMUM 2 INCH STITCH WELD EVERY 8 INCHES.
- ALL MASONRY BEARING STEEL BEAMS AND LINTELS TO BEAR 8" MINIMUM ON 3 COURSES SOLID MASONRY, WITH 2-3/4" DIAMETER BOLTS EACH END, UNLESS OTHERWISE NOTED.

### TOILET ROOM FIXTURES LEGEND

- B.F. BARRIER-FREE BCS BABY CHANGING STATION W.R. WASTE RECEPTACLE S.D. SOAP DISPENSER
- T.P. TOILET PAPER HOLDER SND. SANITARY NAPKIN DISPOSAL
- W.C. WATER CLOSET
- H.D. ELECT. HAND DRYER

	WALL TYPE SCHEDULE
(A) = 0	4"x16"x8" CMU FULL HEIGHT EXTERIOR WALL- CONSUMER CONCRETE "BELLA BRIK" CINCINNATI BLEND W/ CORE FILL INSULATION SEE ELEVATIONS FOR LOCATION OF SPLIT FACE BLOCK ACCENT BAND SEAL EXPOSED INTERIOR SURFACES
(B) (B) (C) (C) (C) (C) (C) (C) (C) (C) (C) (C	4"x16"x8" CMU INTERIOR WALL- CONSUMERS CONCRETE "BELLA BRIK" CINCINNATI BLEND - TOP OF WALL AT 8'-8" A.F.F. SEAL EXPOSED INTERIOR SURFACES
	4"x16"x8" CMU FULL HEIGHT EXTERIOR WALL - CONSUMER CONCRETE "BELLA BRIK" CINCINNATI BLEND W/ CORE FILL INSULATION SEE ELEVATIONS FOR LOCATION OF SPLIT FACE BLOCK ACCENT BAND SEAL EXPOSED INTERIOR SURFACES 8"x8"x2" GLAZED CERAMIC TILE (SEE INTERIOR ELEVATIONS FOR COLOR SELECTION) PROVIDE BULLNOSED PIECES AT ALL OUTSIDE CORNER
	4"x16"x8" CMU INTERIOR WALL - CONSUMERS CONCRETE "BELLA BRIK" CINCINNATI BLEND - TOP OF WALL AT 8'-0" AFF. SEAL EXPOSED INTERIOR SURFACES 8"x8"x2" GLAZED CERAMIC TILE (SEE INTERIOR ELEVATIONS FOR COLOR SELECTION) PROVIDE BULLNOSED PIECES AT ALL OUTSIDE CORNER
(E)	8"x8"x6" GLAZED CERAMIC TILE - INTERIOR FACE GLAZED - TOP OF WALL AT 8'-8" AFF. (SEE INTERIOR ELEVATIONS FOR COLOR SELECTION)

8"x8"x4" GLAZED CERAMIC TILE - ALL EXPOSED FACES

(SEE INTERIOR ELEVATIONS FOR COLOR SELECTION) PROVIDE BULLNOSED PIECES AT ALL OUTSIDE

CONSUMERS CONCRETE "BELLA BRIK" CINCINNATI

SEE ELEVATIONS FOR ACCENT BAND OF SPLIT FACE

GLAZED - TOP OF WALL AT 6'-0" AFF.

CORNERS AND AT TOP BLOCK


G 4"x16"x8" CMU PARTIAL HEIGHT EXTERIOR WALL-

BLOCK

Partial Enlarged Floor Plan

A2.1 Scale: 1/4" = 1'-0"

BLEND, TOP OF WALL AT 1'-8" AFF.

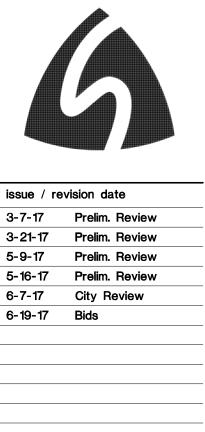

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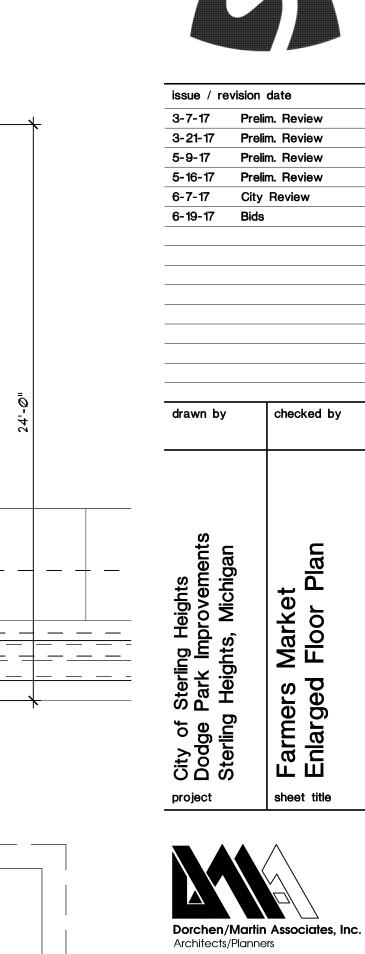
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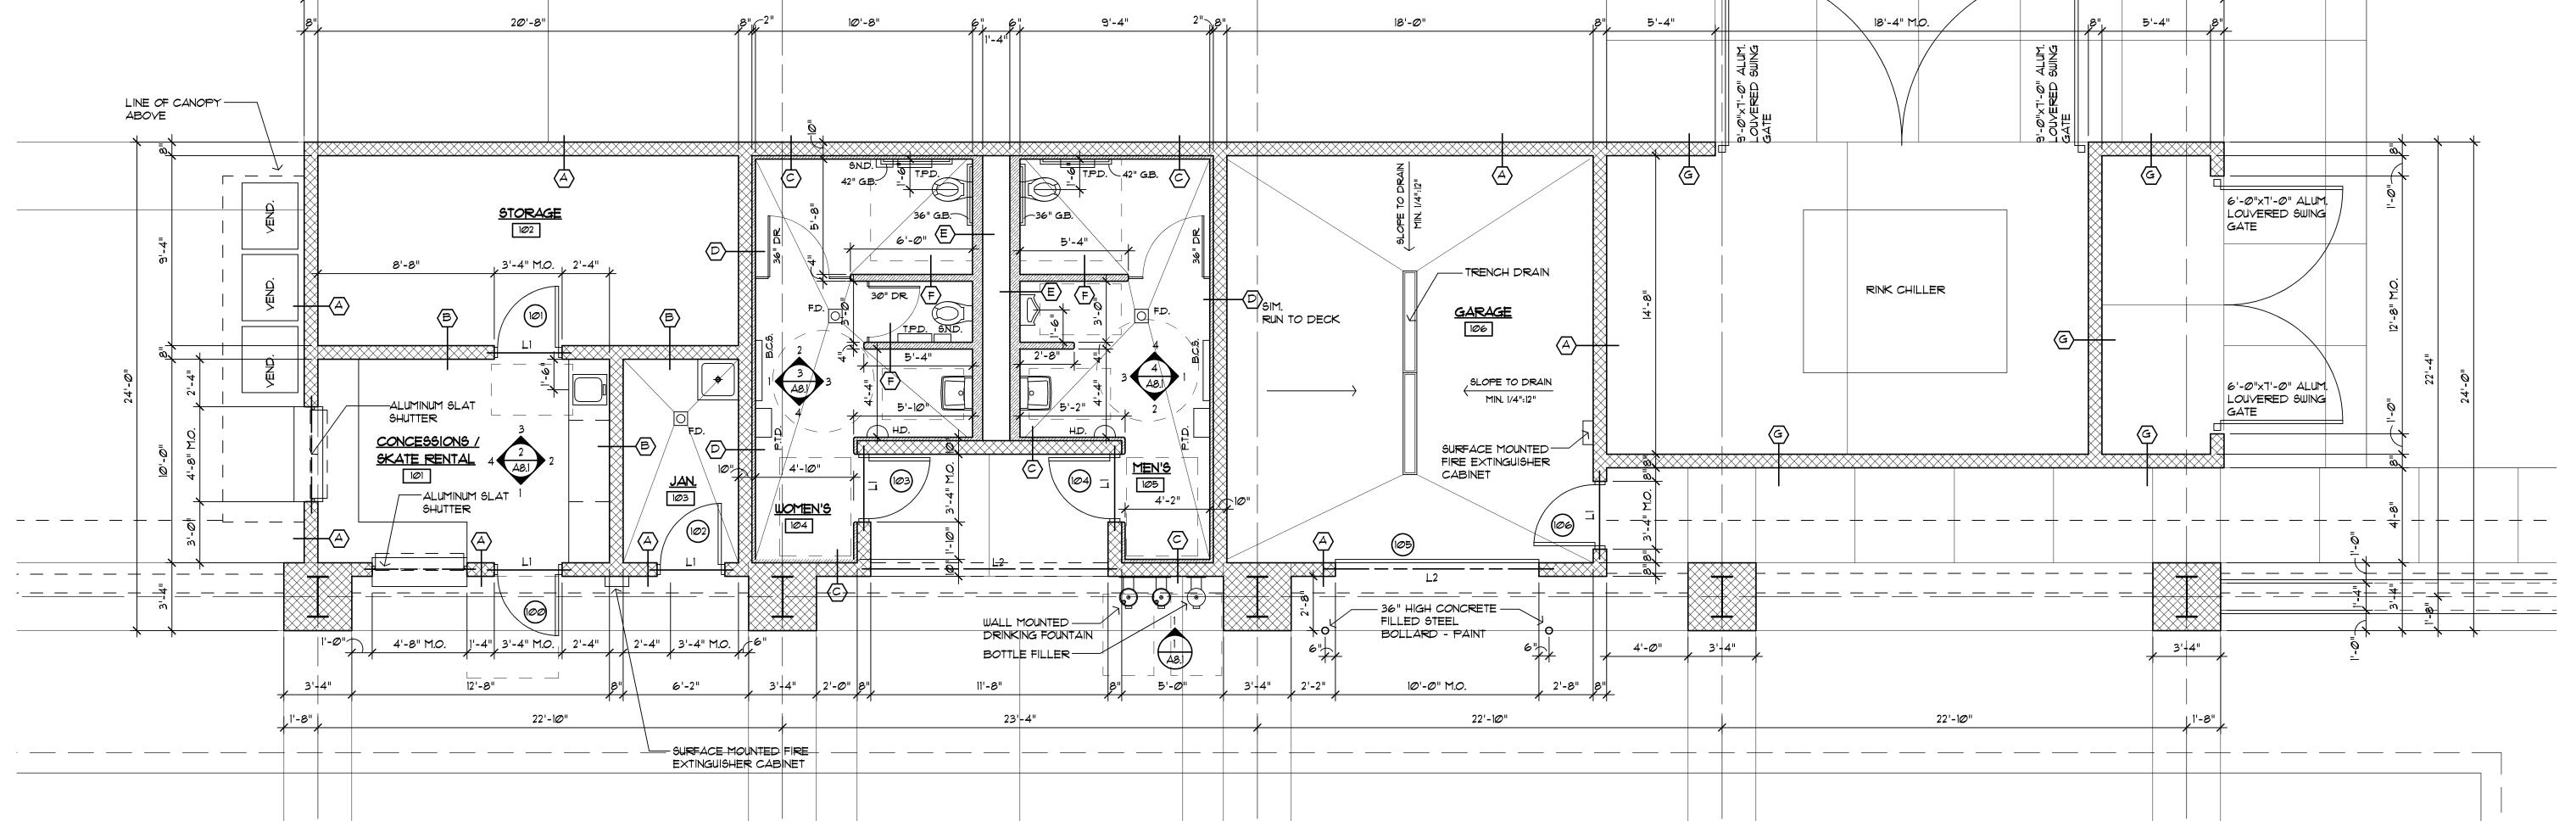
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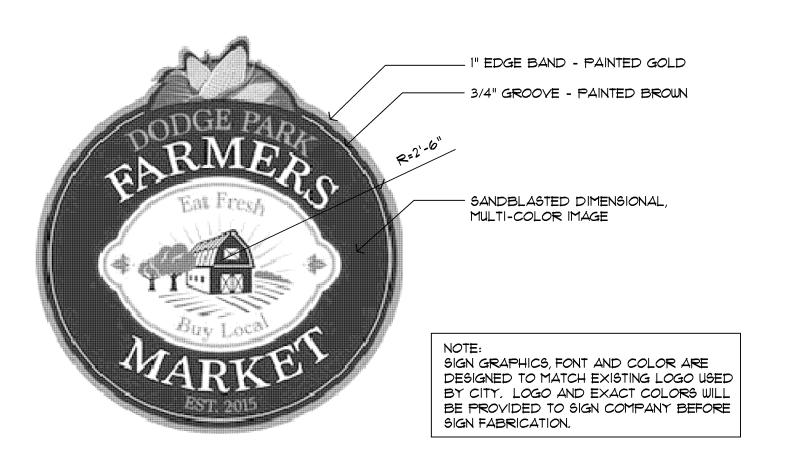
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3.103 Sign Detail (A3.1 ) Scale: 3/4" = 1'-0"

A3.1 | Scale: 1/8" = 1'-0"


### ELEVATION NOTES

- 4"x8"x16" CMU CONSUMER'S CONCRETE "BELLA BRIK" CINCINNATI BLEND
- 8"x8"x16" SPLIT FACE CMU ACCENT BAND (MATCH CMU ON EXISTING RESTROOM BUILDING) EXISTING RESTROOM BUILDING)
- FIBER CEMENT SIDING WOODTONE "RUSTIC SERIES" WINCHESTER BROWN, 7" EXPOSURE
- PRE-ENGINEERED STEEL BUILDING MAIN FRAME COLUMN -PAINT (PT-6)
- PRE-ENGINEERED STEEL BUILDING ENDWALL POST- PAINT
- SIMULATED STONE VENEER "CULTURED STONE" COUNTRY
- LEDGESTONE BUCKS COUNTY
- (G) 5/4x8 SMOOTH FACE FIBER CEMENT TRIM BOARD PAINT (H) 5/4x4 SMOOTH FACE FIBER CEMENT TRIM BOARD - PAINT
- (I) 4" PRECAST SILL
- (J) 4" PRECAST SLOPED PIER CAP
- STANDING SEAM METAL ROOFING BY PRE-ENGINEERED STEEL BUILDING MANUFACTURER (COLONIAL RED)
- ALUMINUM GUTTERS AND DOWNSPOUTS BY PRE-ENGINEERED ALUMINUM GUTTERS AND DOWNSTOUTS DIT INLIER STEEL BUILDING MANUFACTURER (COLOR T.B.D.)
- METAL FASCIA BY PRE-ENGINEERED STEEL BUILDING MANUFACTURER (COLONIAL RED)

- METAL RAKE BY PRE-ENGINEERED STEEL BUILDING MANUFACTURER (COLONIAL RED)
- PRE-ENGINEERED STEEL BUILDING ENDWALL FRAMING-PAINT (PT-6)
- 3' HIGH STATIONARY STEEL LOUVERS BAKED ENAMEL
- PRE-MANUFACTRED EXTRUDED ALUMINUM CANOPY -PRE-FINISHED (COLOR T.B.D.)
- R 7'-0" HIGH PRE-FINISHED ALUMINUM LOUVERED SWING GATE
- (5) "FARMERS MARKET" LOGO SIGN

FINISH (COLOR T.B.D.)

- TRANSLUCENT RFP PANELS W/ CUSTOM ARTWORK IN ALUMINUM CHANNEL FRAME (ARTWORK TO BE DETERMINED)
- U LINE OF FOUNDATION BELOW
- ALUMINUM SECURITY COUNTER GRILLE
- $\langle \overline{\mathbb{W}} \rangle$  ALUMINUM COPING ON TOP OF WALL (COLOR T.B.D.)

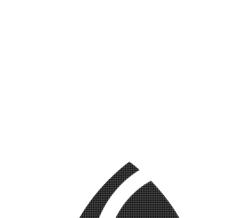

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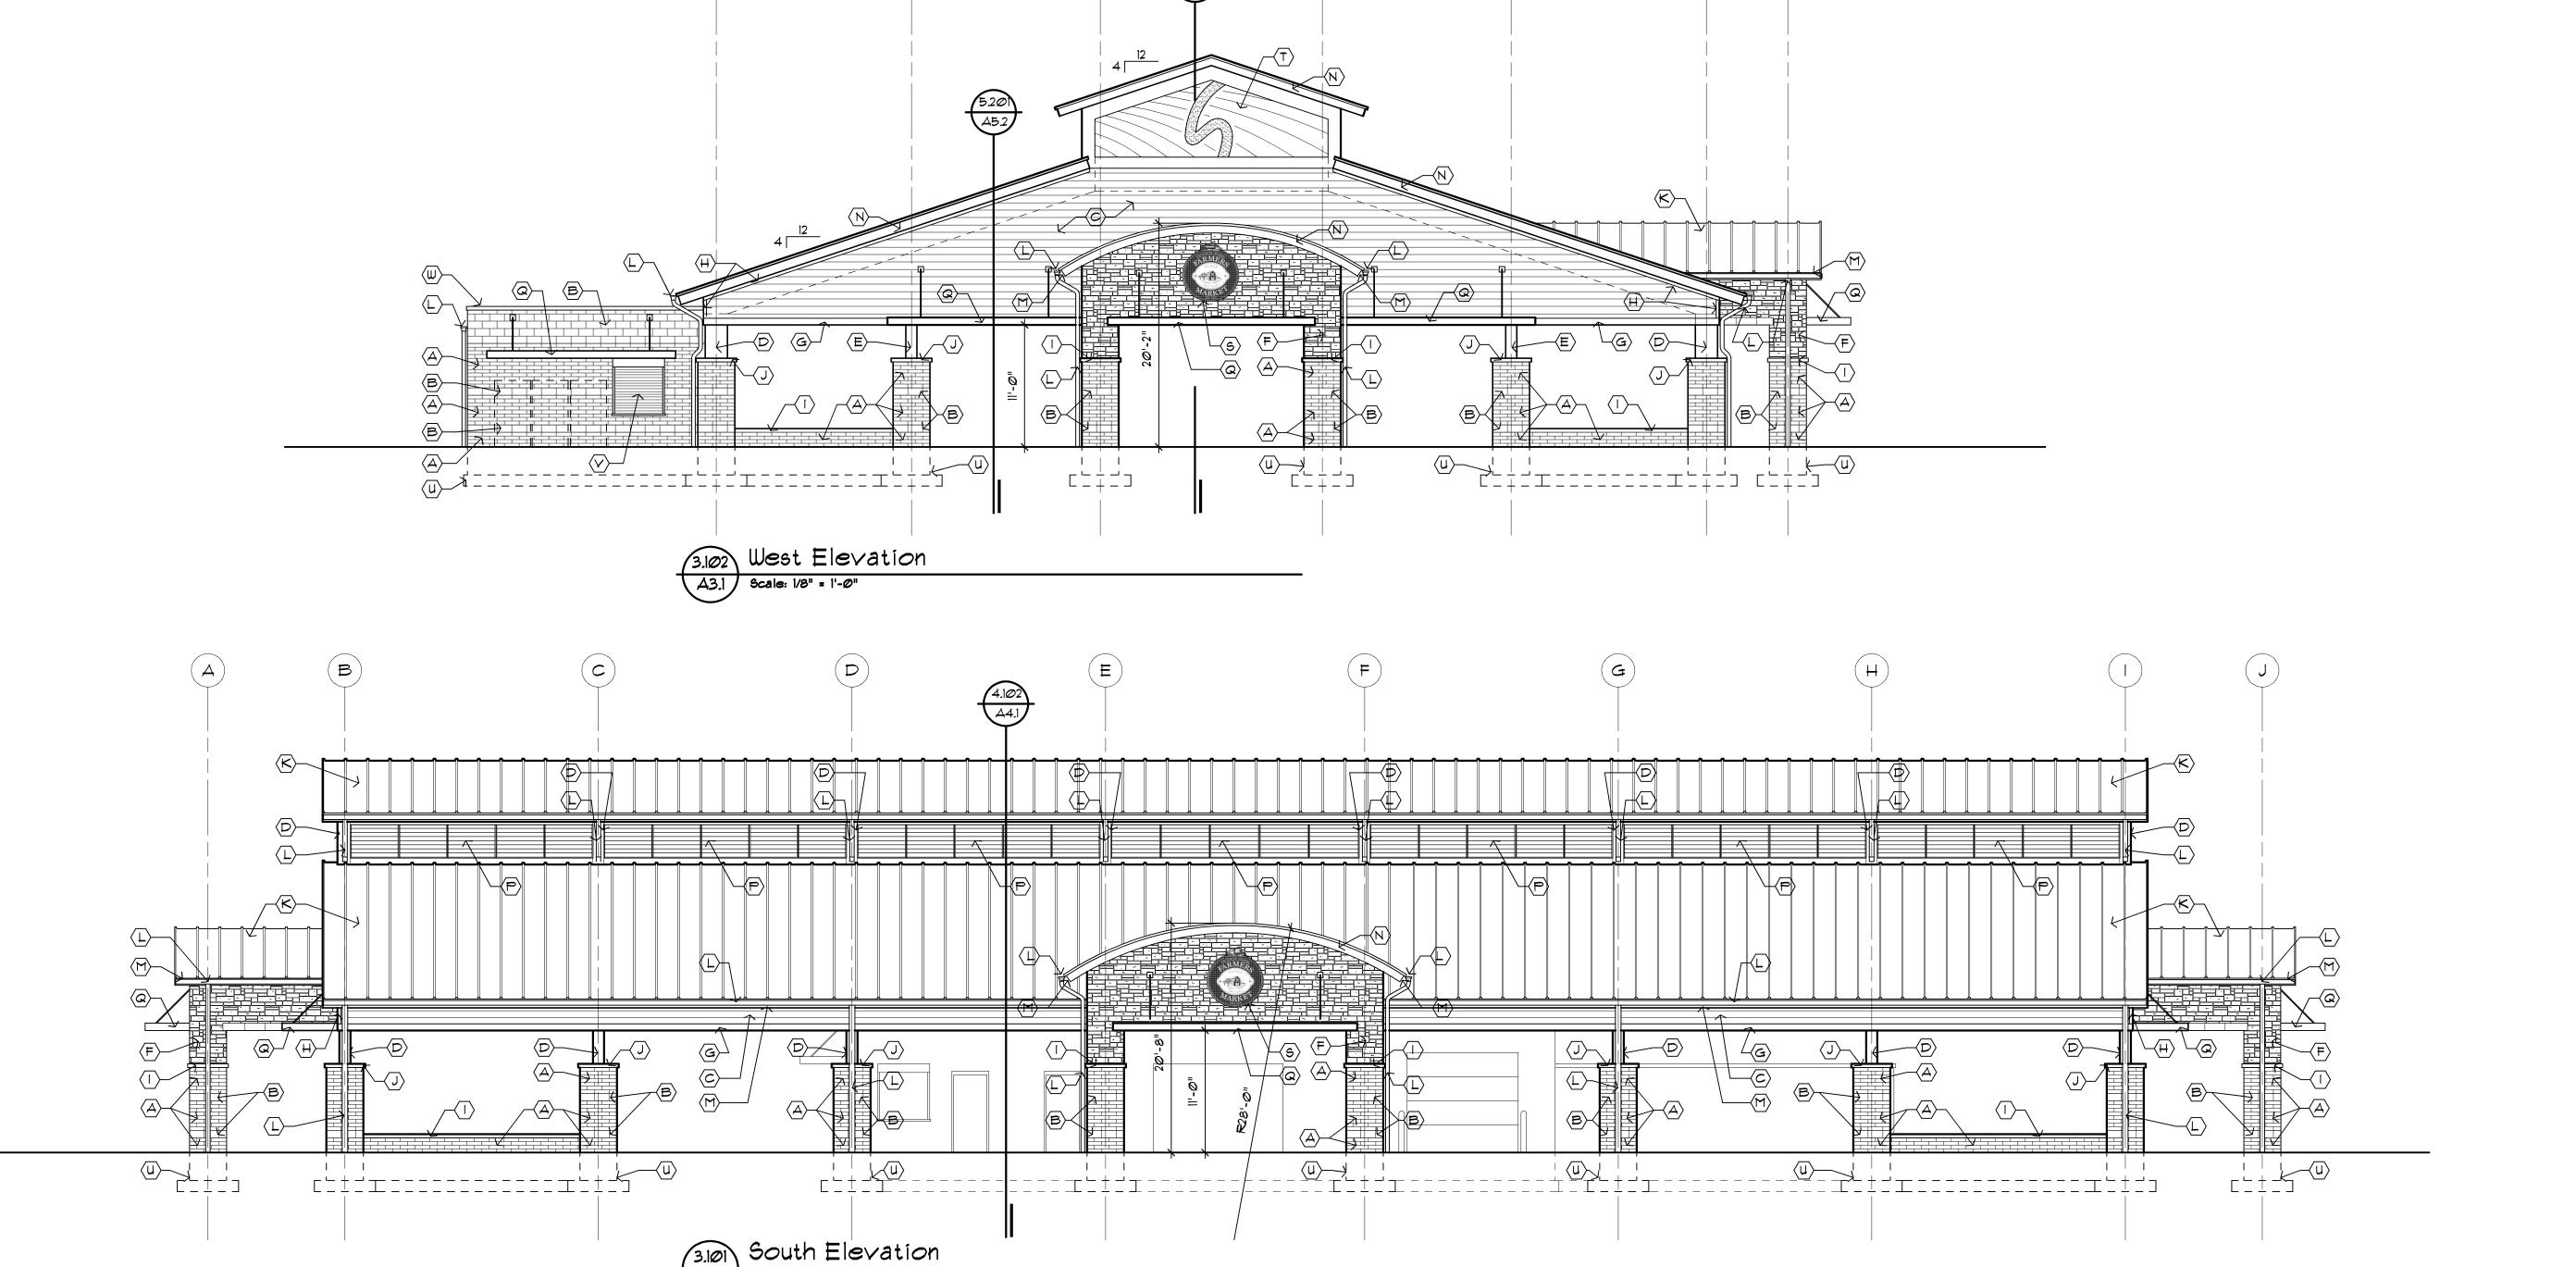
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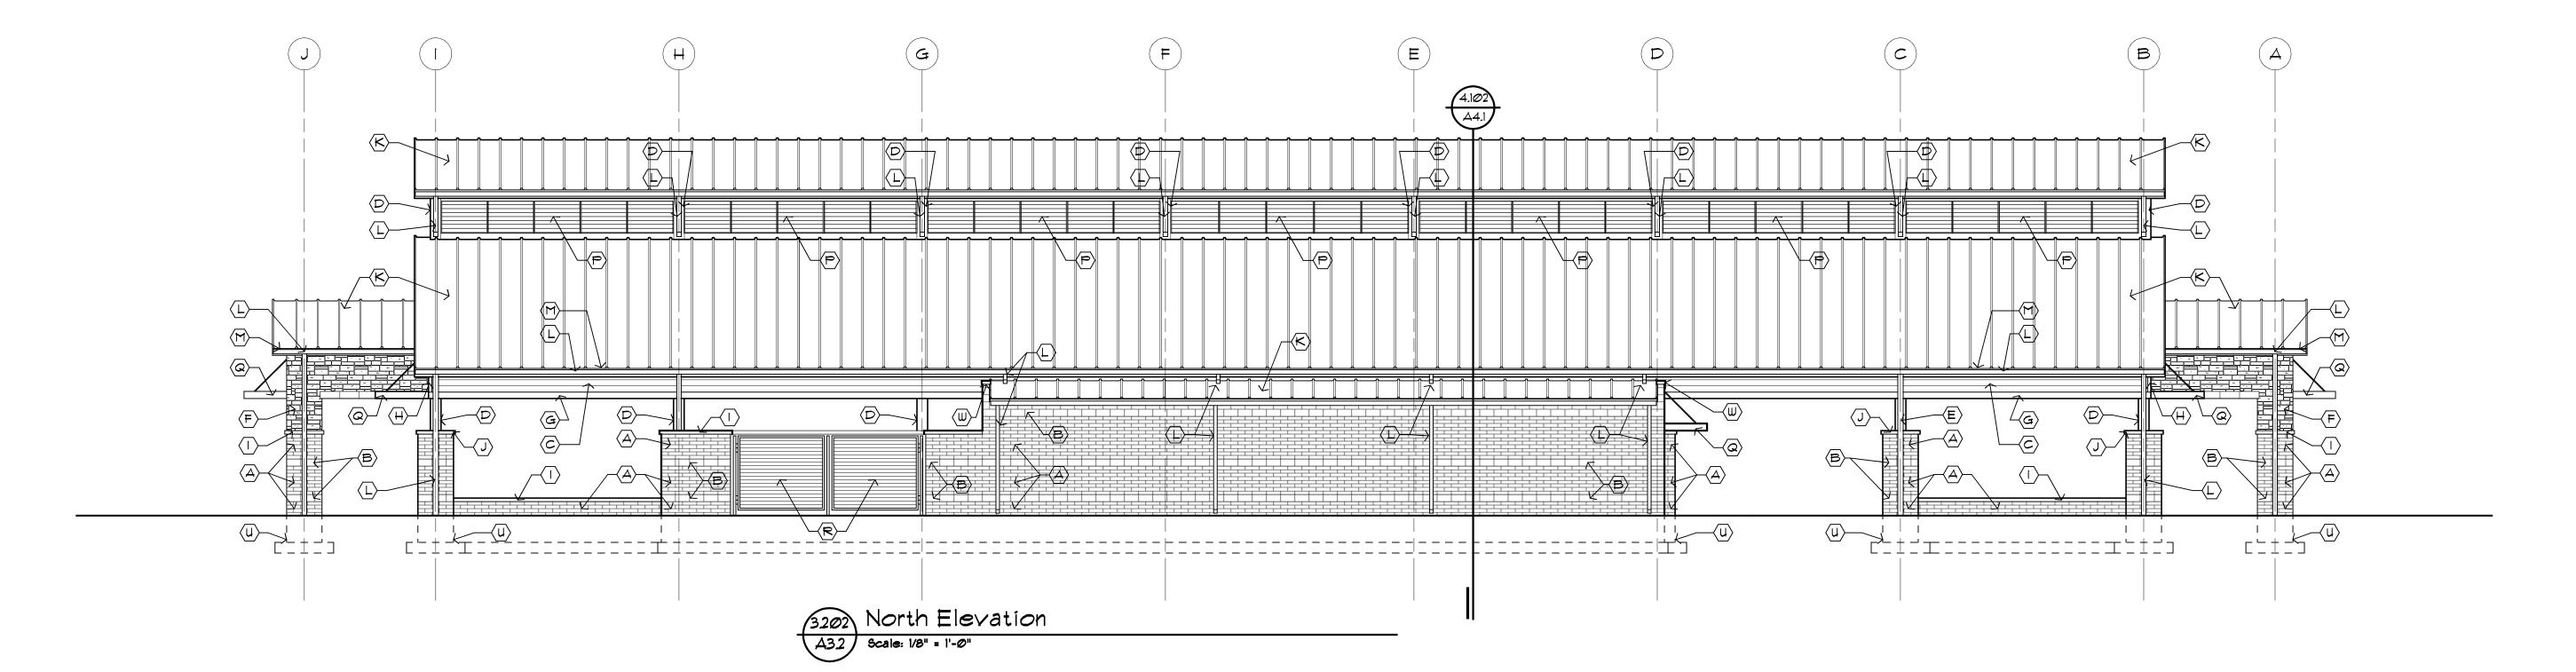
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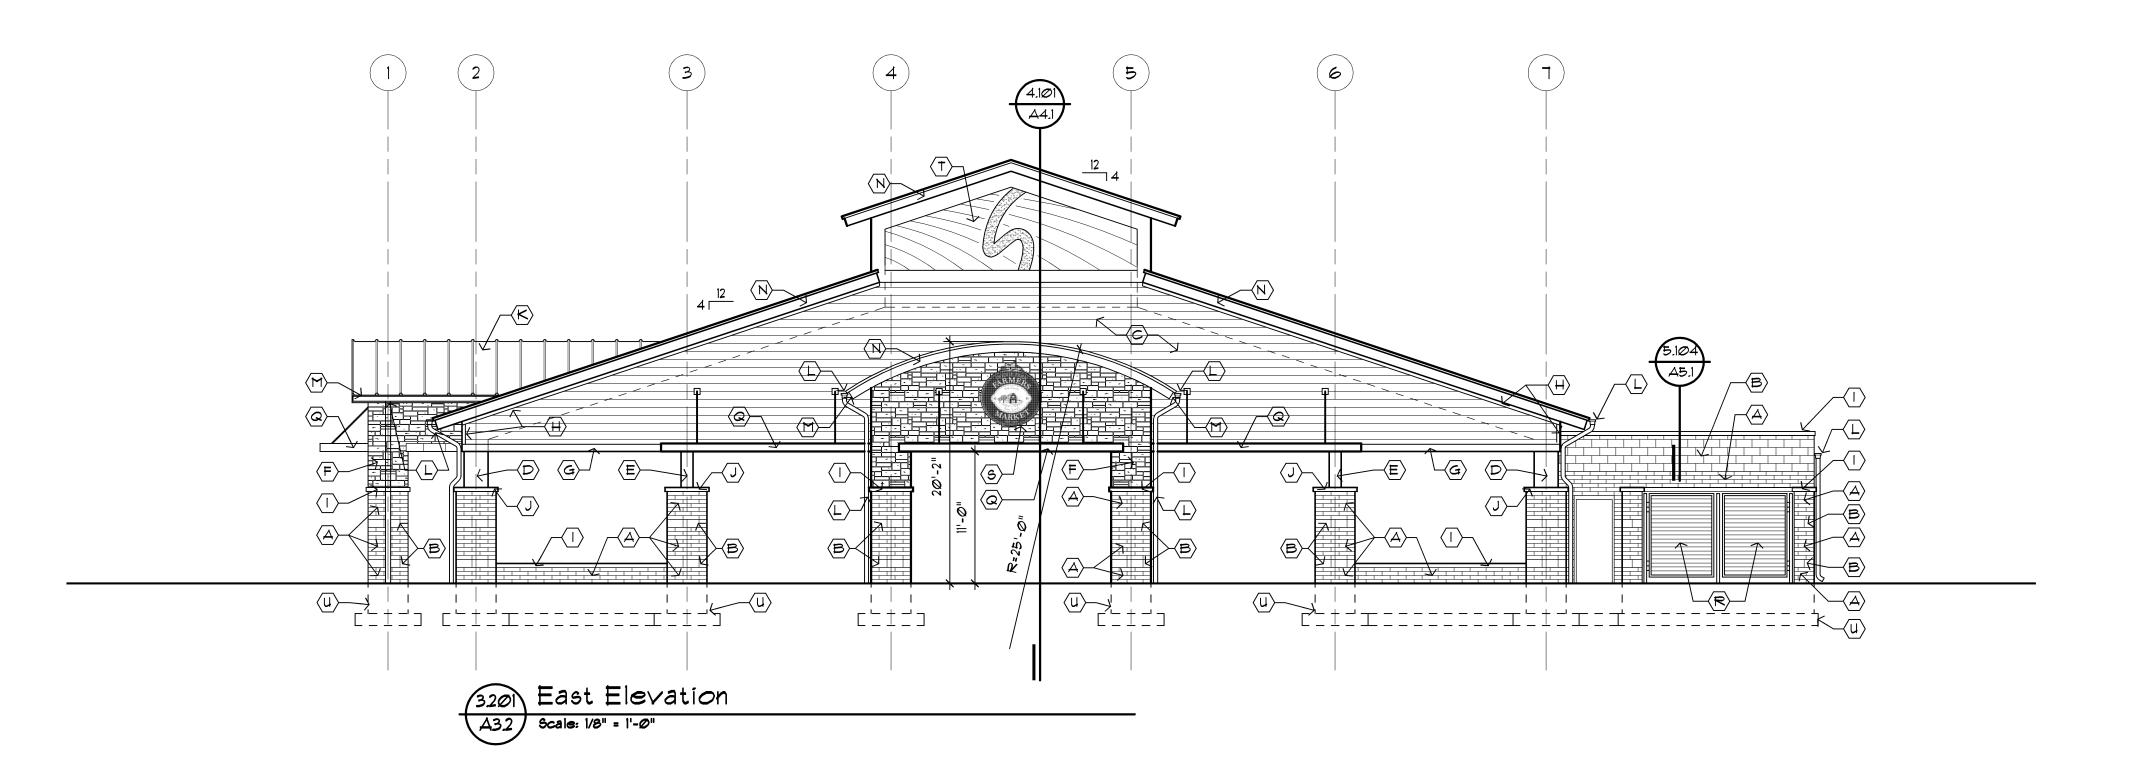


### ELEVATION NOTES

- 4"x8"x16" CMU CONSUMER'S CONCRETE "BELLA BRIK" CINCINNATI BLEND
- B 8"x8"x16" SPLIT FACE CMU ACCENT BAND (MATCH CMU ON EXISTING RESTROOM BUILDING)
- FIBER CEMENT SIDING WOODTONE "RUSTIC SERIES" WINCHESTER BROWN, 1" EXPOSURE
- PRE-ENGINEERED STEEL BUILDING MAIN FRAME COLUMN PAINT (PT-6)
  - PRE-ENGINEERED STEEL BUILDING ENDWALL POST- PAINT (PT-6)
- SIMULATED STONE VENEER "CULTURED STONE" COUNTRY
  - LEDGESTONE BUCKS COUNTY
- (G) 5/4x8 SMOOTH FACE FIBER CEMENT TRIM BOARD PAINT
  (H) 5/4x4 SMOOTH FACE FIBER CEMENT TRIM BOARD PAINT
- (I) 4" PRECAST SILL
- J 4" PRECAST SLOPED PIER CAP
- STANDING SEAM METAL ROOFING BY PRE-ENGINEERED STEEL BUILDING MANUFACTURER (COLONIAL RED)
- ALUMINUM GUTTERS AND DOWNSPOUTS BY PRE-ENGINEERED STEEL BUILDING MANUFACTURER (COLOR T.B.D.)
- METAL FASCIA BY PRE-ENGINEERED STEEL BUILDING MANUFACTURER (COLONIAL RED)

- METAL RAKE BY PRE-ENGINEERED STEEL BUILDING MANUFACTURER (COLONIAL RED)
- PRE-ENGINEERED STEEL BUILDING ENDWALL FRAMING-PAINT (PT-6)
- 3' HIGH STATIONARY STEEL LOUVERS BAKED ENAMEL FINISH (COLOR T.B.D.)
- PRE-MANUFACTRED EXTRUDED ALUMINUM CANOPY PRE-FINISHED (COLOR T.B.D.)
- (R) 1'-0" HIGH PRE-FINISHED ALUMINUM LOUVERED SWING GATE
- (5) "FARMERS MARKET" LOGO SIGN
- TRANSLUCENT RFP PANELS W/ CUSTOM ARTWORK IN ALUMINUM CHANNEL FRAME (ARTWORK TO BE DETERMINED)
- U LINE OF FOUNDATION BELOW
- $\langle \overline{
  m V} 
  angle$  Aluminum security counter grille
- $\langle\overline{\mathbb{W}}\rangle$  ALUMINUM COPING ON TOP OF WALL (COLOR T.B.D.)





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City of Sterling Heights

Dodge Park Improvements

Sterling Heights, Michigan

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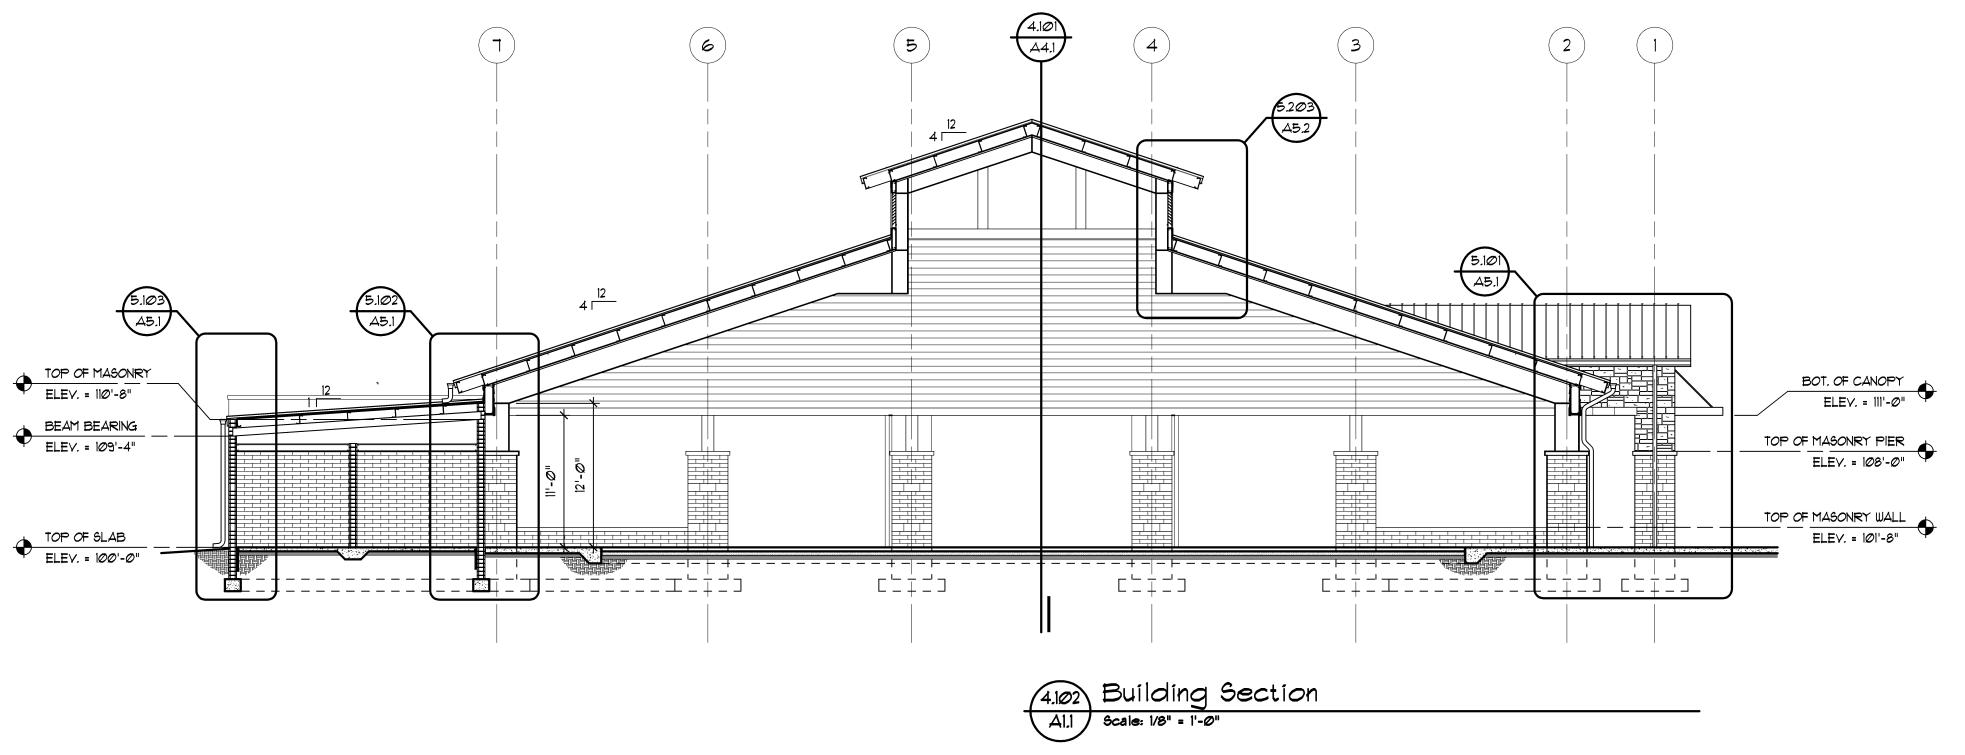
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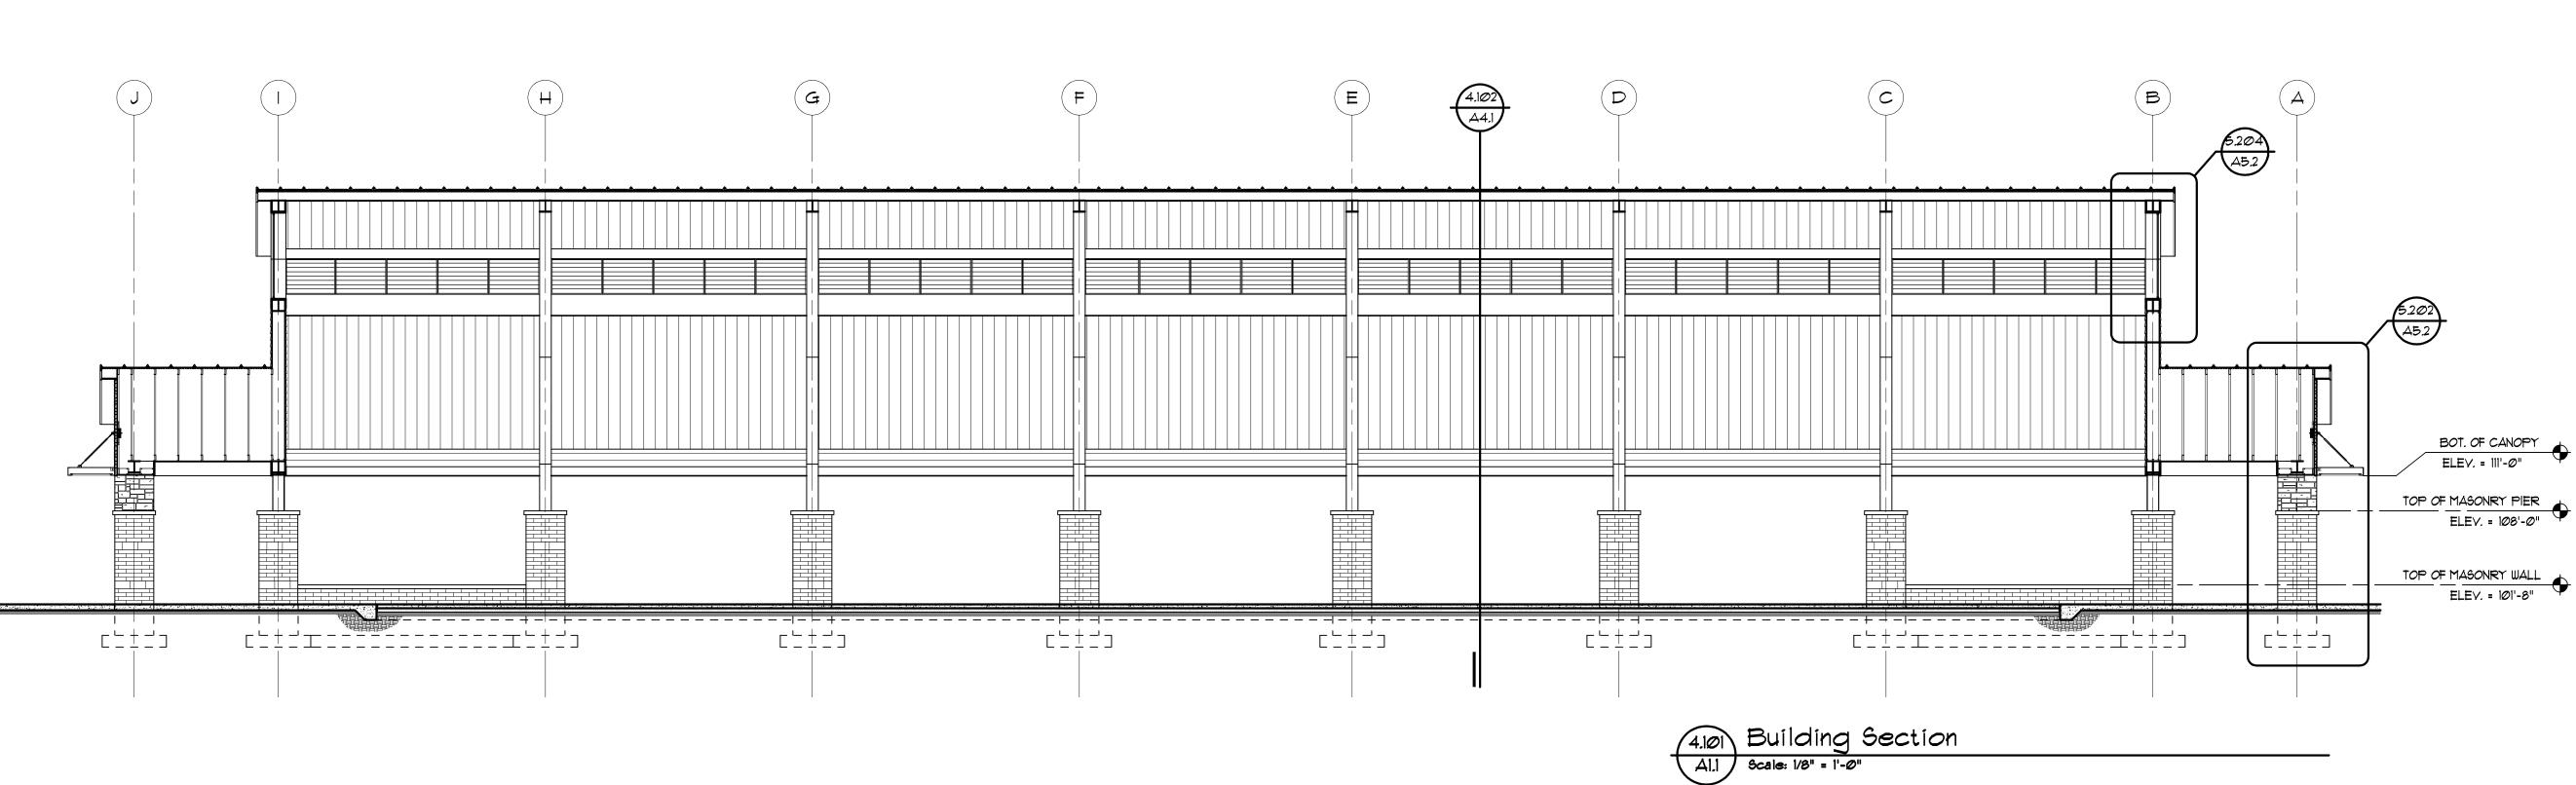
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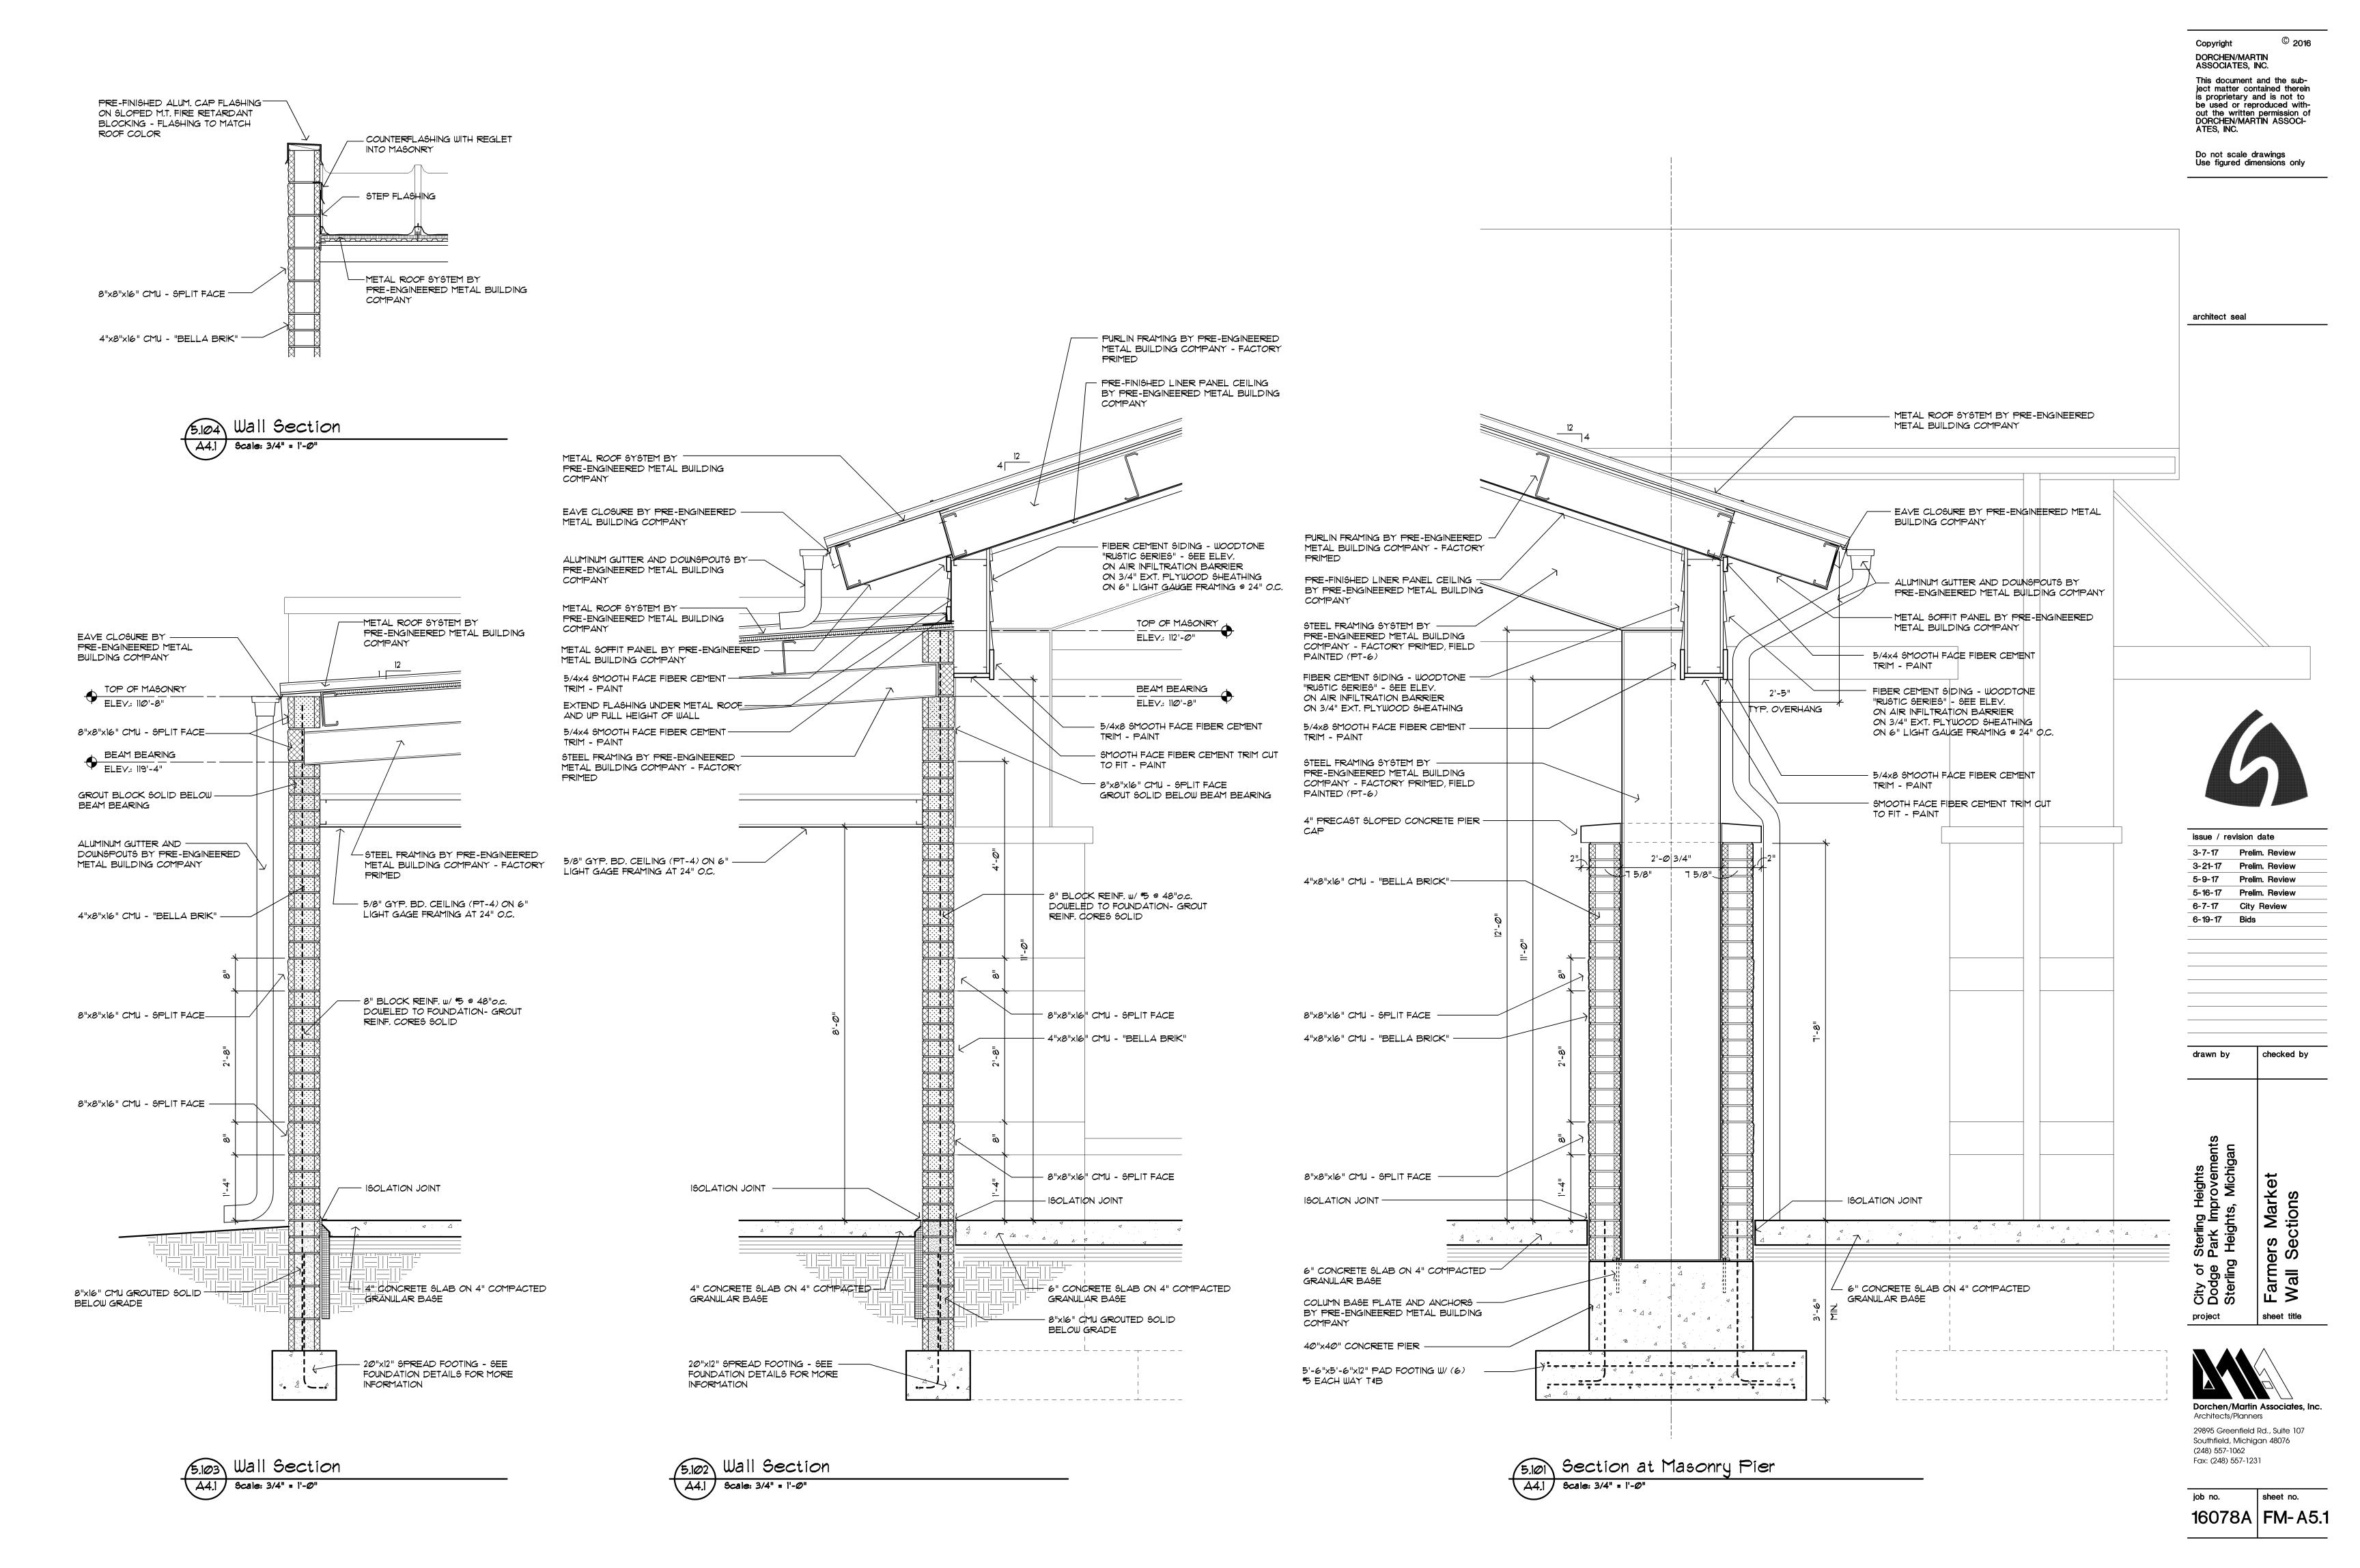
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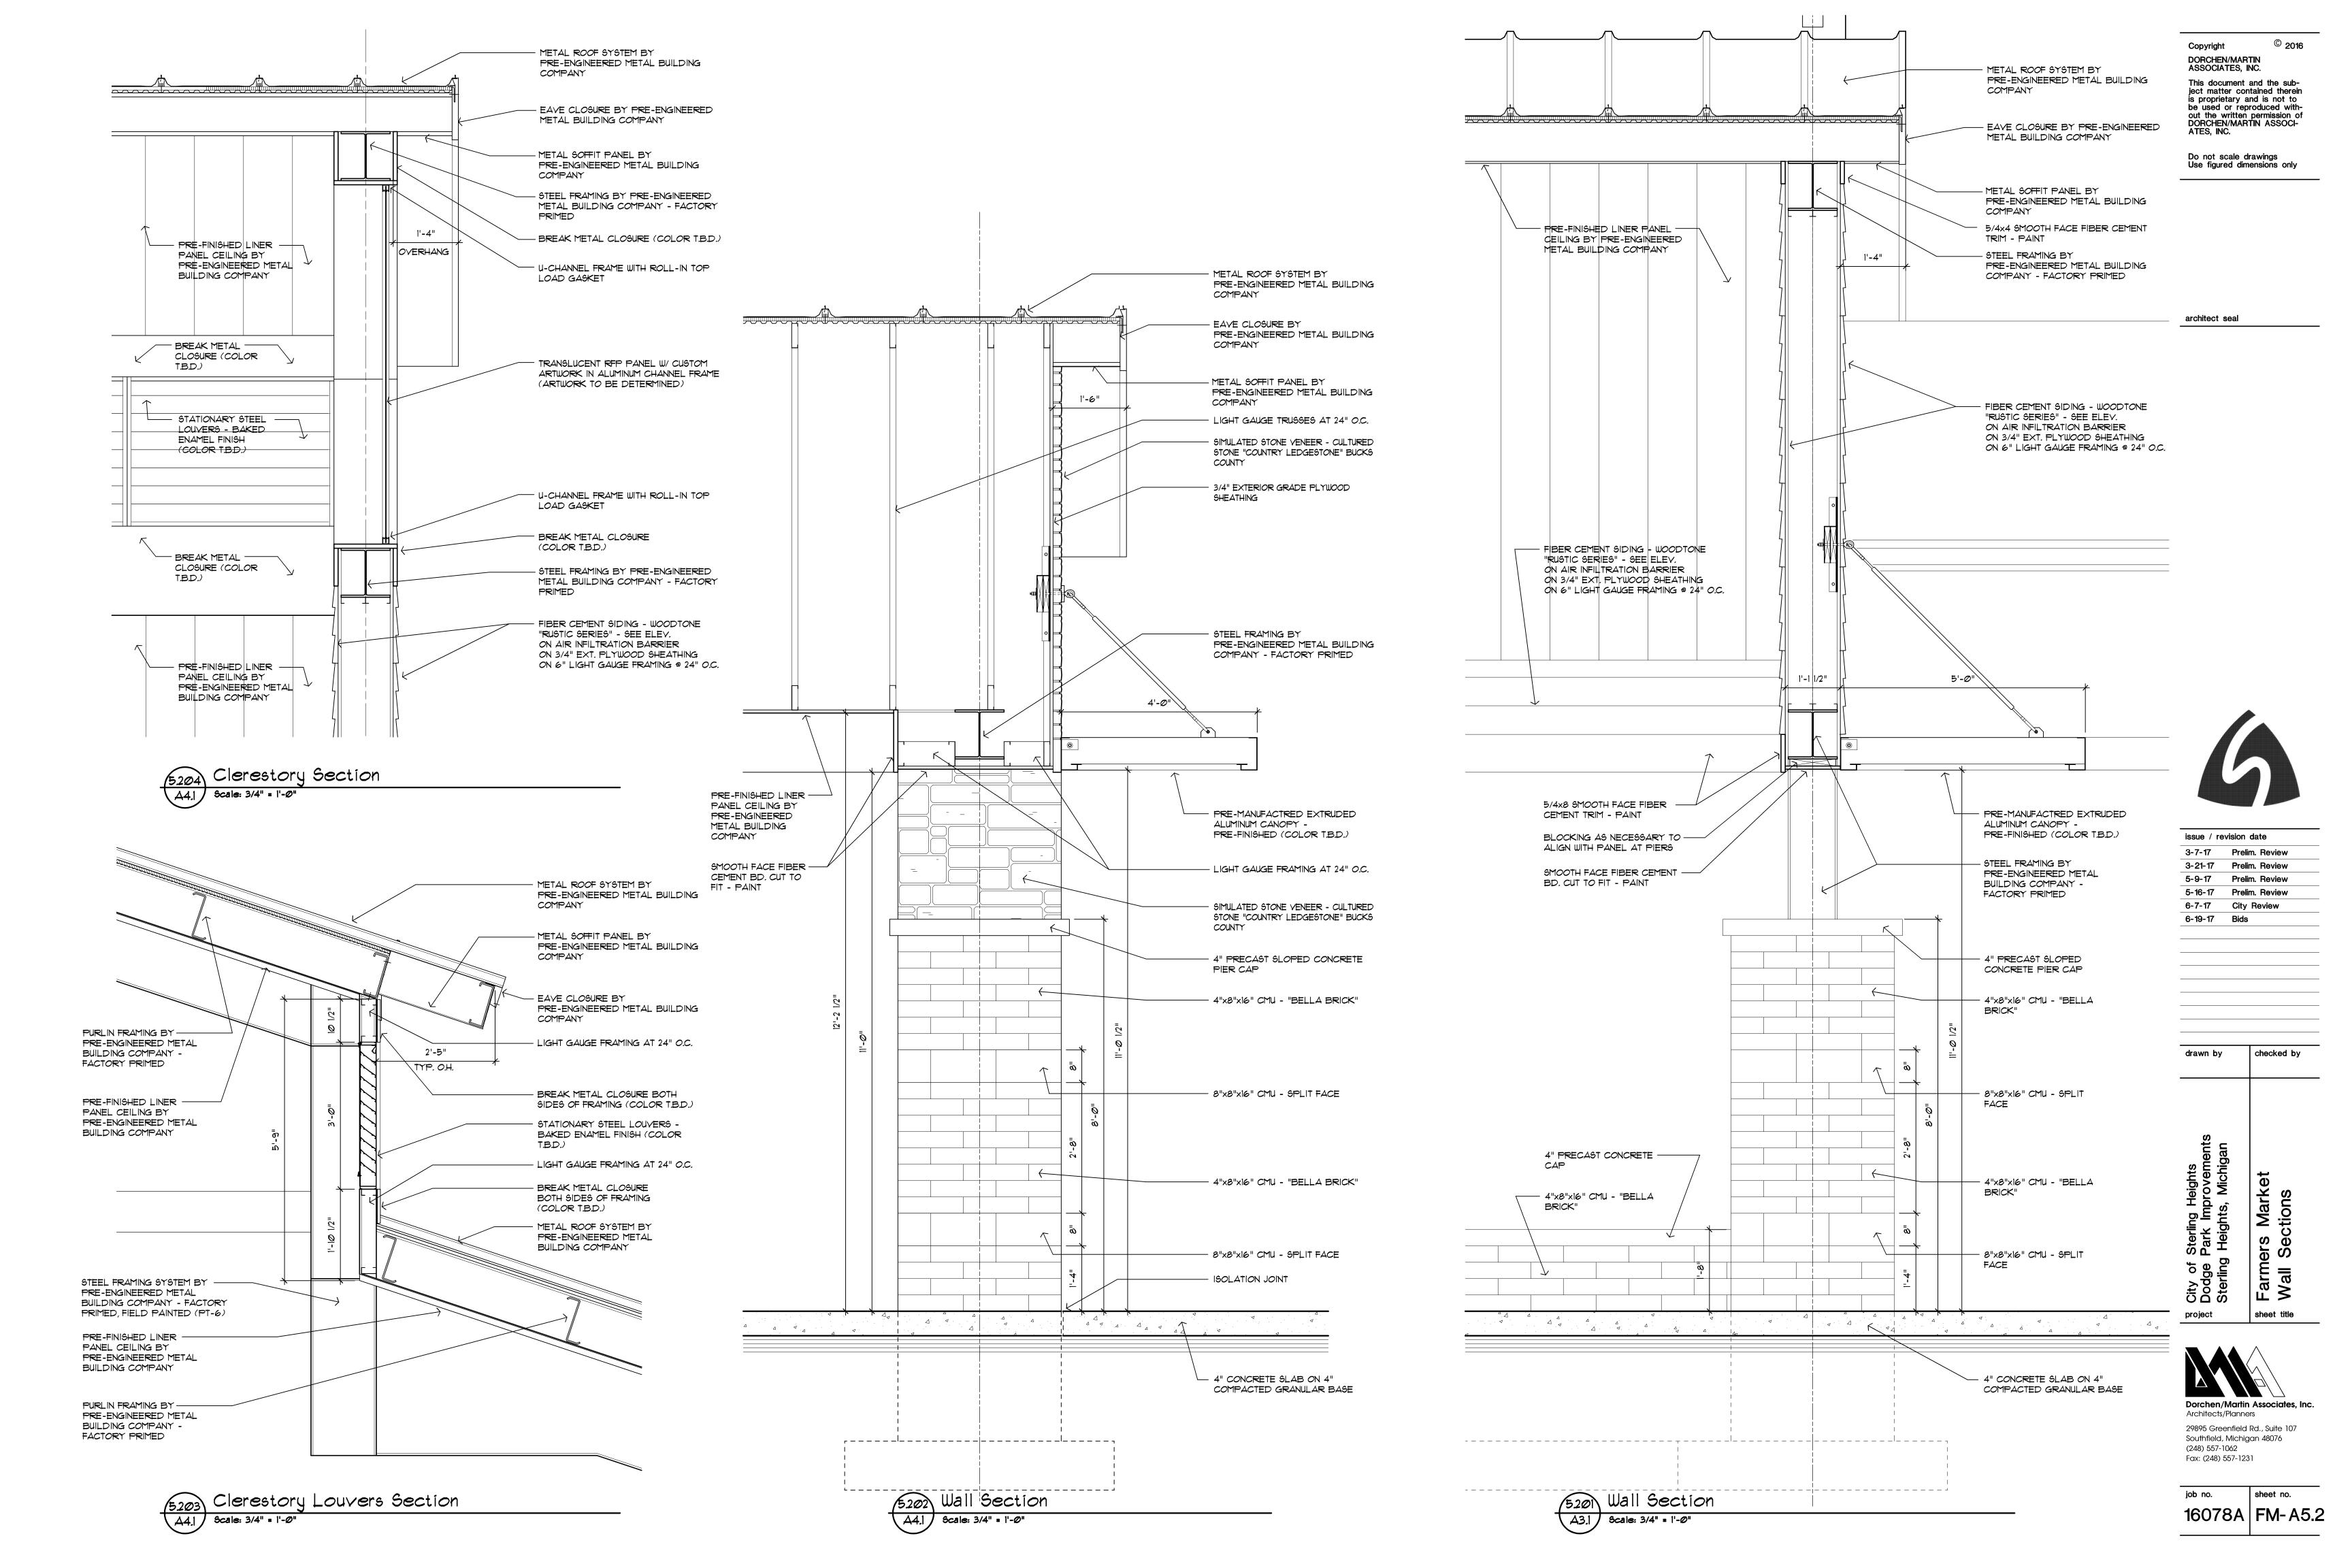
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	ROOM FINISH SCHEDULE										
ROOM	ROOM	FLOOR	BASE	CEILING			WALLS		REMARKS		
NO.	NAME			MTL.	HGT.	FINISH	N	E	S	W	
100	OPEN MARKET	CONC.	-	E.C. / L.P.	VARIES	PT. (PT-6) / PRE-FIN.	MAS.	MAS.	MAS.	MAS.	
101	CONCESSIONS / SKATE RENTAL	CONC.	-	GYP. BD.	8'-Ø"	PT 4	МДБ.	MAS.	MAS.	МДЭ.	
1Ø2	STORAGE	CONC.	-	GYP. BD.	8'-0"	PT 4	MAS.	MAS.	MAS.	MAS.	
103	JANITOR	CONC.	-	E.C.	-	PT 6	МДЭ.	MAS.	MAS.	MAS.	
104	WOMEN'S RESTROOM	R.T 1	G.C.T.	GYP. BD.	8'-0"	PT 4	G.C.T.	G.C.T.	G.C.T.	G.C.T.	SEE INTERIOR ELEVATIONS
105	MEN'S RESTROOM	RT 1	G.C.T.	GYP. BD.	8'-0"	PT 4	G.C.T.	G.C.T.	G.C.T.	G.C.T.	SEE INTERIOR ELEVATIONS
106	GARAGE	CONC.	-	E.C. / L.P.	VARIES	PT. (PT-6) / PRE-FIN.	МДЭ.	MAS.	MAS.	MAS.	

# MATERIAL KEY

ACT = ACOUSTIC CEILING TILE = ACOUSTIC CEILING CANOPY

AL./GL. = ALUMINUM & GLASS = CABINETRY CONC. = CONCRETE CPT. = CARPET = CERAMIC TILE = CERAMIC TILE BASE C.T.B. E.C.

= EXPOSED CONSTRUCTION = EPOXY PAINT FWC. = FABRIC WALL COVERING

G.B. = GYPSUM BOARD G.C.T. = GLAZED CERAMIC TILE / BLOCK = ALUMINUM LINER PANEL

= MASONRY

= PRE-FIN. METAL KNOCK DOWN FRAME

= PLASTIC LAMINATE = PAINT PRE-FIN. = PRE-FINISHED

= RUBBER TILE = STAINED WOOD WD. V.B. = VINYL BASE YCT. = VINYL COMPOSITION TILE = VINYL SHEET FLOORING = YINYL WALL COVERING YWC.

= WALL PROTECTION

= RUBBER BASE

# GENERAL REMARKS

CENTERLINE OF DOOR.

2. ACCESS PANELS, ELECTRICAL PANELS, HYAC REGISTERS & FIRE EXTINGUISHER CABINETS SHALL BE PRE-FINISHED OR PAINTED TO MATCH ADJACENT WALLS OR CEILINGS.

1. FLOOR MATERIAL CHANGES OCCUR AT

3. ALL DOOR & WINDOW FRAMES TO RECEIVE A CONTINUOUS BEAD OF SEALANT AT ALL PERIMETER EDGES.

4. ALL EXPOSED STEEL SHALL BE PAINTED.

5. REFER TO REFLECTED CEILING PLANS AND SECTIONS WHERE CEILING HEIGHT VARIES.

6. ALL GYPSUM BOARD SOFFITS SHALL BE PAINTED.

					D	00	<b>R</b> SC	HED	ULE				
DOOR	DOOR SIZE	DOOR			HDWR.	FRAME			DETAILS			LABEL	CODED
NO.		TYPE	MAT'L.	FINISH	SET	TYPE	MAT'L.	FINISH	SILL	JAMB	HEAD		REMARKS
100	3'-Ø"xT'-Ø"x1-3/4"	Д	H.M.	PAINT	13	<b>=</b> 1	H.M.	PAINT	T.1Ø3	7.1@2	-	-	1, 5, 9, 10, 14
101	3'-Ø"x7'-Ø"x1-3/4"	Д	H.M.	PAINT	14	<b>=</b> 1	H.M.	PAINT	-	7.102	-	-	1, 9, 11, 15
1Ø2	3'-Ø"xT'-Ø"xl-3/4"	В	H.M.	PAINT	15	<b>=</b> 1	H.M.	PAINT	T.1Ø3	7.1@2	-	-	1, 5, 9, 10, 12, 13, 14
103	3'-Ø"xT'-Ø"x1-3/4"	В	H.M.	PAINT	16	<b>F</b> 1	H.M.	PAINT	-	7.102	-	-	1, 7, 9, 10, 12, 13, 14
104	3'-Ø"x7'-Ø"x1-3/4"	В	H.M.	PAINT	16	<b>F</b> 1	H.M.	PAINT	-	7.102	-	-	1, 7, 9, 10, 12, 13, 14
105	10'-0"x10'-0" O.H.	-	STL.	PRE-FIN	-	-	-	PAINT	-	T.101	-	-	14
106	3'-@"x7'-@"x1-3/4"	Д	HM.	PAINT	15	F1	H.M.	PAINT	T.1Ø3	7.1@2	-	-	1, 5, 9, 11, 14

# ABBREVIATIONS

AL./GL. = ALUMINUM & GLASS = ALUMINUM CANOD. = CLEAR ANODIZED = BI-FOLD

= HOLLOW METAL HMKD. = HOLLOW METAL KNOCK DOWN

GL. MANF, = BY MANUFACTURER = OVERHEAD DOOR O.H.

= PRE-FIN. METAL KNOCK DOWN FRAME = PLASTIC LAMINATE PRE-FIN. = PRE-FINISHED

STL. S.\$V. = STAIN & VARNISH (FIELD FINISHED)

WD. = WOOD, SOLID CORE

# CODED REMARKS

1. CLOSER

2. SAFETY GLASS VISION LITE 3. SAFETY GLASS SIDE LITE

4. VINYL CARPET TO TILE JOINER 5. METAL THRESHOLD

6. MARBLE THRESHOLD 7. VINYL REDUCING STRIP 8. TERRAZZO STRIP

9. GROUT FILLED FRAME 10. LIMIT DOOR TO 90° SWING II. DOOR TO OPEN 135°

12. PUSH / PULL 13. WALL MOUNTED DOOR STOP 14. WEATHER STRIPPING

15. KICK DOWN DOOR STOP

8" OR 12"


# GENERAL DOOR & FRAME NOTES

1. ALL DOOR FRAMES ARE TO RECEIVE CONTINUOUS BEAD

OF SEALANT AT PERIMETER - BOTH SIDES.


2. ALL HM. FRAMES SHALL BE GROUT FILLED.

3. ALL HM. DOORS TO BE GALVANIZED, PAINTED

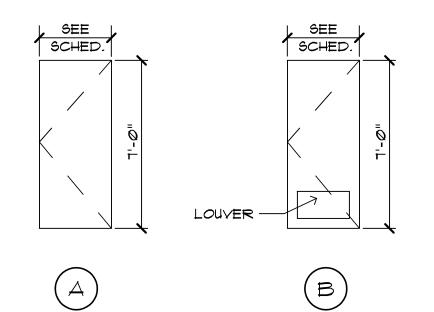





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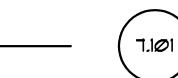


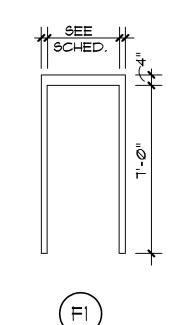FRAME TYPES






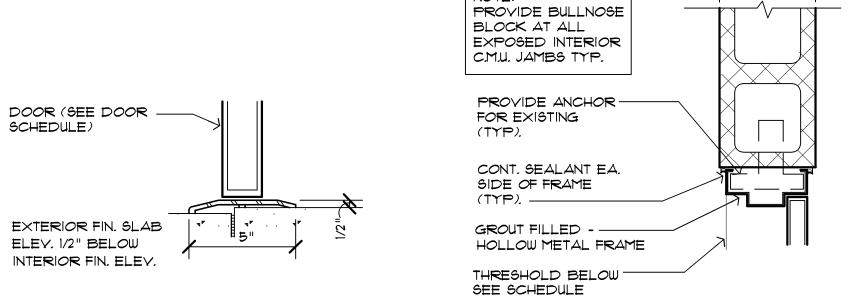

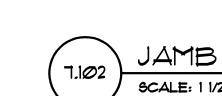

SCALE: 1 1/2" = 1'-0"

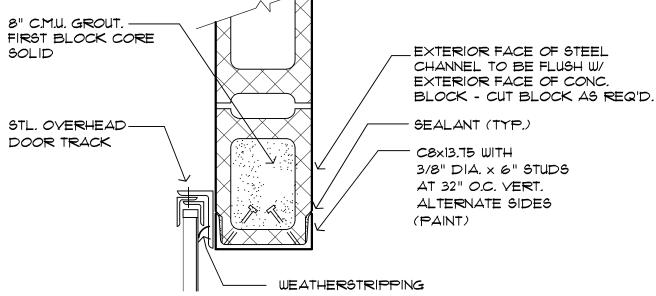

JAMB DETAIL



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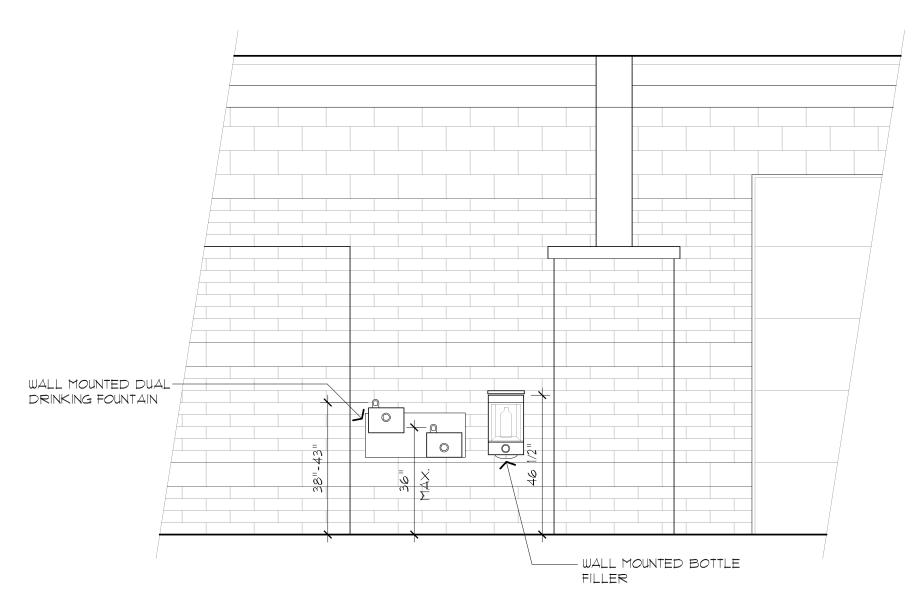
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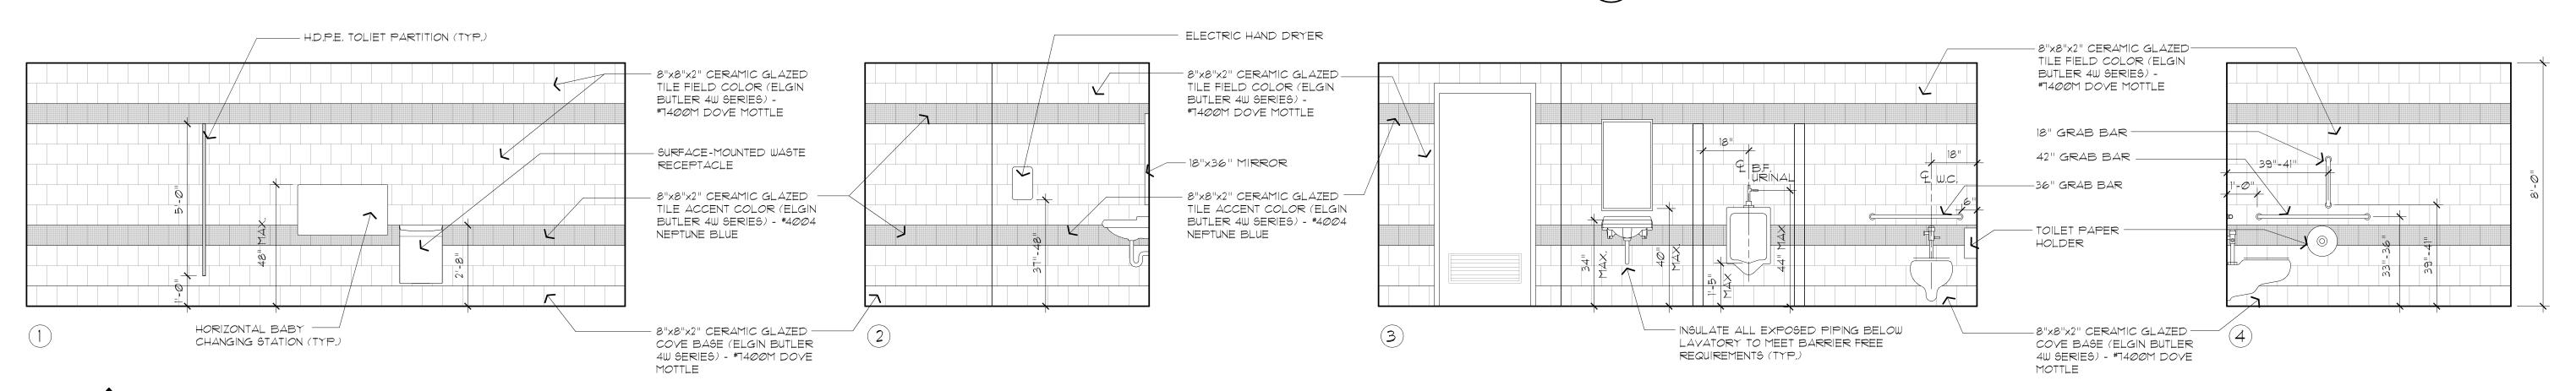
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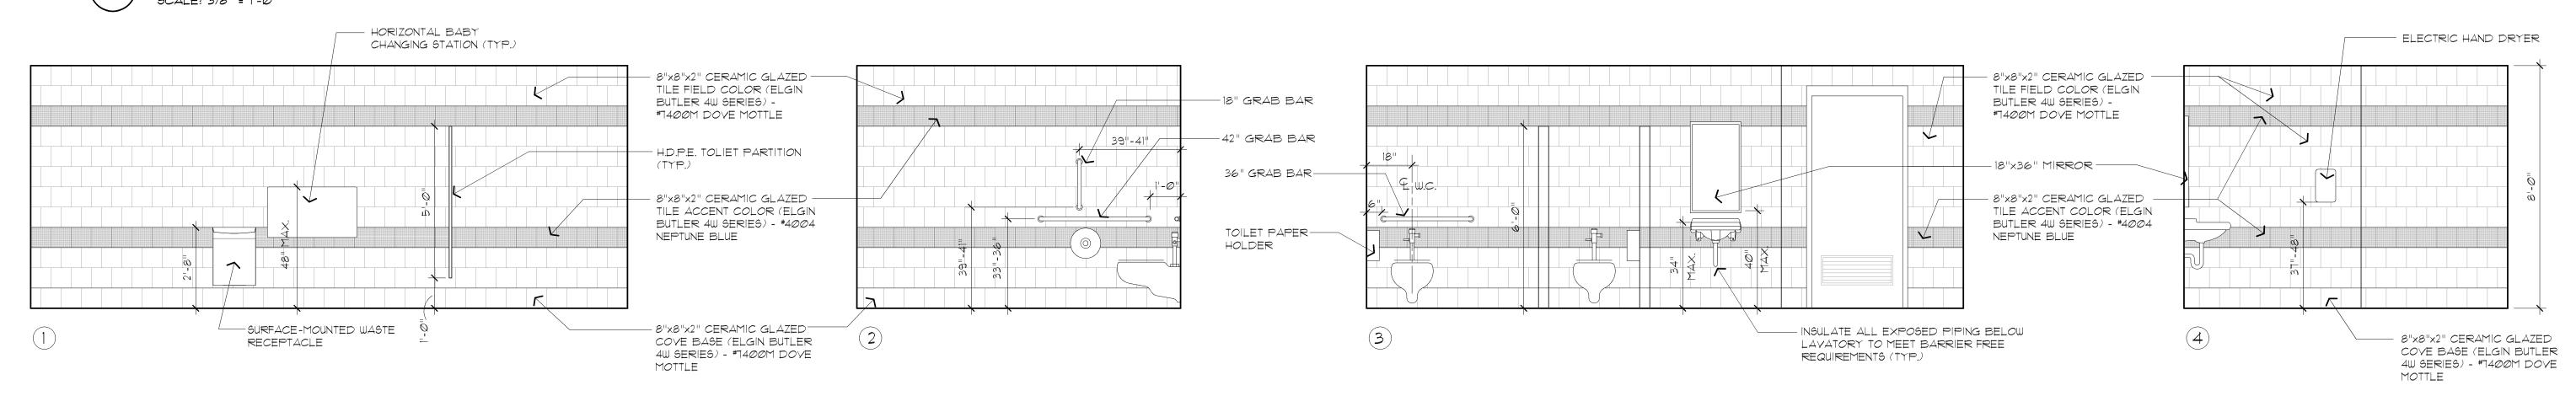





Interior Elevation - Drinking Fountains SCALE: 3/8" = 1'-0"



Interior Elevation - Men's Toilet Room SCALE: 3/8" = 1'-0"



Interior Elevation - Women's Toilet Room SCALE: 3/8" = 1'-0"

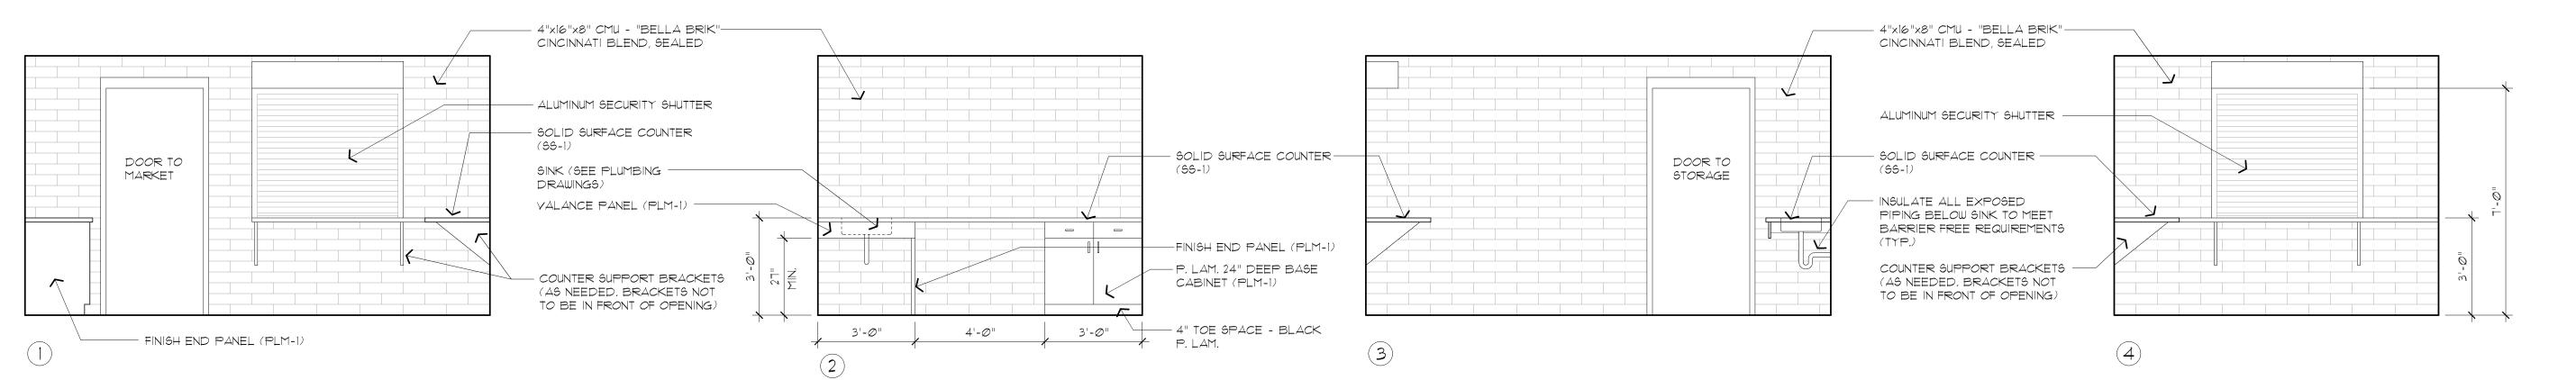

Interior Elevation - Concessions / Skate Rental

SCALE: 3/8" = 1'-0"

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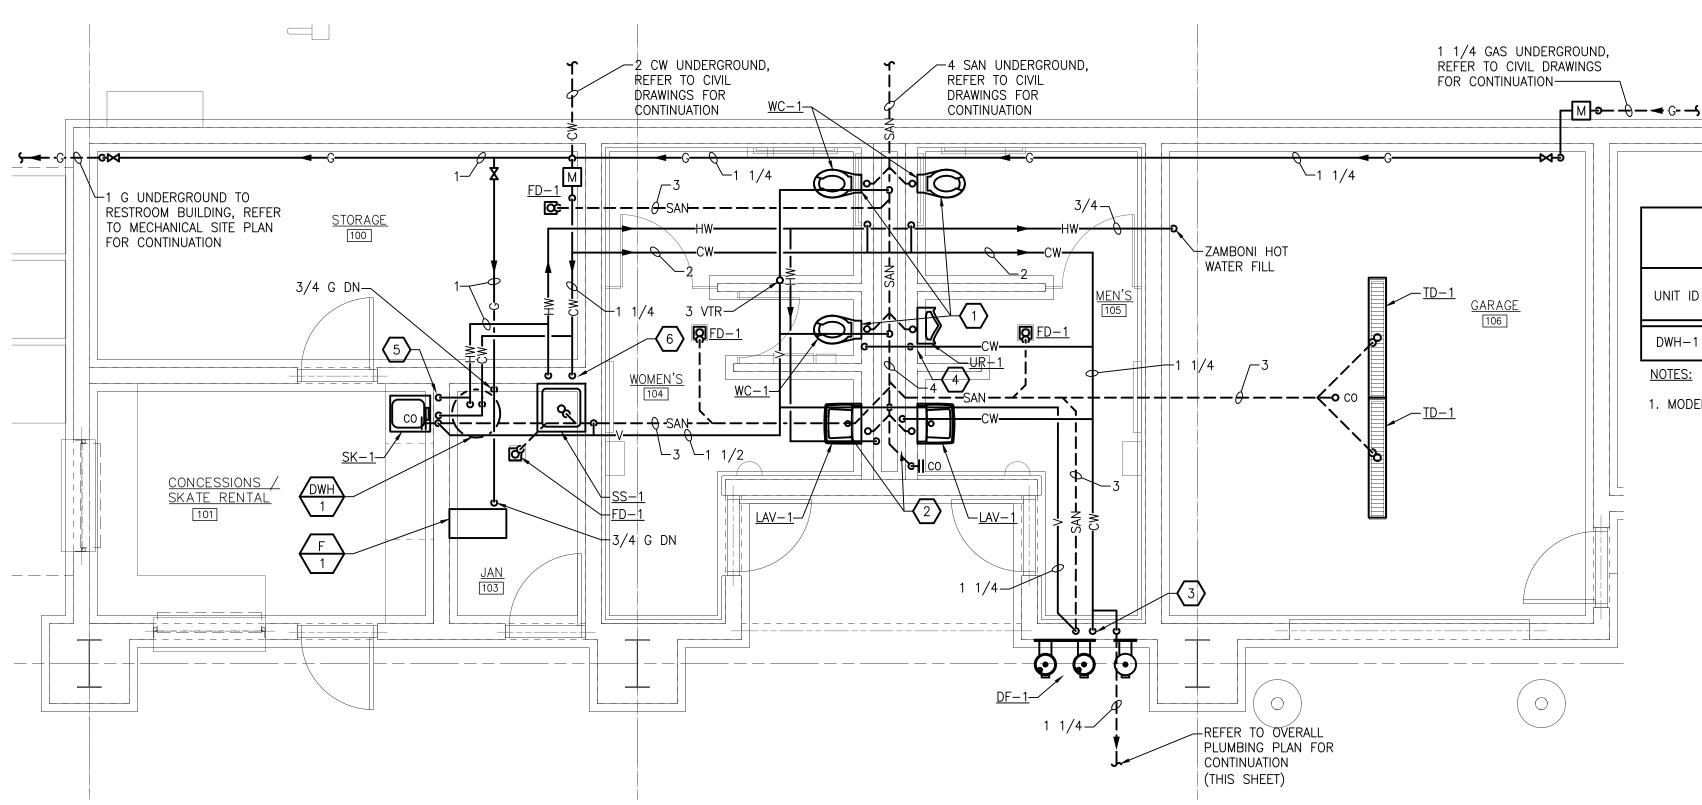
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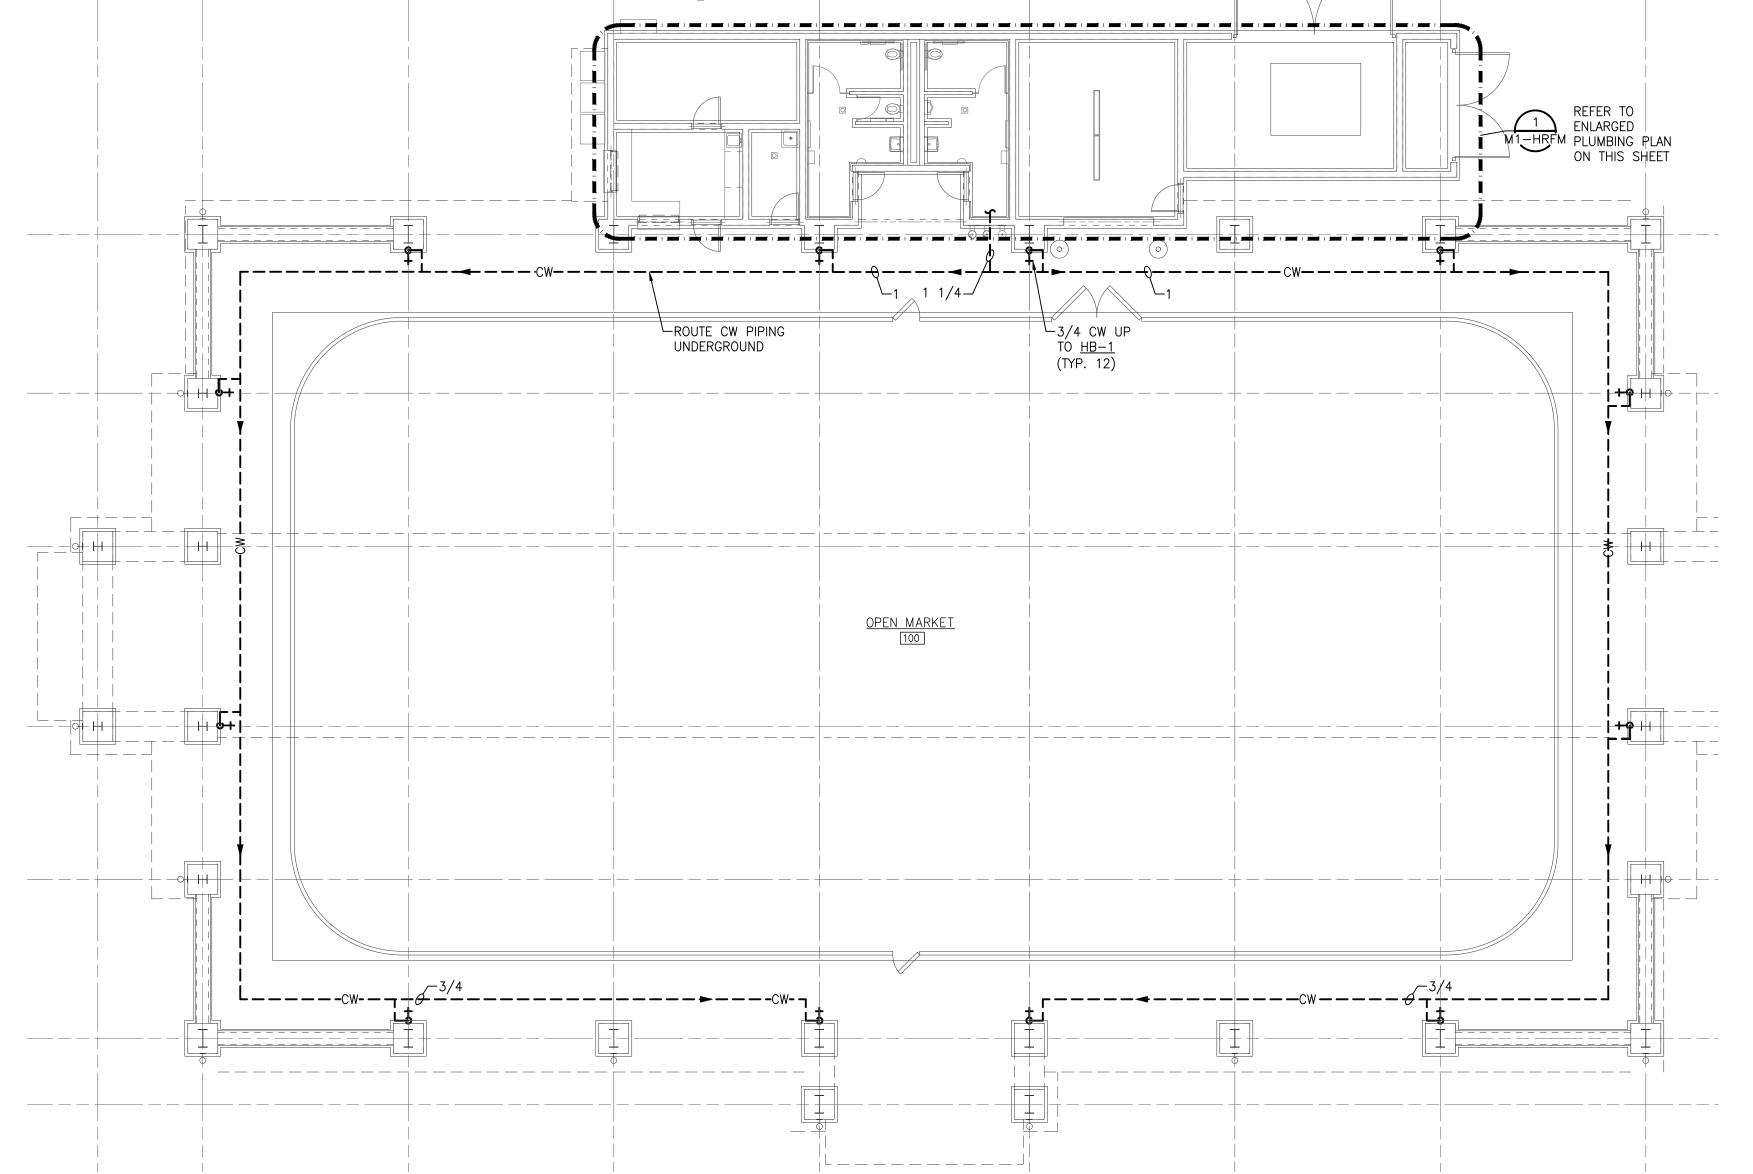


### DOMESTIC ATER HEATER SCHEDULE input Rate RECOVERY FUEL CAPACITY RATE REMARKS MODEL NO. TYPE (GPH) PHASE (GAL) (MBH) NAT. GAS 65 63 120/1ø LG2PV50H653N 48 58

NOTES:

1. MODEL NUMBERS ARE BRADFORD WHITE UNLESS OTHERWISE NOTED.

# ENLARGED PLUMBING NE OR PLAN SCALE: 1/4" = 1'-0"



FARMERS MAR□ET PLUMBING NE□ □ OR□ PLAN

# PLUMBING GENERAL NOTES

- 1. THESE DRAWINGS ARE DIAGRAMMATIC & INDICATE THE GENERAL EXTENT OF THE WORK. PROVIDE PLUMBING SYSTEMS COMPLETE AND PER APPLICABLE CODES INCLUDING REQUIRED COMPONENTS, OFFSETS REQUIRED TO AVOID THE STRUCTURE, ETC.
- 2. REFER TO ARCHITECTURAL PLANS FOR SPECIFICATIONS AND EXACT LOCATIONS OF FIXTURES (STANDARD AND BARRIER FREE), SINKS, ETC. REFER TO FOOD SERVICE PLANS FOR SPECIFICATIONS AND EXACT LOCATIONS OF FOOD SERVICE EQUIPMENT. REFER TO PLUMBING FIXTURE SCHEDULE FOR CONNECTION SIZES, ACCESSORIES, AND ADDITIONAL INFORMATION.
- 3. CONTRACTOR SHALL BE RESPONSIBLE FOR COMPLIANCE WITH THE STATE AND LOCAL COUNTY DEPARTMENT OF HEATH CROSS CONTAMINATION CODE REQUIREMENTS.
- 4. CONTRACTOR SHALL COORDINATE THE INSTALLATION OF PLUMBING AND PIPING WITH THE WORK OF ALL OTHER TRADES.
- PIPING SHALL NOT BE LOCATED OVER ELECTRICAL EQUIPMENT/PANELS. PROVIDE REQUIRED CLEARANCE IN FRONT/ABOVE OF ELECTRICAL EQUIPMENT. PIPING SHALL NOT INTERFERE WITH ELECTRICAL EQUIPMENT CLEARANCE.
- 6. PIPING SHALL NOT BE INSTALLED IN A LOCATION THAT RESTRICTS THE ACCESS TO MECHANICAL DEVICES REQUIRING ACCESS.
- 7. CONTRACTOR SHALL PROVIDE SUPPLEMENTARY STEEL AS REQUIRED FOR THE PROPER SUPPORT OF ALL MECHANICAL SYSTEMS.
- 8. HOT AND COLD WATER PIPING RUN-OUTS TO LAVS AND SINKS SHALL BE 3/4" UNLESS NOTED OTHERWISE. REFER TO SPECIFICATIONS FOR FIXTURE CONNECTION SIZES. PROVIDE BRANCH LINE ISOLATION VALVES ON DOMESTIC PIPING TO EACH GROUP OF FIXTURES AND TOILET ROOMS. PROVIDE FULL OPEN VALVES PER PLUMBING CODE.
- 9. PLUMBING VENT PIPING THRU THE ROOF SHALL BE LOCATED 10'-0" FROM ANY FRESH AIR INTAKE LOCATION AND A MINIMUM OF 18" CLEAR FROM THE INSIDE FACE OF PARAPET.
- 10. PROVIDE CODE REQUIRED CLEARANCE/ACCESS DOORS FOR VALVES/CLEANOUTS LOCATED IN WALLS OR ABOVE HARD CEILINGS, AND LOCATIONS OF CLEANOUTS INSTALLED IN STORM AND SANITARY PIPING. COORDINATE LOCATIONS WITH ARCHITECT. PROVIDE CLEANOUTS AT THE BASE OF ALL STACKS.
- 11. RUN ALL SANITARY PIPING AT 1/8" PER FOOT MINIMUM. UNLESS OTHERWISE NOTED MINIMUM UNDERGROUND PIPE SIZE SHALL BE 3".
- 12. PROVIDE VALVES ON ALL BRANCH PIPING SERVING GROUP TOILET ROOMS. PROVIDE FULL OPEN VALVES AND SHUT OFF VALVES PER PLUMBING CODE.
- 13. PROVIDE "SURESEAL" TRAP SEAL PROTECTION ON ALL FLOOR DRAINS AND TRAPS SUBJECT TO EVAPORATION.
- 14. ALL CORING THRU WALLS, ROOF AND FLOORS SHALL BE BY MECHANICAL CONTRACTOR. COORDINATE LOCATIONS/SIZES OF ALL FLOOR, WALL PENETRATIONS, AND SLEEVES WITH STRUCTURAL/ARCHITECTURAL TRADES AND SEAL PER SPECIFICATIONS.
- 15. PROVIDE A UNIONS, ISOLATION VALVE, TEE AND MIN. 6" LONG DIRT LEG WITH CAP AT EACH GAS SUPPLY CONNECTION.

# □E□ED NOTES

- 1) ROUTE 4" SANITARY, 2" VENT AND 1 1/4" CW DOWN TO WATER CLOSET. 2 ROUTE 1/2" SANITARY, 1 1/4" VENT, 1/2" HOT WATER DOWN TO LAVATORY.
- ROUTE 2" SANITARY, 1 1/2" VENT AND 1/2" COLD WATER DOWN TO DRINKING FOUNTAIN.
- ROUTE 2" SANITARY, 1 1/2" VENT AND 3/4" COLD WATER DOWN TO URINAL FOUTE 1 1/2" SANITARY, 1 1/4" VENT, 1/2" COLD WATER AND 1/2" HOT WATER DOWN TO SINK
- 6 ROUTE 3" SANITARY, 1 1/2" VENT, 3/4" COLD WATER AND 3/4" HOT WATER DOWN TO SERVICE SINK

	PLUMBING FIXTURE SCHEDULE										
TAG	BARRIER FREE	ITEM	PI WASTE	PE CONNEC	CTION SIZ	ES HW	MANUFACTURER & MODEL NO.	ACCESSORIES			
FD-1	_	FLOOR DRAIN	3"	1 1/2"	_	_	ZURN: Z-415-B				
DF-1	-	BI-LEVEL DRINKING FOUNTAIN WITH BOTTLE FILLER	2"	1 1/2"	1/2"	_	MOST DEPENDABLE MODEL:485EZWM MODEL COLOR BLUE	10105 WM BOTTLE FILLER			
LAV-1	Y	WALL MOUNTED LAVATORY	1 1/2"	1 1/2"	1/2"	1/2"	AMERICAN STANDARD: LUCERNE	FAUCET: AMERICAN STANDARD: RELIANT 3. DECK MOUNTED SOAP DISPENSER: AMERICAN STANDARD MODEL # 4503.115. PROVIDE ASSE 1070 MIXING VALVE.			
SK-1	-	SINGLE COMPARTMENT SINK	2"	1 1/2"	1/2"	1/2"	ELKAY: CELEBRITY, MODEL # BCRA150C	FAUCET: ELKAY, MODEL# LKD208813C.			
SS-1	-	SERVICE SINK	3"	1 1/2"	3/4"	3/4"	FIAT: MSB-2424	FAUCET: FIAT # 830-AA W/VACUUM BREAKER, STAINLESS STEEL GRID STRAINER, PAIL HOOK AND HOSE THREAD, HOSE AND MOP HANGERS.			
UR-1	Y	WALL MOUNTED URINAL	2"	1 1/2"	3/4"	_	KOHLER: DEXTER. MODEL: K-5016-ET	FLUSH VALVE: KOHLER K-13521, 1.0 GPF			
WC-1	Y	WALL MOUNTED WATER CLOSET	4"	2"	1"	-	KOHLER: KINGSTON. MODEL: K-4325	FLUSH VALVE: KOHLER K-13516, 1.6 GPF			
TD-1	_	TRENCH DRAIN	3"	-	_	_	ZURN Z890	_			

- 1. SUPPLY ALL FIXTURES WITH LOOSE KEY STOPS.
- 2. PROVIDE ALL ACCESSORIES NECESSARY FOR COMPLETE AND OPERABLE INSTALLATION.
- 3. PROVIDE CARRIERS FOR ALL FIXTURES PER MANUFACTURER'S RECOMMENDATIONS.
- 4. WHERE REQUIRED AND WHERE DESIGNATED, FIXTURES SHALL BE FURNISHED AND INSTALLED IN ACCORDANCE TO THE LATEST EDITION OF "THE BARRIER" FREE DESIGN REQUIREMENTS OF THE STATES CONSTRUCTION CODE.
- 5. REFER TO ARCHITECTURAL ELEVATIONS FOR EXACT LOCATION/MOUNTING HEIGHT OF ALL FIXTURES.



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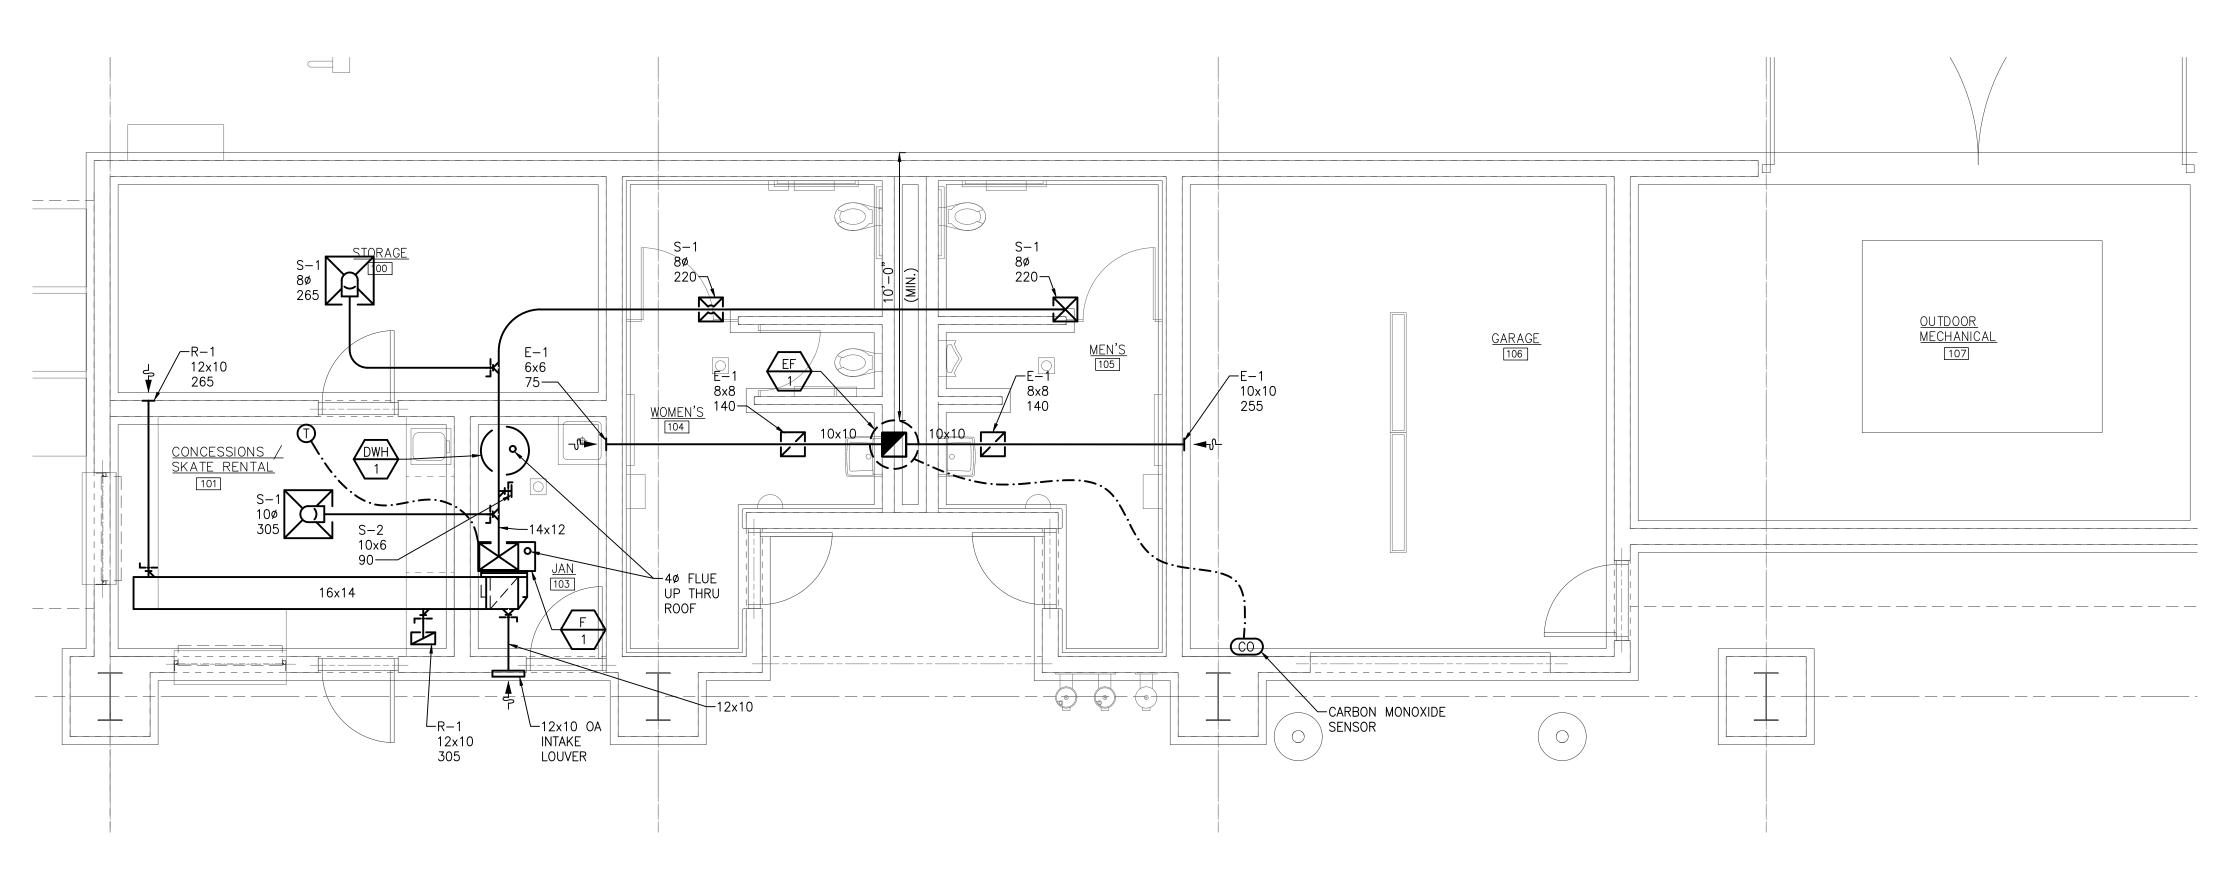
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16078A M3.1



# FARMERS MAR ET SHEET METAL NE OR PLAN SCALE: 1/4" = 1'-0"

	EXHAUST FAN SCHEDULE														
	055) 4110	7.05	0.51.4	ESP	FAN		MOT	OR		ELECT	RICAL		25.41240		
UNII ID	INIT ID SERVING TYPE		CFM	(IN WG)	RPM	ВНР	HP	RPM	DRIVE TYPE	VOLTS	PHASE	MODEL NO.	REMARKS		
EF-1	FARMERS MARKET	CENTRIFUGAL	610	0.25	1,300	.07	1/4	1,300	DIRECT	120	1	G-095-VG			

## NOTES:

- 1. MODEL NUMBERS ARE GREENHECK UNLESS OTHERWISE NOTED.
- 2. PROVIDE WITH GRAVITY BACKDRAFT DAMPER.
- 3. CONTROL SHALL BE BY MANUAL MOTOR STARTER PROVIDED BY ELECTRICAL TRADES.

	FURNACE SCHEDULE														
UNIT ID	SERVICE	SUPPLY CFM	OA CFM	ESP	BLOWER HP	HE INPUT (MBH)				FUSE SIZE (AMPS)	VOLTS	PHASE	MODEL NO.	REMARKS	
F-1	CONCESSIONS & RESTROOMS	1,000	300	0.25	1/5	66	54	80%	3.1	15	120	1	ML180UH070		

# NOTES:

1. MODEL NUMBERS ARE LENNOX UNLESS OTHERWISE NOTED.

	GRILLE, REGISTER AND DIFFUSER SCHEDULE														
UNIT ID	T ID FACE NECK SIZE MOUNTING ACCESSORY FINISH MATERIAL MODEL NO. REMARKS														
S-1	24x24	SEE PLANS	NOTE 2	-	WHITE	STEEL	SPD								
S-2	NECK+2"	SEE PLANS	DUCT	-	WHITE	STEEL	520D								
R-1	14x12	22x10	NOTE 2	ı	WHITE	STEEL	530								
E-1	E-1 NECK+2" SEE PLANS NOTE 2 - WHITE STEEL 510Z														

- 1. MODEL NUMBERS ARE PRICE UNLESS OTHERWISE NOTED.
- 2. REFER TO ARCHITECTURAL CEILING PLAN AND COORDINATE FRAME TYPE ACCORDINGLY.

MECHANICAL GENERAL NOTES

- 1. THESE DRAWINGS ARE DIAGRAMMATIC & INDICATE THE GENERAL EXTENT OF THE WORK. PROVIDE PLUMBING AND HVAC SYSTEMS COMPLETE PER SPECIFICATION, SMACNA STANDARDS, AND PER APPLICABLE CODES INCLUDING ALL NECESSARY OFFSETS, FITTINGS, SPECIAL RADIUS OR MITERED ELBOWS WHICH ARE REQUIRED DUE TO SPACE CONSTRAINTS OR OTHER STRUCTURAL CONDITIONS.
- 2. CONTRACTOR SHALL COORDINATE HIS WORK WITH THE WORK OF ALL OTHER TRADES. VERIFY ALL CLEARANCES PRIOR TO THE FABRICATION OF ANY WORK.
- 3. DUCTWORK/PIPING SHALL NOT BE LOCATED OVER ELECTRICAL EQUIPMENT/PANELS. PROVIDE REQUIRED CLEARANCE IN FRONT OF ELECTRICAL EQUIPMENT. DUCTWORK/PIPING SHALL NOT INTERFERE WITH ELECTRICAL EQUIPMENT CLEARANCE.
- 4. THE CONTRACTOR SHALL PROVIDE ALL MISCELLANEOUS SUPPORTING STEEL, ETC. FOR THE PROPER INSTALLATION OF ALL MECHANICAL SYSTEMS.
- 5. COORDINATE FLOOR, WALL, ROOF PENETRATIONS, LOUVER SIZES, PAD LOCATIONS ETC. WITH ARCHITECTURAL TRADES.
- 6. REFER TO ARCHITECTURAL REFLECTED CEILING PLANS FOR EXACT LOCATION OF GRILLES, REGISTERS, AND DIFFUSERS.
- 7. PIPING/DUCTWORK SHALL NOT BE LOCATED OVER ELECTRICAL EQUIPMENT/ PANELS. PROVIDE REQUIRED CLEARANCE IN FRONT/ABOVE OF ELECTRICAL EQUIPMENT. PIPING SHALL NOT INTERFERE WITH ELECTRICAL EQUIPMENT CLEARANCE.
- 8. PROVIDE CODE REQUIRED CLEARANCE/ACCESS DOORS FOR DAMPERS, VALVES,
- 9. FOR EQUIPMENT VALVING, COMPONENT, AND PIPING ARRANGEMENT, REFER TO PIPING DIAGRAMS AND DETAILS.
- 10. BRANCH DUCTWORK TO GRILLES, REGISTERS AND DIFFUSERS SHALL BE THE SAME SIZE AS THE GRILLE, REGISTER OR DIFFUSER NECK SIZE WHERE NO DUCT SIZE IS INDICATED ON PLAN.
- 11. MAXIMUM LENGTH OF FLEXIBLE DUCT SHALL BE 5'-0".

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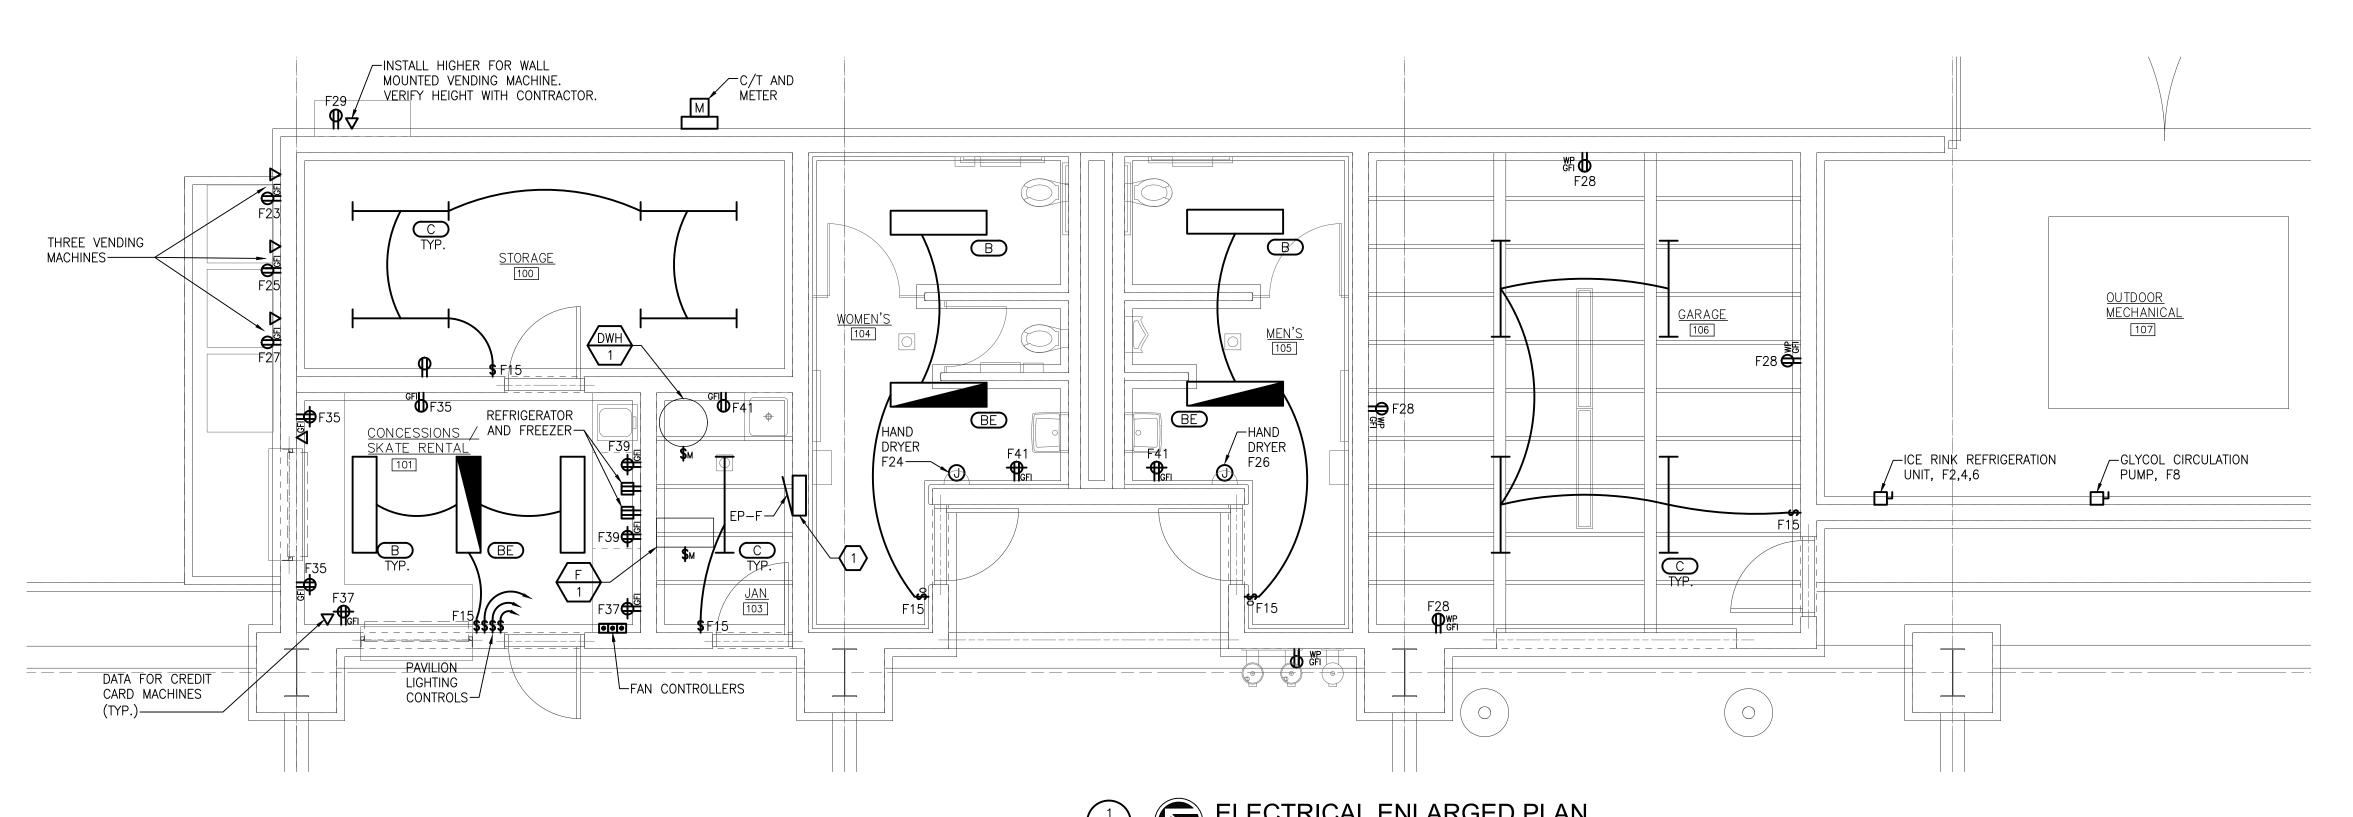
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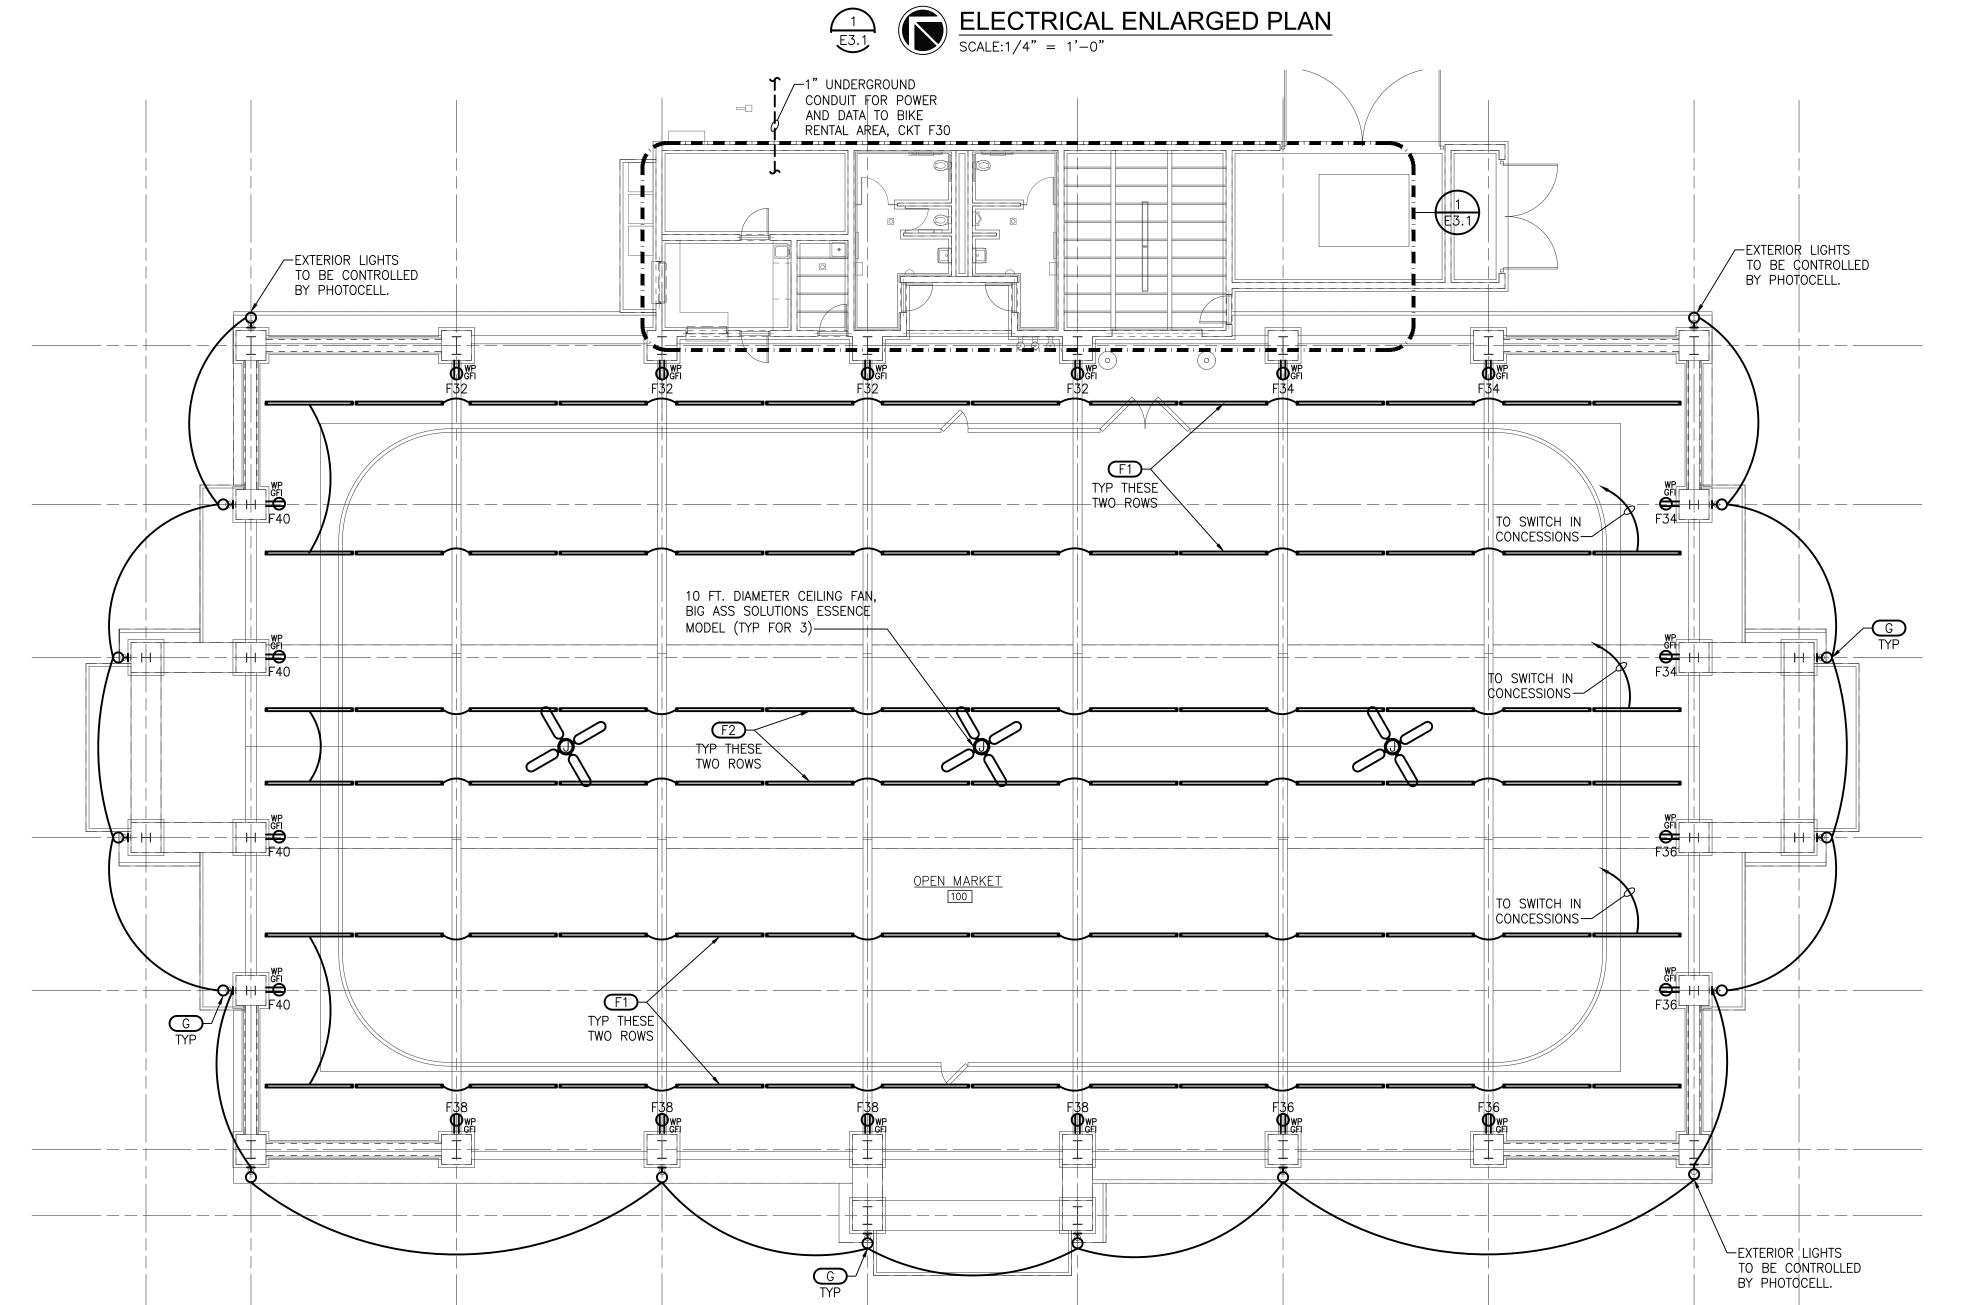
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- 1. REFER TO ARCHITECTURAL REFLECTED CEILING PLAN FOR EXACT LOCATION OF ALL LIGHTING FIXTURES UNLESS OTHERWISE NOTED.
- 2. SEE LUMINAIRE SCHEDULE ON ELECTRICAL GENERAL INFORMATION SHEET.
- 3. EXIT LIGHTS AND EMERGENCY BATTERY UNITS SHALL BE UNCONTROLLED AND TIED AHEAD OF LOCAL AREA LIGHTING SWITCH, UNLESS CIRCUITED OTHERWISE.
- 4. WHERE MORE THEN ONE LIGHT SWITCH IS INDICATED TO BE INSTALLED AT THE SAME LOCATION, THEY SHALL BE GROUPED UNDER ONE COMMON FACEPLATE.
- 5. ALL ELECTRICAL DEVICES SHOWN ON THIS PLAN SHALL BE NEW UNLESS OTHERWISE NOTED.
- 6. ANY 120 VOLT BRANCH CIRCUIT FEEDER LONGER THAN 75'-0" TO LAST DEVICE SHALL BE SIZED TO THE NEXT LARGER STANDARD AWG SIZE. E.C. SHALL FIELD VERIFY ALL LENGTHS OF FEEDERS.
- 7. ALL RECEPTACLES SHALL BE 20A. RATED.
- 8. ALL DISCONNECT SWITCHES SHALL BE HEAVY DUTY TYPE.
- 9. ALL RECEPTACLES WITHIN 6'-0" OF SINK OR OTHER WATER SUPPLY SHALL BE GFCI TYPE RECEPTACLE.
- 10. REFER TO ARCHITECTURAL FLOOR PLAN AND ELEVATIONS FOR EXACT LOCATION
- 11. ALL JUNCTION BOXES SERVING BRANCH CIRCUIT WIRING SHALL BE LABELED WITH CIRCUITS SERVED.
- 12. ALL 120 VOLT CIRCUITS SHALL UTILIZE A SEPARATE NEUTRAL.
- 13. ALL CONDUITS SERVING 120 VOLTS OR GREATER SHALL INCLUDE A GROUND
- 14. ALL CONDUITS SHALL BE ROUTED CONCEALED UNLESS NOTED OTHERWISE.
- 15. ALL ELECTRICAL EQUIPMENT MOUNTED ON THE FLOOR SHALL BE MOUNTED ON A 4" CONCRETE HOUSE KEEPING PAD.
- 16. ALL BRANCH CIRCUIT WIRING SHALL BE 2#12, 1#12GND IN 3/4" CONDUIT, UNLESS NOTED OTHERWISE.

# □E□ED NOTES

(1) REFER TO SHEET E7.1 FOR PANEL SCHEDULE AND RISER DIAGRAM.

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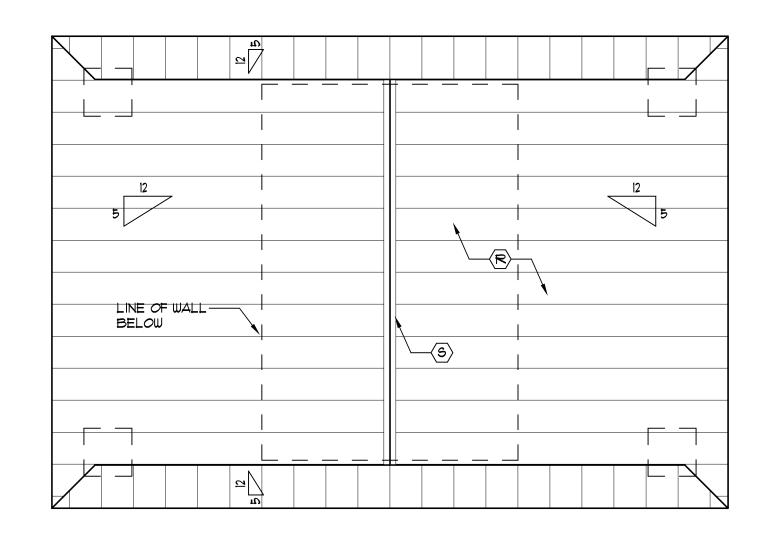
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sheet no. 16078A E3.1


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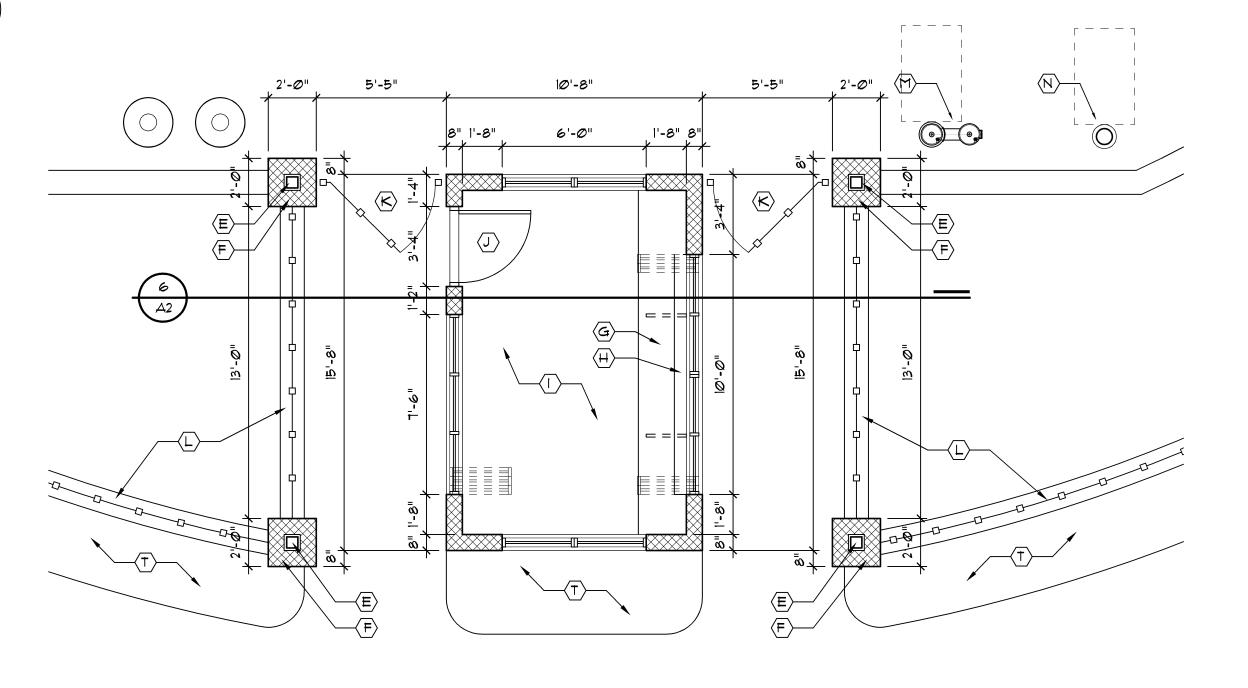
FARMERS MAR ET ELECTRICAL NE OR PLAN SCALE:3/32" = 1'-0"



# Roof Plan

Al Scale: 1/4" = 1'-0"



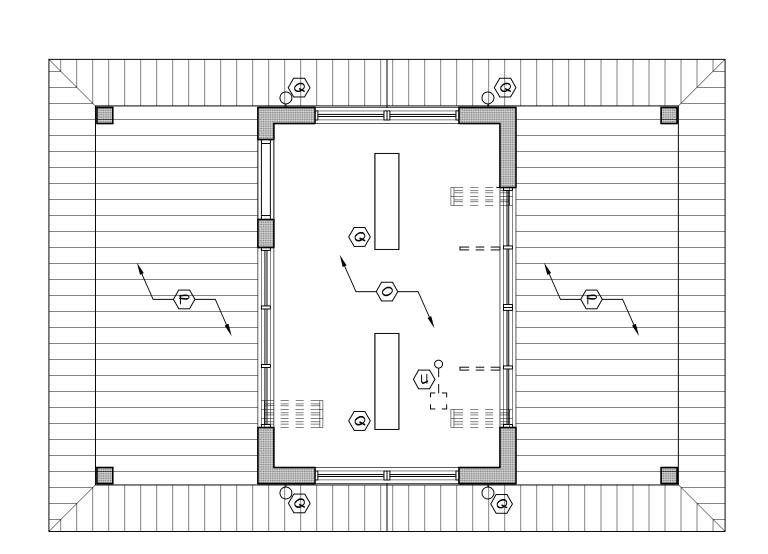


NORTH


2 Floor Plan Scale: 1/4" = 1'-0"



# Foundation Plan Al Scale: 1/4" = 1'-0"

2'-Ø"

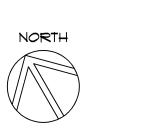

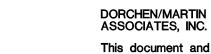

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— 4" CONC. SLAB W/ \*3 @ 8" EW BOTT. XODX #4 @ 12" DOWELS ALL AROUND —10" MIN. TRENCH FTG. W/(2) \*4 TOP & BOTTOM

5 Supported Slab Detail
Al Scale: Not to Scale

9'-4"

KEYED NOTES:

INFORMATION

GRANULAR BASE

BOX-OUT (PAINT)

CMU PIER

MORE INFORMATION

8" FNDN. WALL ON 16"x12" CONCRETE SPREAD FOOTING W/

4" CONC. SLAB ON 6 MIL. VAPOR BARRIER ON 4" COMP.

2'-0"x2'-0" CONC. PIER FOOTING - SEE WALL SECTIONS FOR

6x6 MOISTURE TREATED POST W/ IX8 FIBER CEMENT TRIM

SOLID SURFACE WORK SURFACE (SS-1) AT 30" A.F.F. SUPPORTED BY BRACKETS AS NECESSARY (SEE FLOOR PLAN. NO BRACKETS TO BE PLACED IN FRONT OF SLIDING

SOLID SURFACE TRANSACTION TOP (SS-1) AT 36" A.F.F.

 $\langle K \rangle$  5'-0" WIDE x 5'-0" HIGH ORNAMENTAL STEEL SWING GATE

3'-0"x7'-0"x1-3/4" HOLLOW METAL DOOR W/ SAFETY GLASS

3'-0" HIGH ORNAMENTAL STEEL FENCE ON RETAINING WALL

PEDESTAL DRINKING FOUNTAIN (SEE PLUMBING DRAWINGS)

FREESTANDING SHOWER (SEE PLUMBING DRAWINGS)

5/6", 8" GROOVE FIBER CEMENT SOFFIT PANEL - PAINT

"SNAP-LOCK" STANDING SEAM METAL ROOFING ON 30# FELT ON 3/4" PLYWOOD SHEATHING ON WOOD ROOF

LIGHT FIXTURE (SEE ELECTRICAL DRAWINGS)

CERAMIC TILE FLOOR AND BASE

HOLLOW METAL DOOR FRAME (PAINT) METAL THRESHOLD, WEATHERSTRIPPING

VISION LITE (PAINT)

WITH LATCH AND LOCK

GYP. BD. CEILING - PAINT

TRUSSES @ 24" O.C. (TYP.)

(U) EXHAUST FAN (SEE MECHANICAL PLANS)

RIDGE CAP

LANDSCAPING

**(**S)


#4 @ 12"x4'-Ø"---

#4 @ 12" DOWELS -

2'-Ø"

(2) \*5 AT BTM. - SEE WALL SECTIONS FOR MORE

SUPPORTED SLAB (SEE DETAIL THIS SHEET)

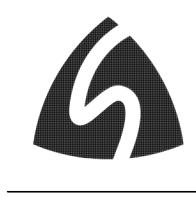

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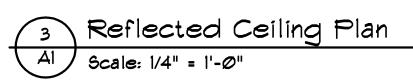
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Splash Park Ticket Booth - Floor Plan


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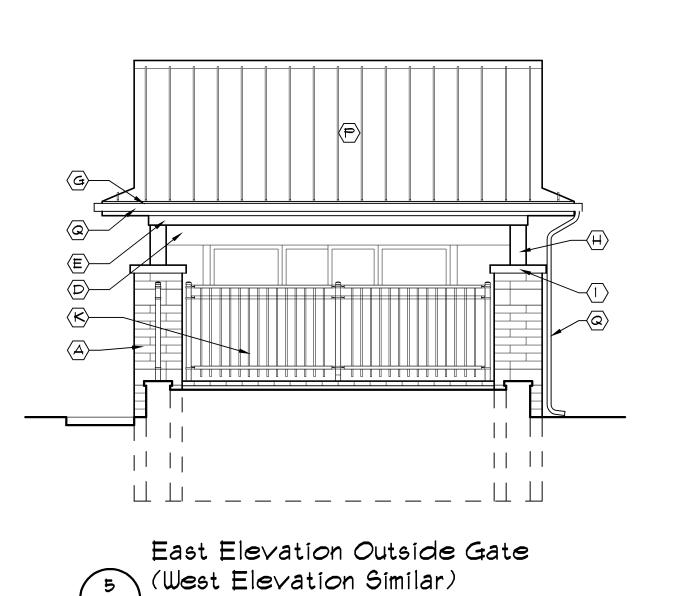
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### ELEVATION NOTES

- 4"x8"x16" CMU CONSUMER'S CONCRETE "BELLA BRIK" CINCINNATI BLEND
- 8"X8"X16" SPLIT FACE CMU ACCENT BAND (MATCH CMU ON EXISTING RESTROOM BUILDING)
- FIBER CEMENT SIDING WOODTONE "RUSTIC SERIES" WINCHESTER BROWN, 1" EXPOSURE
- 5/4x12 SMOOTH FACE FIBER CEMENT TRIM BOARD CUT TO FIT PAINT
- (E) 5/4x6 SMOOTH FACE FIBER CEMENT TRIM BOARD PAINT
- (F) 5/4x4 9MOOTH FACE FIBER CEMENT TRIM BOARD PAINT G 5/4x8 SMOOTH FACE FIBER CEMENT TRIM BOARD - PAINT
- 5/4x8 SMOOTH FACE FIBER CEMENT TRIM BOARDS AT POST SURROUND PAINT
- (I) 4" PRECAST SILL
- J) 4" PRECAST SLOPED PIER CAP
- (K) 4'-0" HIGH ORNAMENTAL STEEL FENCE ON RETAINING WALL
- 5'-0" WIDE x 5'-0" HIGH ORNAMENTAL STEEL SWING GATE WITH LATCH AND LOCK
- M HOLLOW METAL DOOR & FRAME
- 5040 FOLDING WINDOW ALUMINUM CLAD EXTERIOR, PAINTED WOOD INTERIOR FOLDER VICTALINATION PAINTED WOOD INTERIOR KOLBE VISTALUXE OR EQUAL
- NO 7640 FOLDING WINDOW ALUMINUM CLAD EXTERIOR, PAINTED WOOD INTERIOR, KOLBE VISTALUXE OR EQUAL
- 3040 FIXED WINDOW ALUMINUM CLAD EXTERIOR, PAINTED WOOD INTERIOR KOLBE VISTALUXE OR EQUAL
- "SNAP-LOCK" STANDING SEAM METAL ROOFING ON 30# FELT "SNAP-LOCK" STANDING SEATTHETAL ROOTING ON TRUSSES
  ON 3/4" EXTERIOR GRADE PLYWOOD DECKING ON TRUSSES
- (Q) ALUMINUM GUTTER AND DOWNSPOUT
- R LINE OF FOUNDATION WALL BEYOND
- SIMULATED STONE VENEER CULTURED STONE "COUNTRY LEDGESTONE" BUCKS COUNTY






A2 Scale: 1/4" = 1'-0"

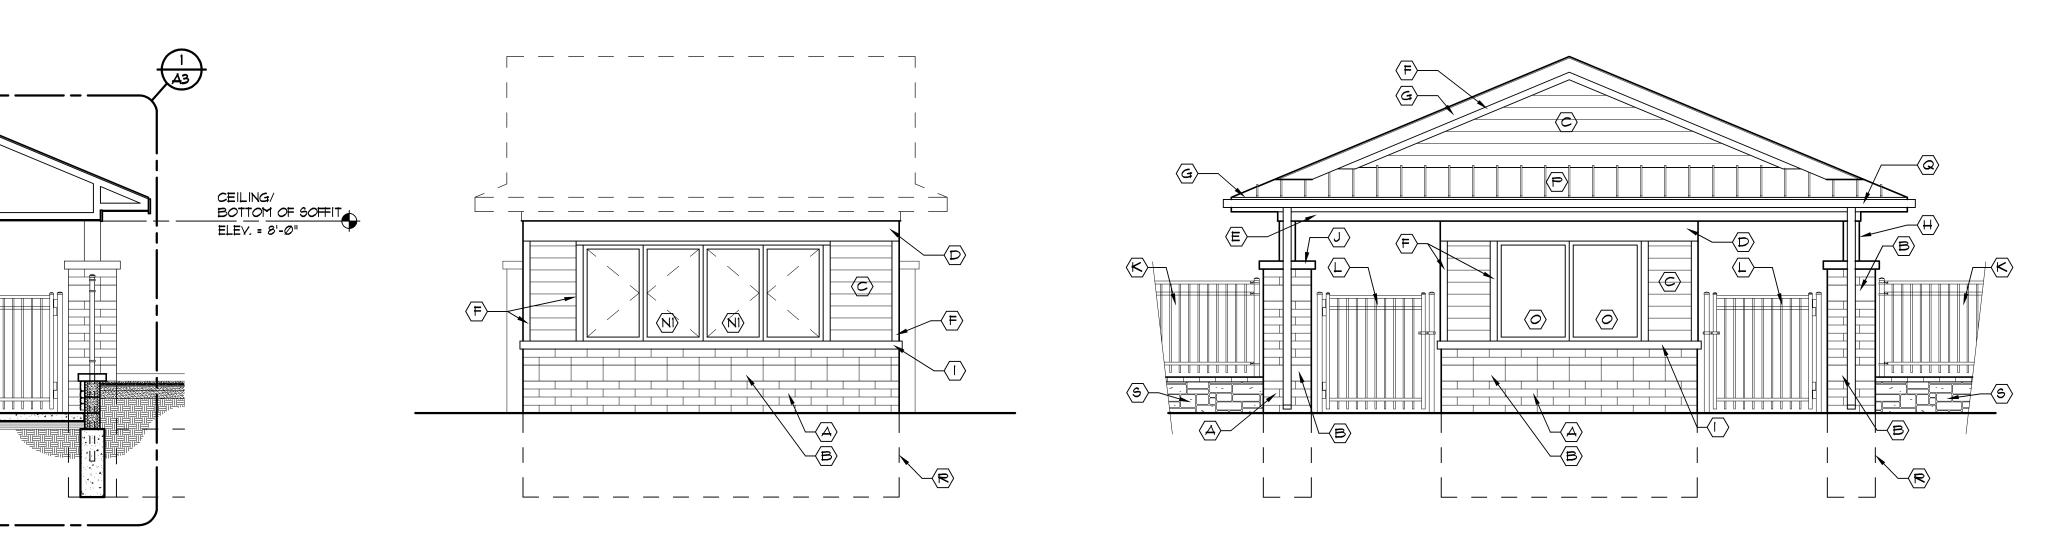6 Section


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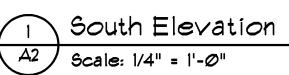


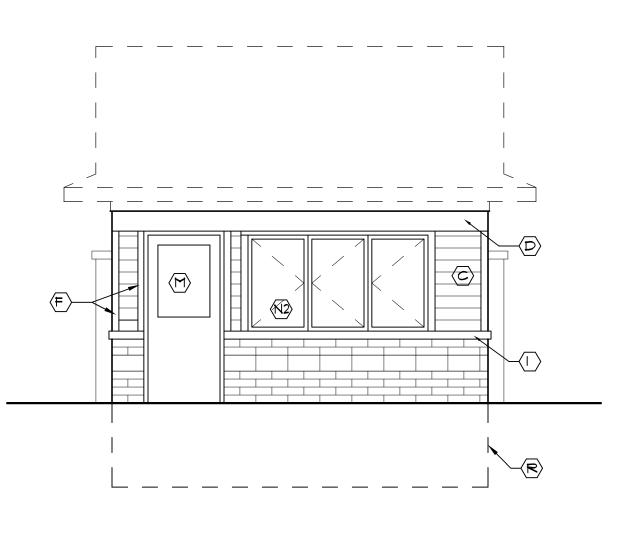4 East Elevation Inside Gate

A2 Scale: 1/4" = 1'-0"





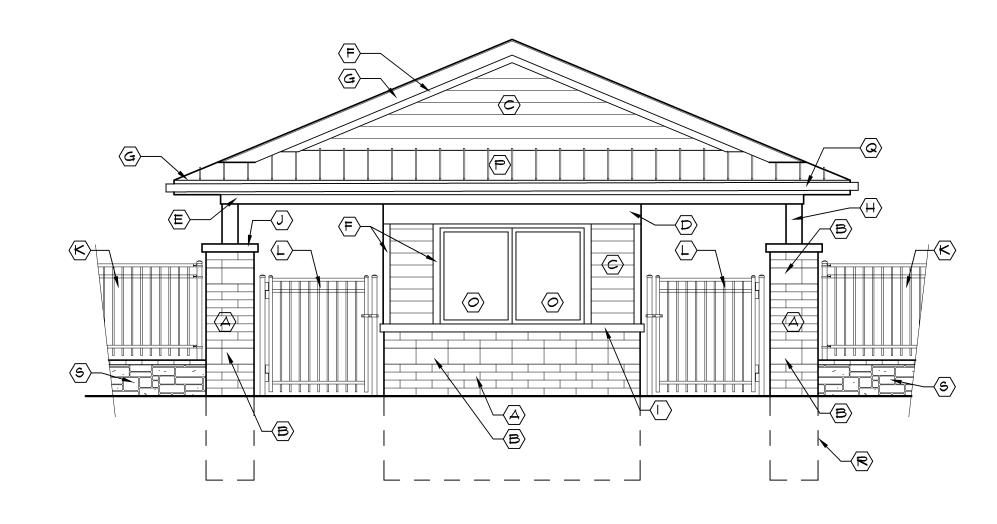

3 North Elevation

A2 Scale: 1/4" = 1'-0"



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Splash Park Ticket
Booth - Elevations
and Sections project




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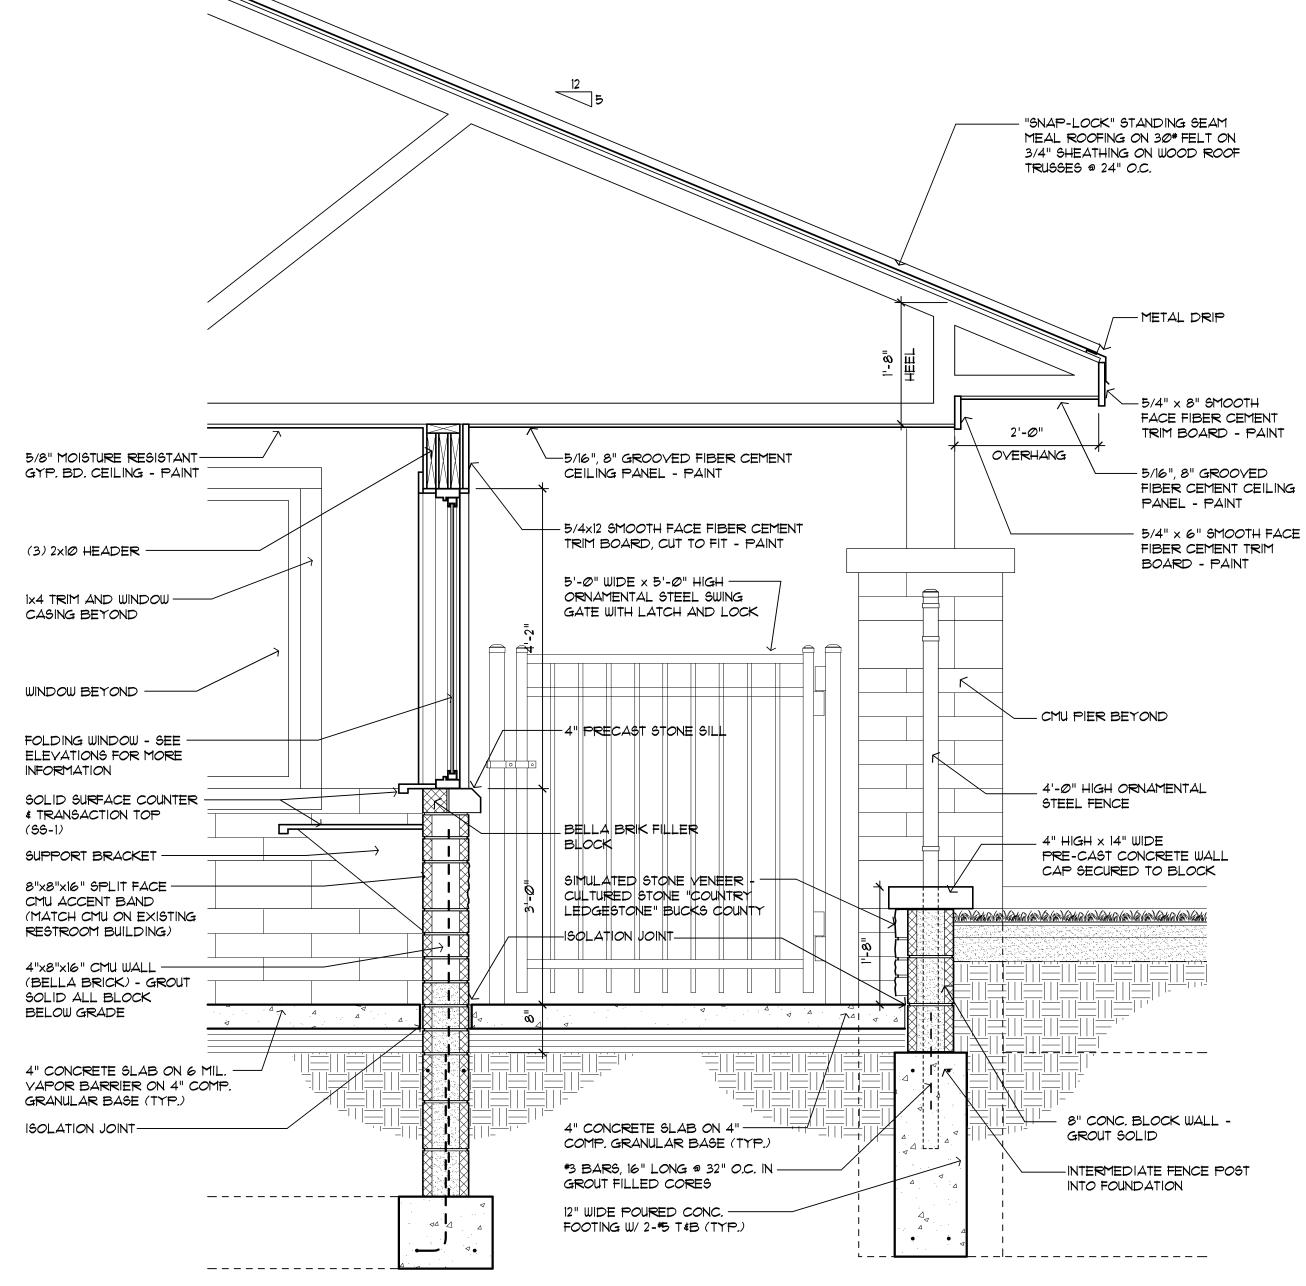
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Brick Column Surround Section



issue / revision date 3-7-17 Prelim. Review 3-21-17 Prelim. Review 5-9-17 Prelim. Review 5-16-17 Prelim. Review 6-7-17 City Review 6-19-17 Bids

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sheet no. 16078A TB-A3

Brick Column Surround Section

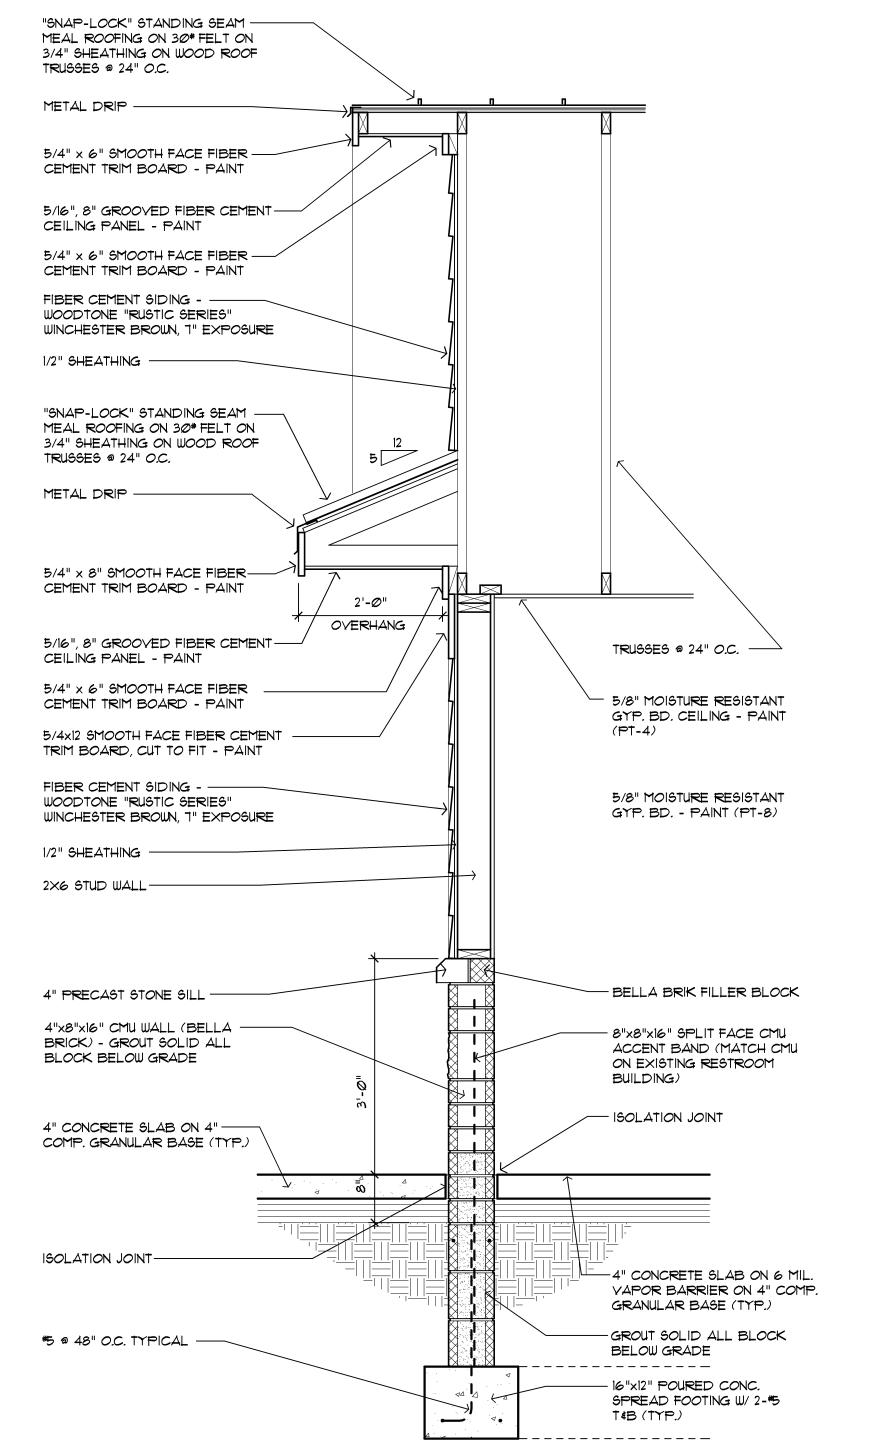/ Scale: 3/4" = 1'-0"

"SNAP-LOCK" STANDING SEAM ---MEAL ROOFING ON 30# FELT ON 3/4" SHEATHING ON WOOD ROOF

5/4" x 8" SMOOTH FACE FIBER-

5/16", 8" GROOVED FIBER CEMENT-

2'-Ø"

OVERHANG

-5/16", 8" GROOVED FIBER CEMENT

BOXED OUT COLUMN WITH 1x8

FIBER CEMENT TRIM BD. - PAINT

CEILING PANEL - PAINT

- 5'-0" WIDE x 5'-0" HIGH

ORNAMENTAL STEEL SWING

GATE WITH LATCH AND LOCK

- 4" CONCRETE SLAB

GRANULAR BASE

- FENCE POST IN

CONCRETE FOOTING

ON 4" COMP.

(TYP.)

CEMENT TRIM BOARD - PAINT

5/4" x 6" SMOOTH FACE FIBER

CEMENT TRIM BOARD - PAINT

4" PRECAST SLOPED PIER CAP-

8"x8"x16" SPLIT FACE CMU

BUILDING)

BUILDING)

ACCENT BAND (MATCH CMU ON EXISTING RESTROOM

4"x8"x16" CMU WALL (BELLA

BRICK) - GROUT SOLID ALL

8"x8"x16" SPLIT FACE CMU -

ON EXISTING RESTROOM

4"  $HIGH \times 14$ " WIDE -

STONE VENEER ON

EXPOSED FACE

ACCENT BAND (MATCH CMU

PRE-CAST CONCRETE WALL

CAP SECURED TO BLOCK

8" CONC. BLOCK WALL - -

GROUT SOLID - SIMULATED

12" WIDE POURED CONC. -

IN GROUT FILLED CORES

24" × 24" WIDE POURED

W/ 2-#5 T&B (TYP.)

CONC. FOOTING AT PIER

FOOTING W/ 2-#5 T&B (TYP.)


#3 BARS, 16" LONG @ 32" O.C.

BLOCK BELOW GRADE

CEILING PANEL - PAINT

TRUSSES @ 24" O.C.

METAL DRIP -

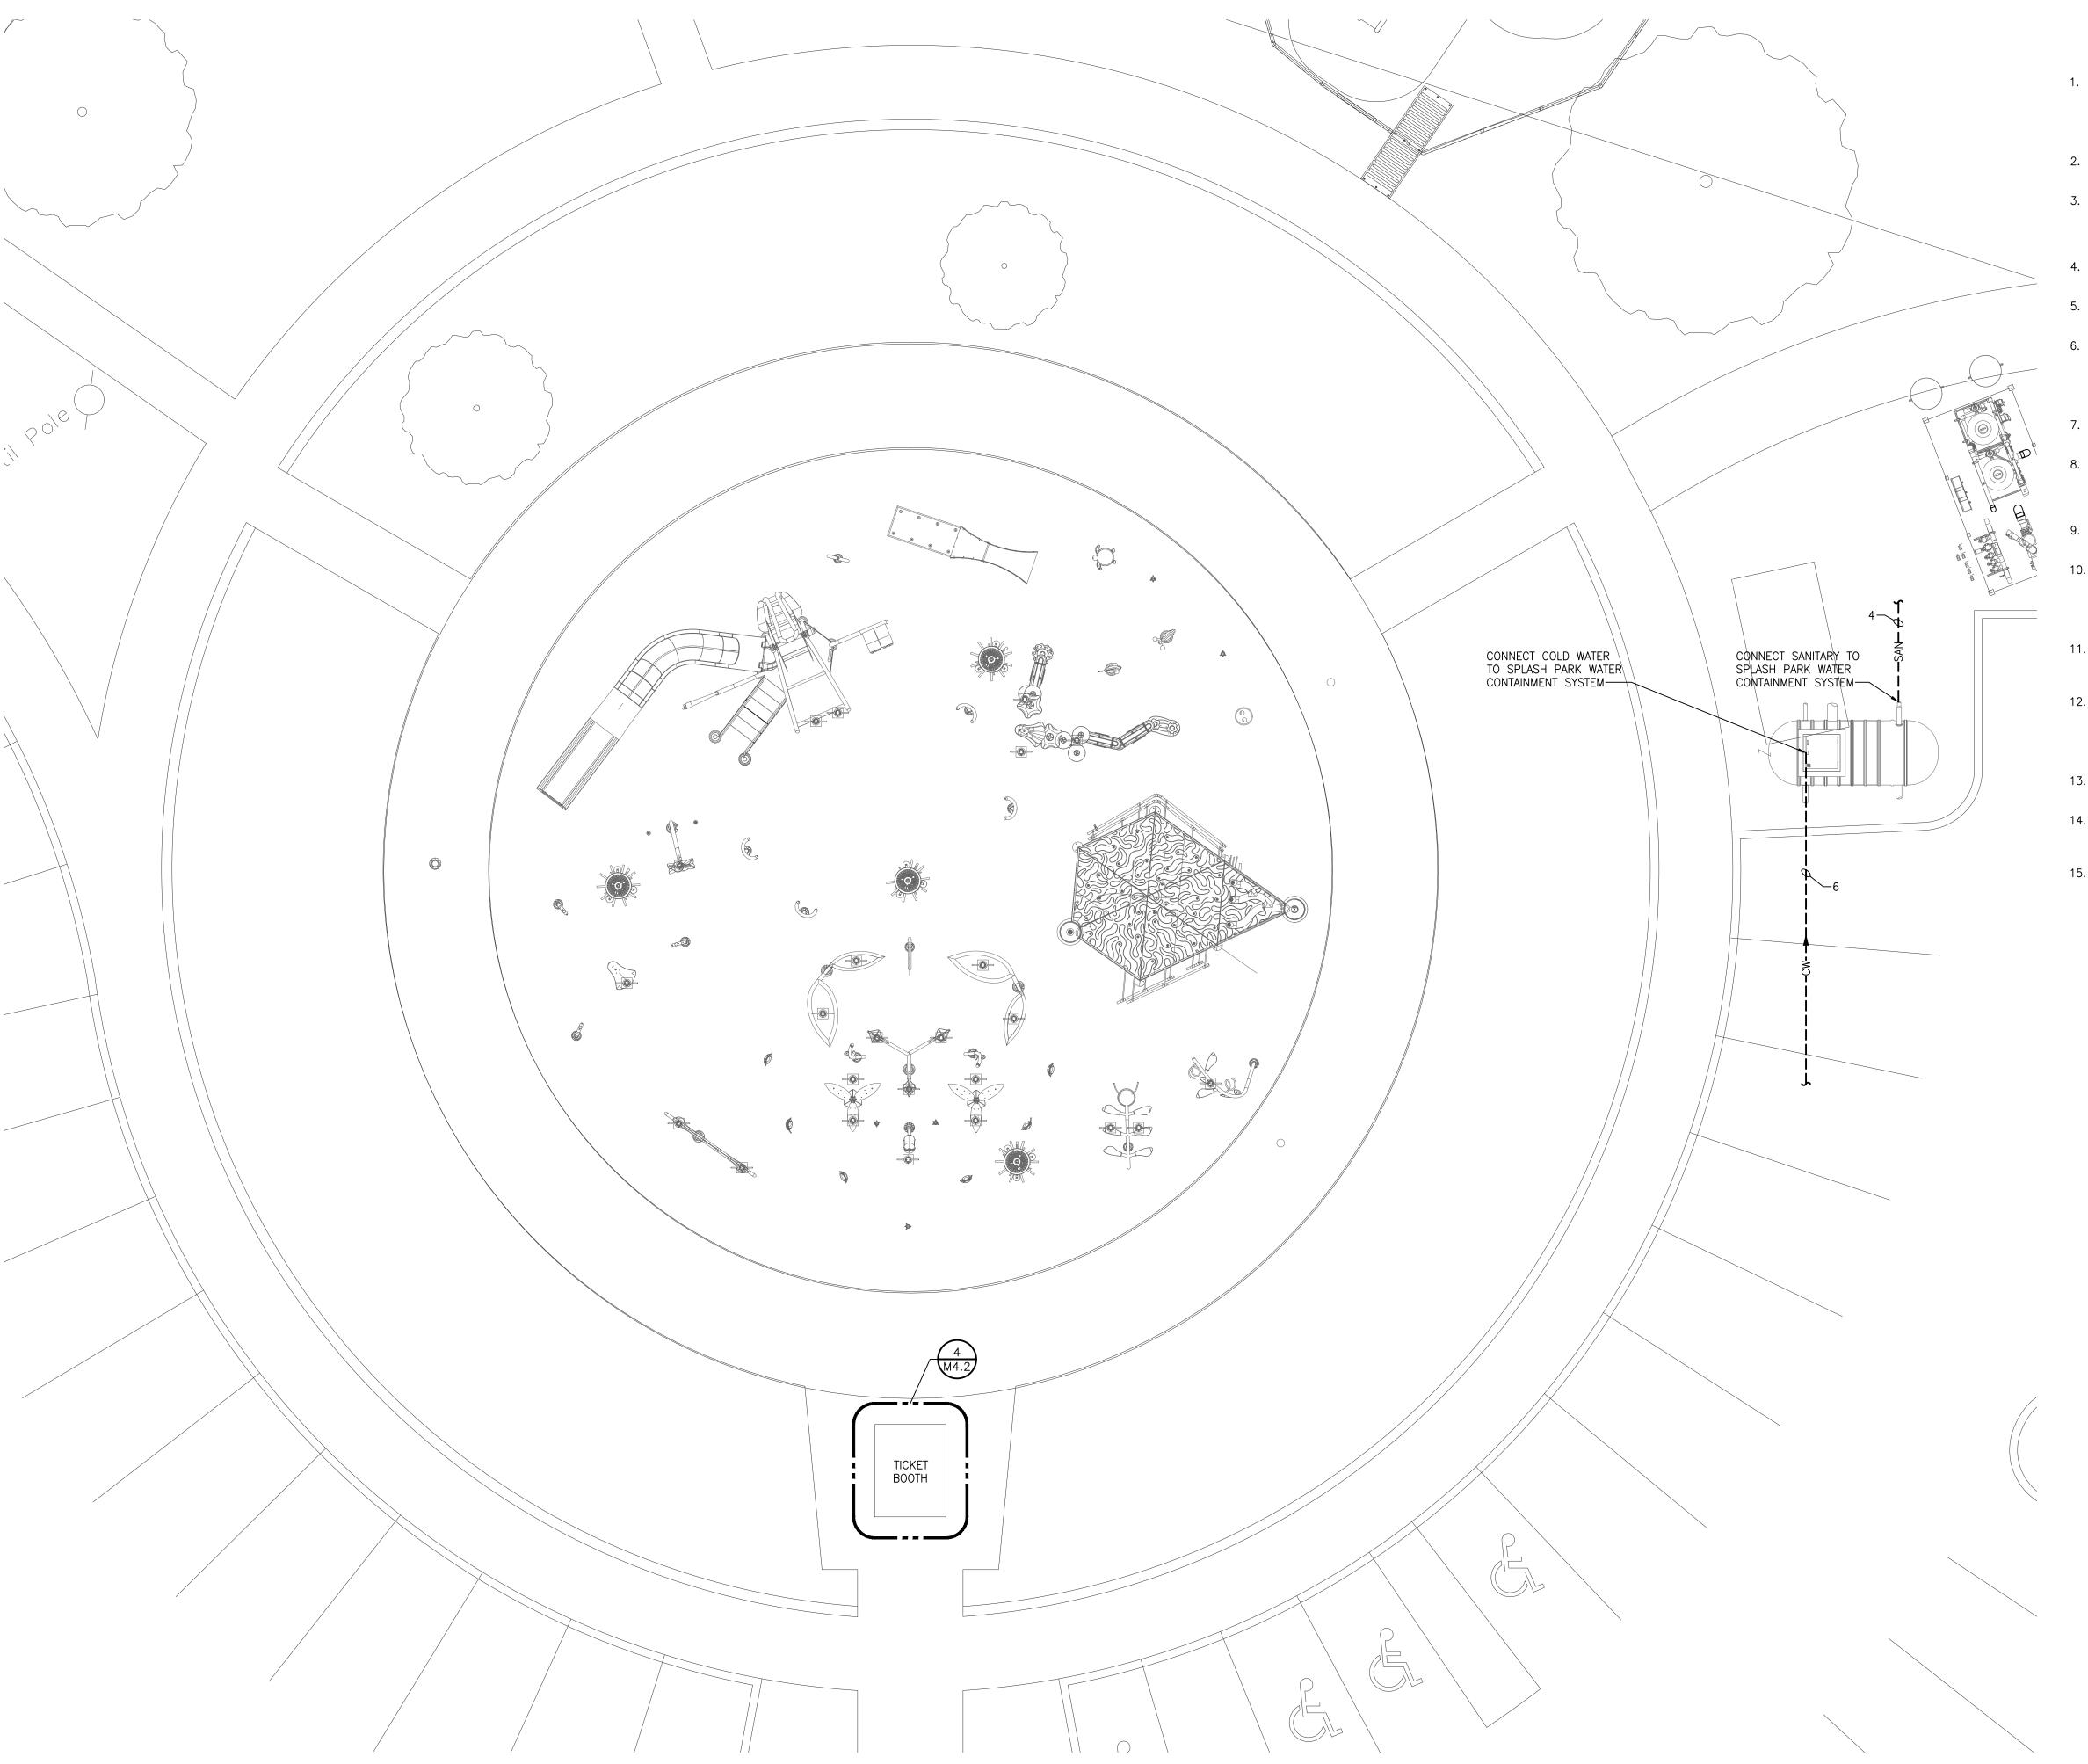





# MECHANICAL GENERAL NOTES

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- 4. THE CONTRACTOR SHALL PROVIDE ALL MISCELLANEOUS SUPPORTING STEEL, ETC. FOR THE PROPER INSTALLATION OF ALL MECHANICAL SYSTEMS.
- 5. COORDINATE FLOOR, WALL, ROOF PENETRATIONS, LOUVER SIZES, PAD LOCATIONS ETC. WITH ARCHITECTURAL TRADES.
- REFER TO ARCHITECTURAL PLANS FOR SPECIFICATIONS AND EXACT LOCATIONS OF FIXTURES (STANDARD AND BARRIER FREE), SINKS, ETC. REFER TO FOOD SERVICE PLANS FOR SPECIFICATIONS AND EXACT LOCATIONS OF FOOD SERVICE EQUIPMENT. REFER TO PLUMBING FIXTURE SCHEDULE FOR CONNECTION SIZES, ACCESSORIES, AND ADDITIONAL INFORMATION.
- REFER TO ARCHITECTURAL REFLECTED CEILING PLANS FOR EXACT LOCATION OF GRILLES, REGISTERS, AND DIFFUSERS.
- 8. PIPING/DUCTWORK SHALL NOT BE LOCATED OVER ELECTRICAL EQUIPMENT/ PANELS. PROVIDE REQUIRED CLEARANCE IN FRONT/ABOVE OF ELECTRICAL EQUIPMENT. PIPING SHALL NOT INTERFERE WITH ELECTRICAL EQUIPMENT
- PIPING SHALL NOT BE INSTALLED IN A LOCATION THAT RESTRICTS THE ACCESS TO MECHANICAL DEVICES REQUIRING ACCESS.
- 10. HOT AND COLD WATER PIPING RUN-OUTS TO LAVS AND SINKS SHALL BE 3/4" UNLESS NOTED OTHERWISE. REFER TO PLUMBING FIXTURE SCHEDULE FOR CONNECTION SIZES. PROVIDE BRANCH LINE ISOLATION VALVES ON DOMESTIC PIPING TO EACH GROUP OF FIXTURES AND TOILET ROOMS. PROVIDE FULL OPEN VALVES PER PLUMBING CODE.
- 11. HOT AND COLD WATER PIPING RUN-OUTS TO LAVS AND SINKS SHALL BE 3/4" UNLESS NOTED OTHERWISE. REFER TO SPECIFICATIONS FOR FIXTURE CONNECTION SIZES.
- 12. PROVIDE CODE REQUIRED CLEARANCE/ACCESS DOORS FOR DAMPERS, VALVES, AND CLEANOUTS LOCATED IN WALLS OR ABOVE HARD CEILINGS, AND LOCATIONS OF CLEANOUTS INSTALLED IN STORM AND SANITARY PIPING. COORDINATE LOCATIONS WITH ARCHITECT. PROVIDE CLEANOUTS AT THE BASE OF ALL STACKS. REFER TO ARCHITECTURAL PLANS FOR CEILING TYPES.
- 13. FOR EQUIPMENT VALVING, COMPONENT, AND PIPING ARRANGEMENT, REFER TO PIPING DIAGRAMS AND DETAILS.
- 14. BRANCH DUCTWORK TO GRILLES, REGISTERS AND DIFFUSERS SHALL BE THE SAME SIZE AS THE GRILLE, REGISTER OR DIFFUSER NECK SIZE WHERE NO DUCT SIZE IS INDICATED ON PLAN.
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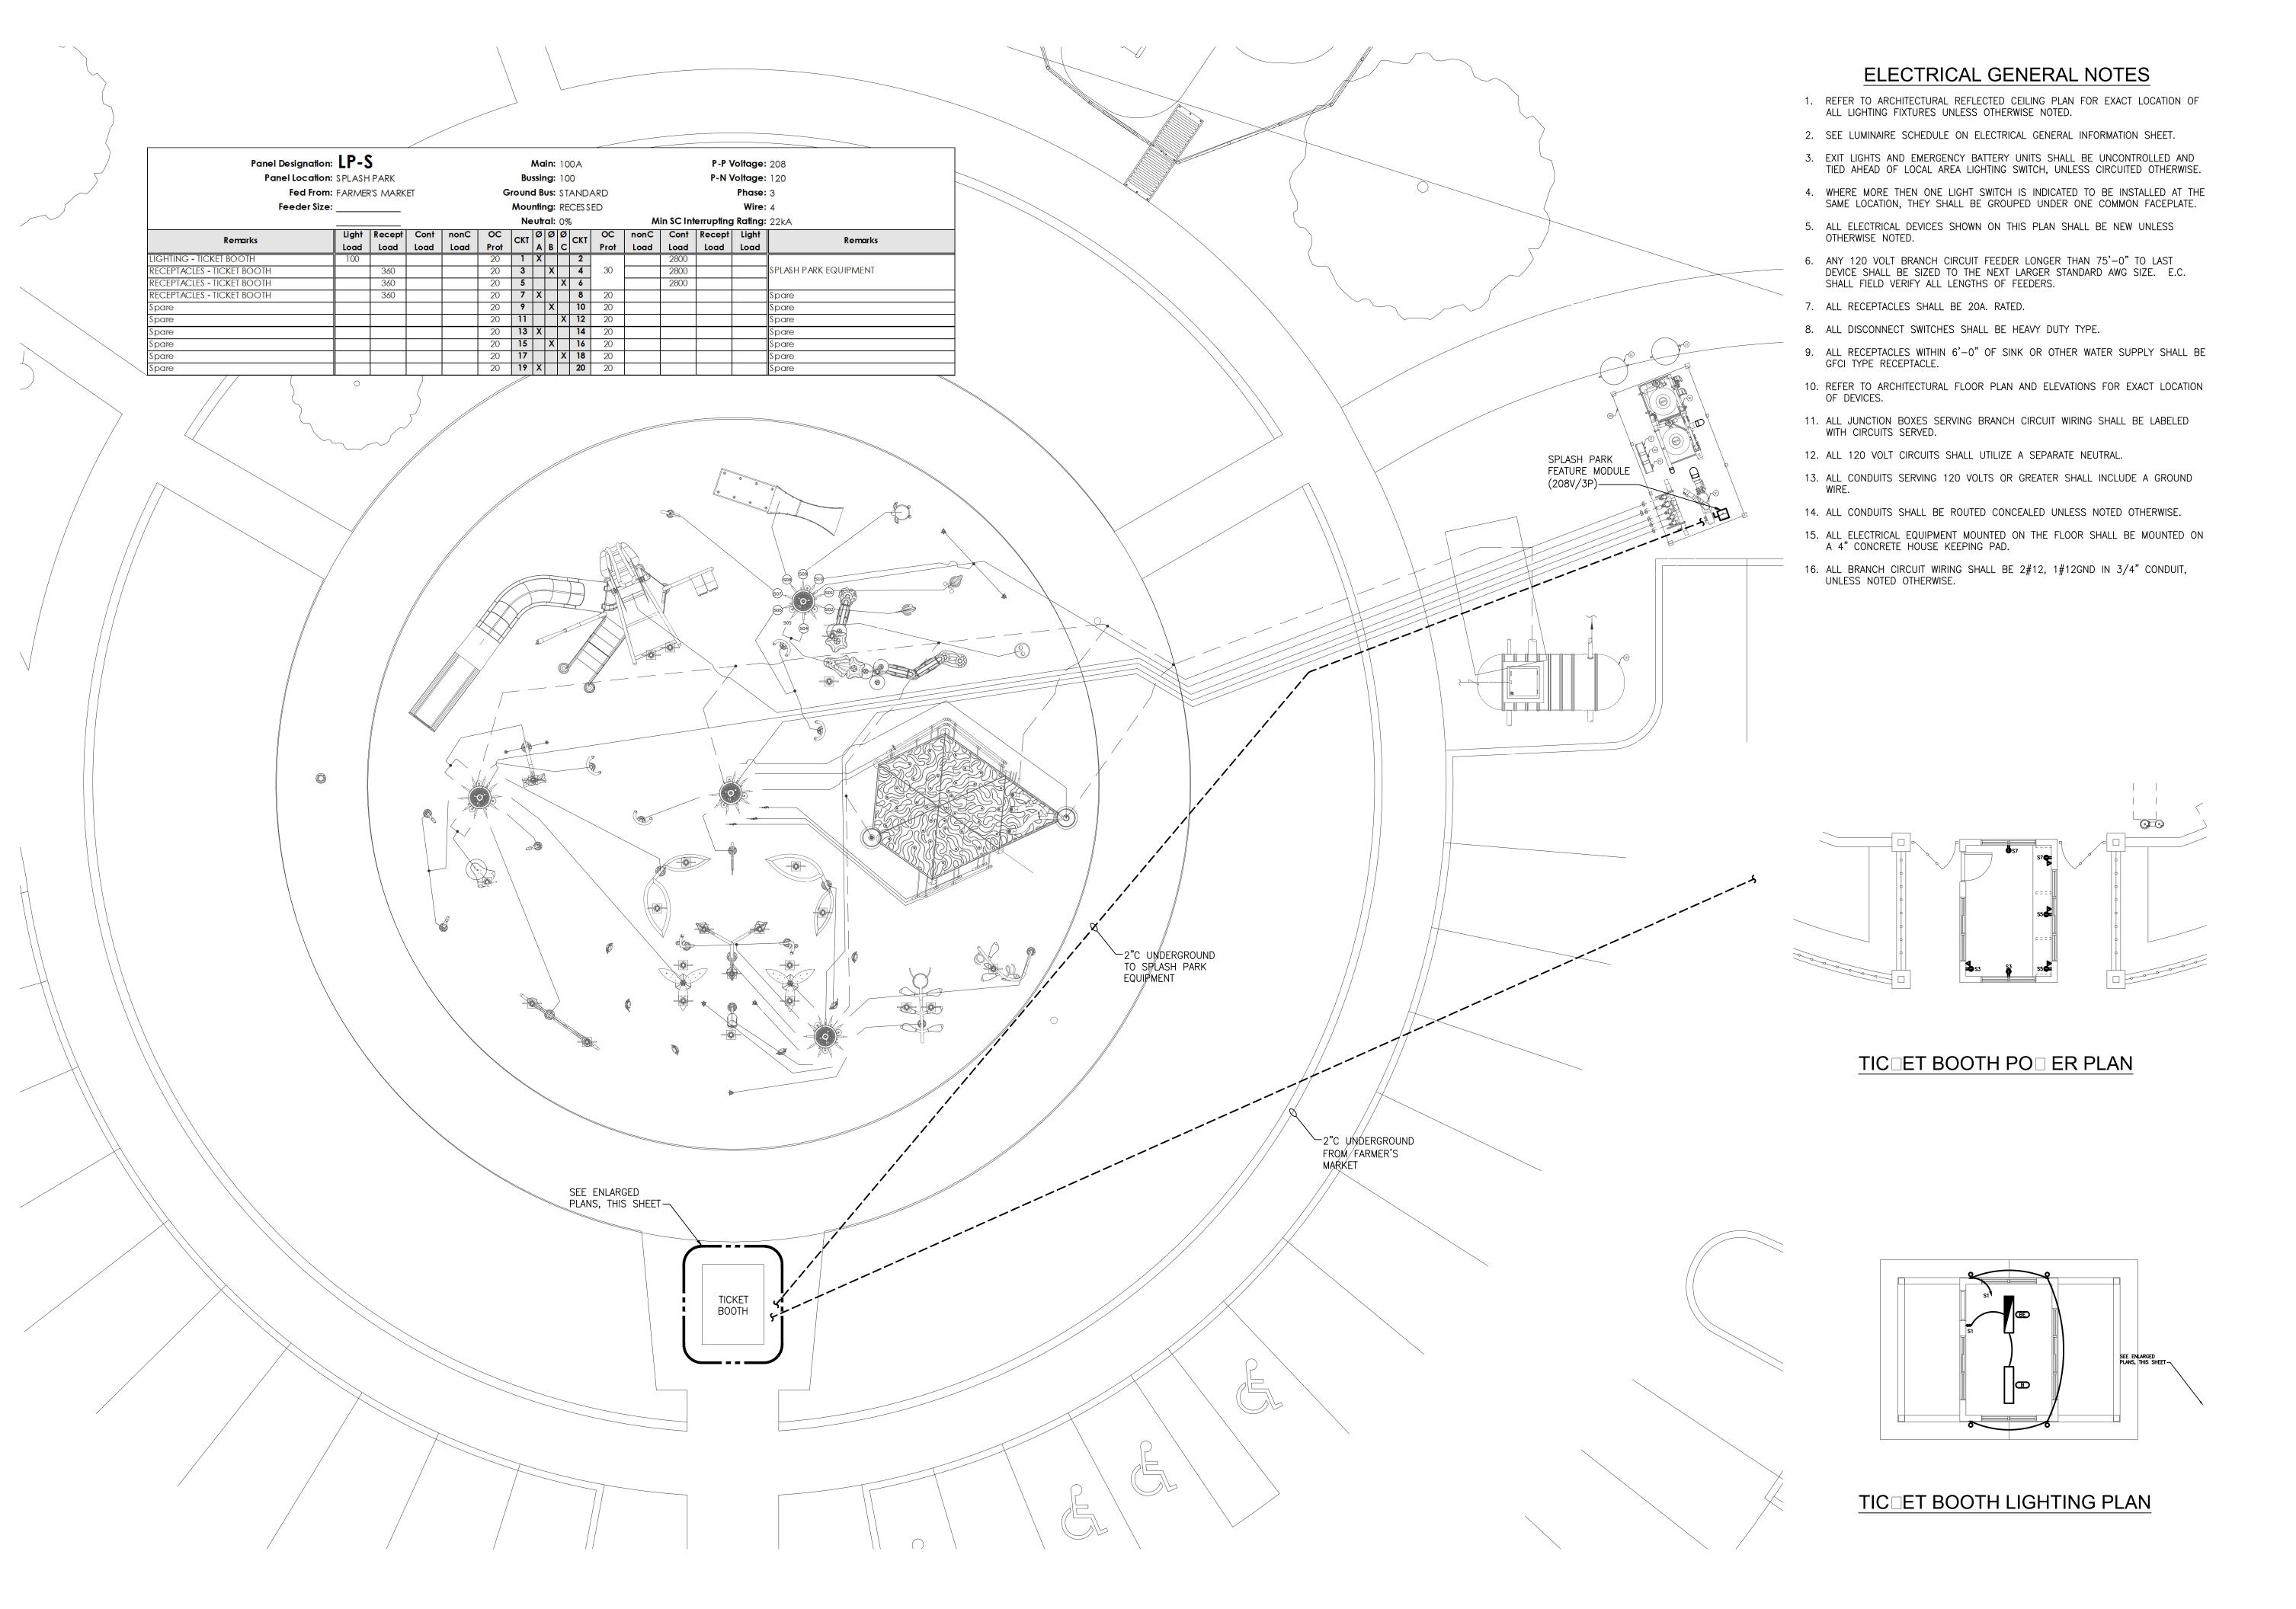
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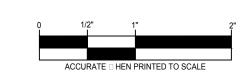
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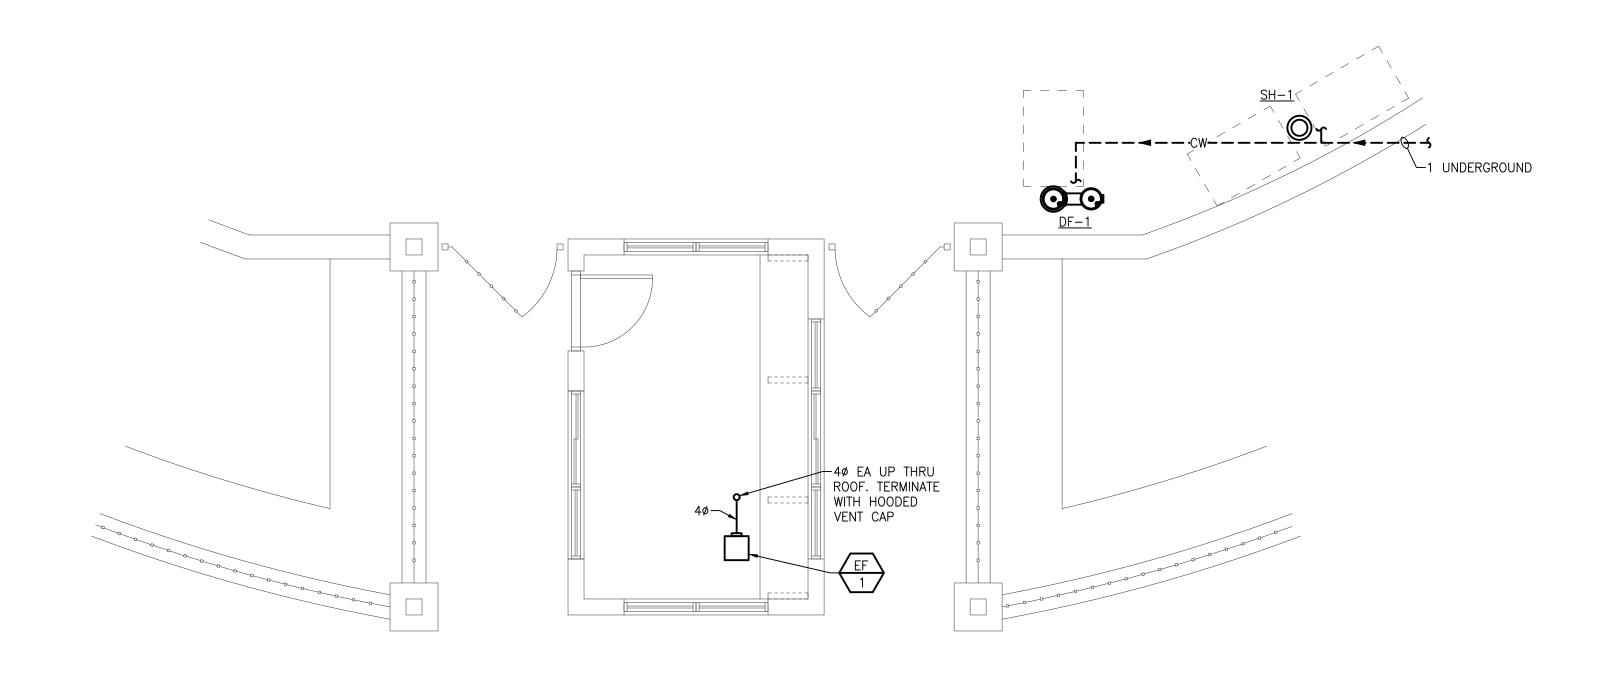
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# TIC ET BOOTH MECHANICAL NE OR PLAN SCALE: 1/4" = 1'-0"

				Е	XHAL	JST FA	AN SC	CHED	ULE					
LINIT ID	SERVING	7.77		ESP	FAN		MOT	OR		ELECT	RICAL		REMARKS	
UNIT ID		TYPE	CFM	(IN WG)	RPM	WATTS	HP	RPM	DRIVE TYPE	VOLTS	PHASE	MODEL NO.		
EF-1	RESTROOM	CEILING	90	0.25	1,161	20.7	_	_	_	120	1	FV-11VQ5		

1. MODEL NUMBERS ARE PANASONIC UNLESS OTHERWISE NOTED.

2. PROVIDE WITH GRAVITY BACKDRAFT DAMPER.

3. CONTROL SHALL BE BY MANUAL MOTOR STARTER PROVIDED BY

ELECTRICAL TRADES.

4. PROVIDE WALL CAP AT TERMINATION POINT.

			PLUN	//BINC	3 FIX	TUR	E SCHEDULE						
TAC	TAG BARRIER ITEM PIPE CONNECTION SIZES MANUFACTURER ACCESSORIES												
TAG	FREE	I I CIVI	WASTE VENT CW HW		& MODEL NO.	ACCESSURIES							
DF-1	_	BI-LEVEL DRINKING FOUNTAIN WITH BOTTLE FILLER	2"	1 1/2"	1/2"	_	MOST DEPENDABLE: MODEL #10145 SM, COLOR BLUE	ATTACHED HOSE BIBB					
SH-1	Y	OUTDOOR SHOWER	3"	1 1/2"	1/2"		OUTDOOR SHOWER COMPANY: MODEL # FTA-SQ86-C-ADA	FOOT SHOWER: FTA-LCT-ASA-FS					

NOTES:

1. SUPPLY ALL FIXTURES WITH LOOSE KEY STOPS.

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- 4. THE CONTRACTOR SHALL PROVIDE ALL MISCELLANEOUS SUPPORTING STEEL, ETC. FOR THE PROPER INSTALLATION OF ALL MECHANICAL SYSTEMS.
- 5. COORDINATE FLOOR, WALL, ROOF PENETRATIONS, LOUVER SIZES, PAD LOCATIONS ETC. WITH ARCHITECTURAL TRADES.
- 6. REFER TO ARCHITECTURAL PLANS FOR SPECIFICATIONS AND EXACT LOCATIONS OF FIXTURES (STANDARD AND BARRIER FREE), SINKS, ETC. REFER TO FOOD SERVICE PLANS FOR SPECIFICATIONS AND EXACT LOCATIONS OF FOOD SERVICE EQUIPMENT. REFER TO PLUMBING FIXTURE SCHEDULE FOR CONNECTION SIZES, ACCESSORIES, AND ADDITIONAL INFORMATION.
- 7. REFER TO ARCHITECTURAL REFLECTED CEILING PLANS FOR EXACT LOCATION OF GRILLES, REGISTERS, AND DIFFUSERS.
- 8. PIPING/DUCTWORK SHALL NOT BE LOCATED OVER ELECTRICAL EQUIPMENT/ PANELS. PROVIDE REQUIRED CLEARANCE IN FRONT/ABOVE OF ELECTRICAL EQUIPMENT. PIPING SHALL NOT INTERFERE WITH ELECTRICAL EQUIPMENT CLEARANCE.
- 9. PIPING SHALL NOT BE INSTALLED IN A LOCATION THAT RESTRICTS THE ACCESS TO MECHANICAL DEVICES REQUIRING ACCESS.
- 10. PROVIDE CODE REQUIRED CLEARANCE/ACCESS DOORS FOR DAMPERS, VALVES, AND CLEANOUTS LOCATED IN WALLS OR ABOVE HARD CEILINGS, AND LOCATIONS OF CLEANOUTS INSTALLED IN STORM AND SANITARY PIPING. COORDINATE LOCATIONS WITH ARCHITECT. PROVIDE CLEANOUTS AT THE BASE OF ALL STACKS. REFER TO ARCHITECTURAL PLANS FOR CEILING TYPES.
- 11. FOR EQUIPMENT VALVING, COMPONENT, AND PIPING ARRANGEMENT, REFER TO PIPING DIAGRAMS AND DETAILS.

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6-19-17 Bids

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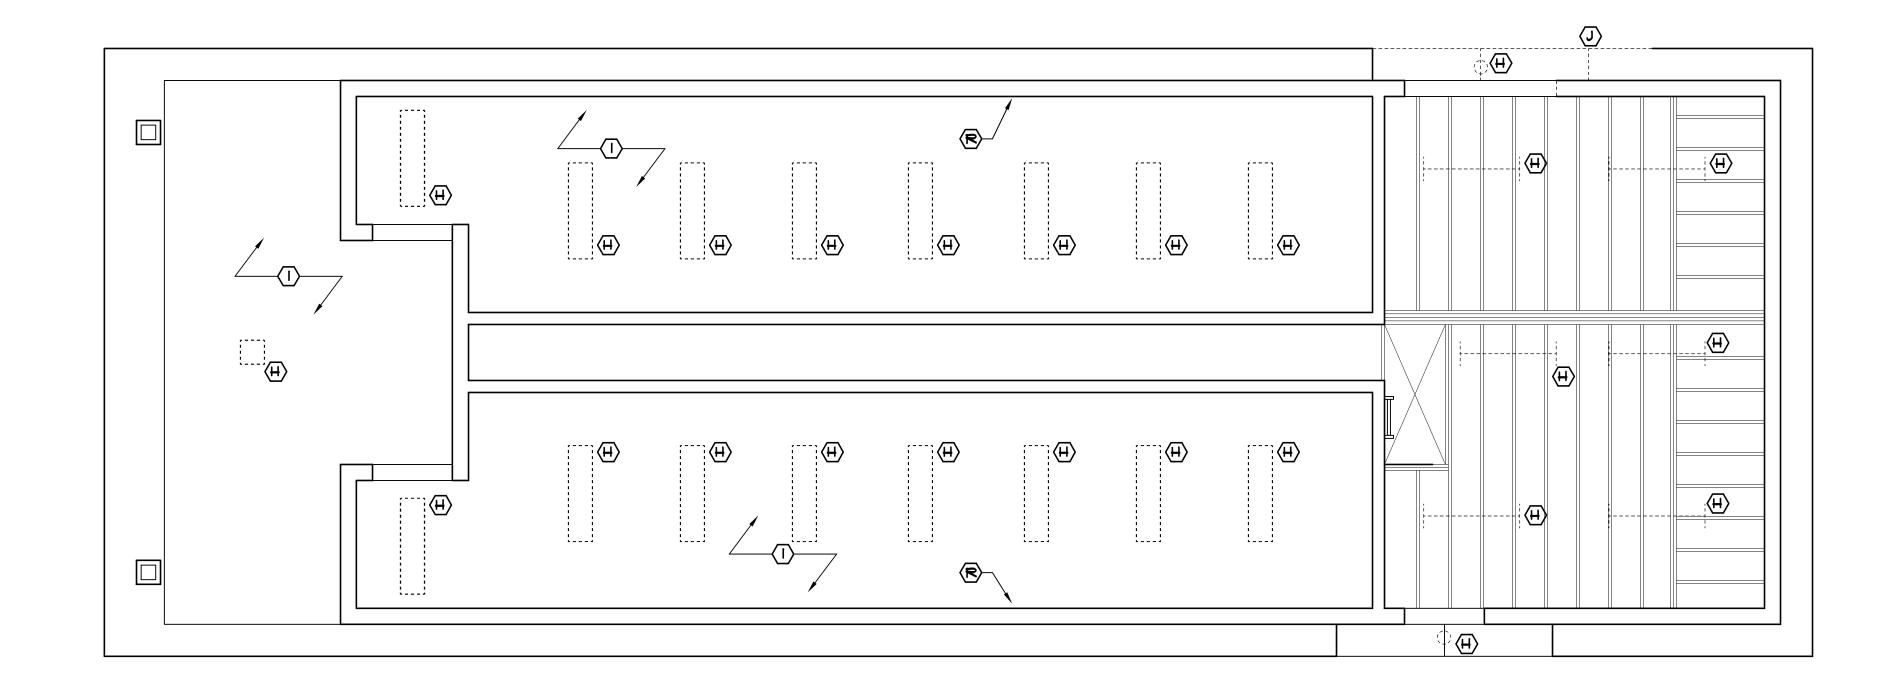
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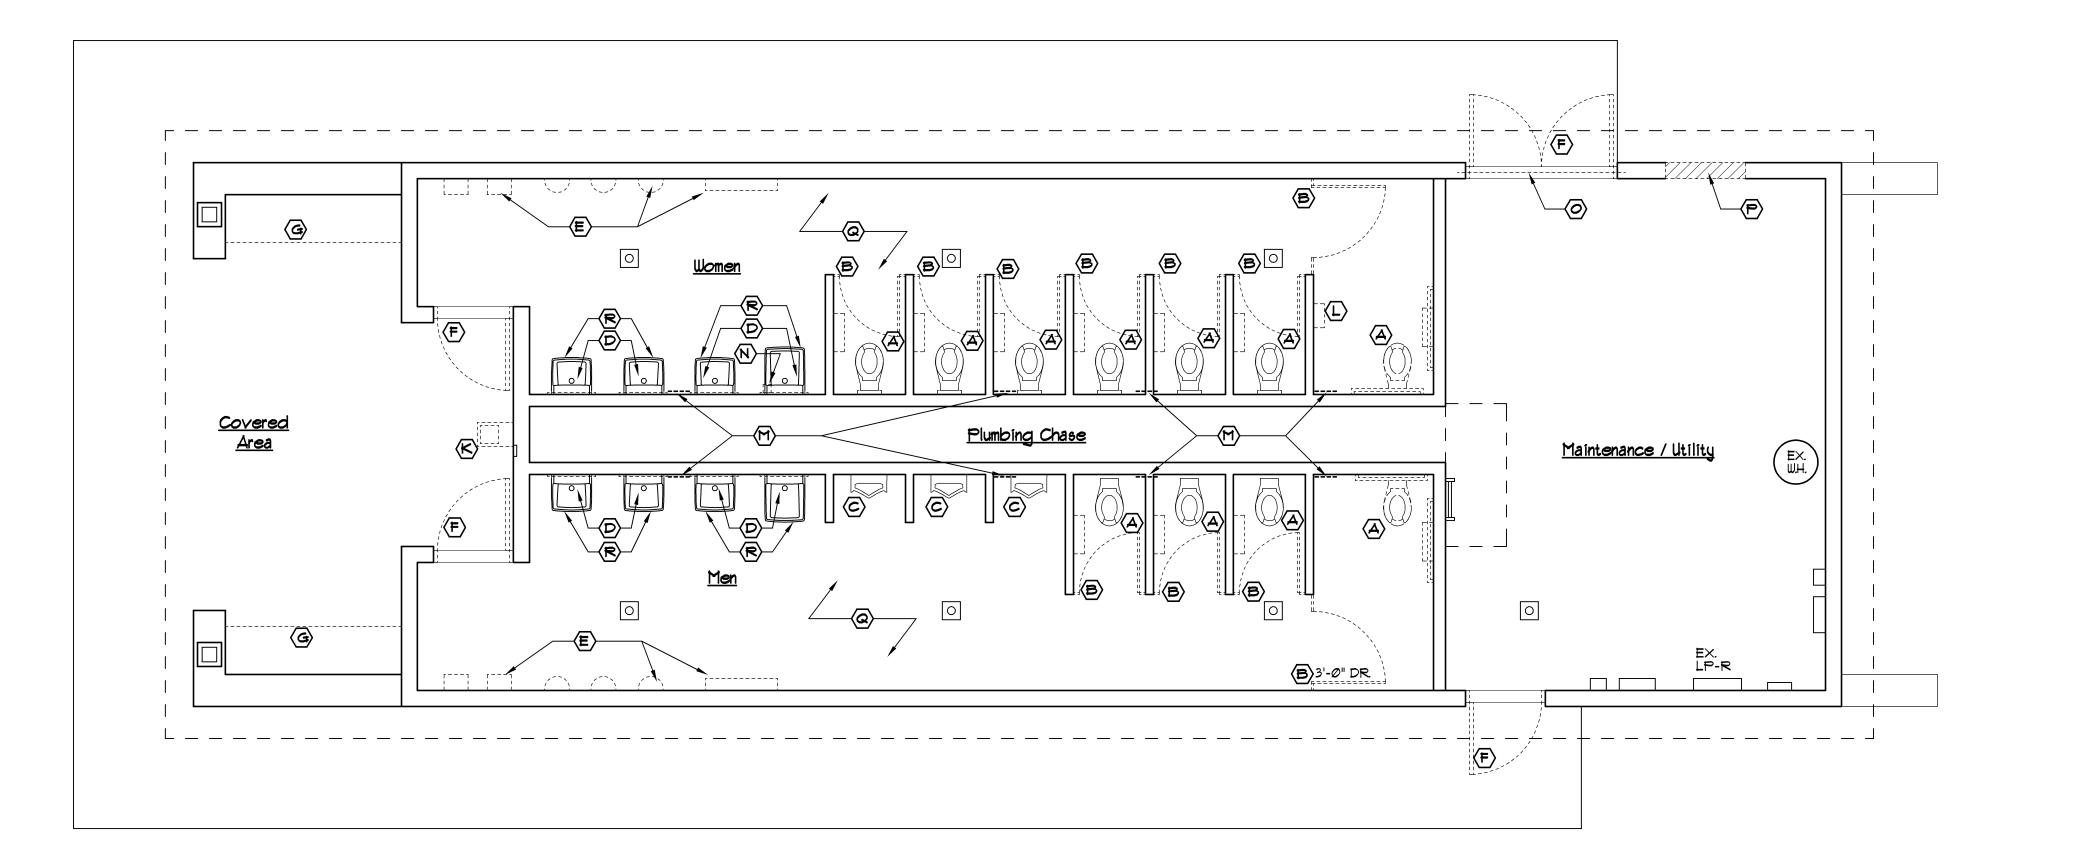
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#### DEMOLITION KEYED NOTES:

- REMOVE ALL TOILETS, TOILET PAPER DISPENSERS, "NEAT SEAT" DISPENSERS AND GRAB BARS
- (B) REMOVE ALL METAL PARTITIONS AND DOORS
- C REMOVE ALL URNIALS
- REMOVE ALL SINKS AND MIRRORS, RECONFIGURE/ CAP PLUMBING LINES WITHIN WALL AS NECESSARY (SEE PLUMBING DRAWINGS)
- REMOVE ALL HAND DRYERS, PAPER TOWEL DISPENSERS, AND BABY CHANGING STATIONS
- F REMOVE ALL DOORS, THRESHOLDS, HARDWARE AND SIGNAGE FRAMES AT UNMODIFIED OPENINGS
- G REMOVE EXTERIOR BENCHES
- (H) REMOVE LIGHT FIXTURES
- (T) REMOVE PLYWOOD SOFFIT / CEILING
- DASHED LINE REPRESENTS PORTION OF SOFFIT TO BE MODIFIED PER NEW BUILDING ELEVATIONS
- REMOVE DRINKING FOUNTAIN AND CAP PLUMBING LINES WITHIN WALL
- (L) REMOVE CHILD PROTECTION SEAT
- REMOVE AND REPLACE VENTS (SEE MECHANICAL DRAWING FOR MORE INFORMATION)
- N REMOVE SOAP DISPENSER
- (O) REMOVE EXISTING DOOR FRAME AND STEEL LINTEL
- PORTION OF EXISTING CONCRETE BLOCK WALL TO BE REMOVED FOR NEW DOOR
- (Q) C.T. FLOOR AND BASE TO BE REMOVED
- REMOVE IX4 TRIM BD. AT CEILING










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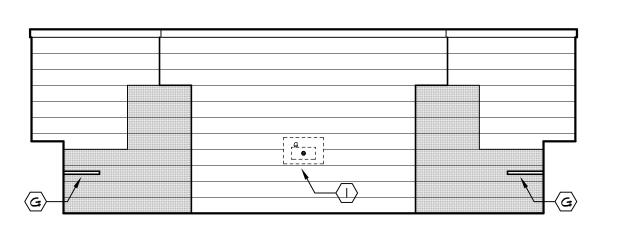
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5 Elevation @ Entry Wall


A3 Scale: 1/4" = 1'-0"





- REMOVE EXISTING ASPHALT SHINGLES AND UNDERLAYMENT
- REMOVE EXISTING GUTTERS AND DOWNSPOUTS
- (C) REMOVE EXISTING VENTING LOUVERS
- REMOVE EXISTING SIDING
- REMOVE BLOCK AS NECESSARY FOR NEW DOORS (SEE BUILDING ELEVATIONS)
- REMOVE EXISTING DORMER AND OVERHANG AS NECESSARY FOR NEW ELEVATION DESIGN (SEE BUILDING ELEVATIONS)


REMOVE EXISTING WOOD BENCH

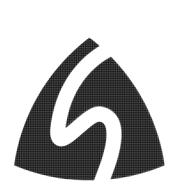- REMOVE DAMAGED 4" MASONRY CAP TO BE REPLACED (SEE BUILDING ELEVATIONS)
- REMOVE DRINKING FOUNTAIN AND CAP PLUMBING LINES WITHIN WALL
- REPLACE GLAZING IN EXISTING AWNING WINDOWS ON WOMEN'S RESTROOM SIDE
- K AWNING WINDOWS TO REMAIN

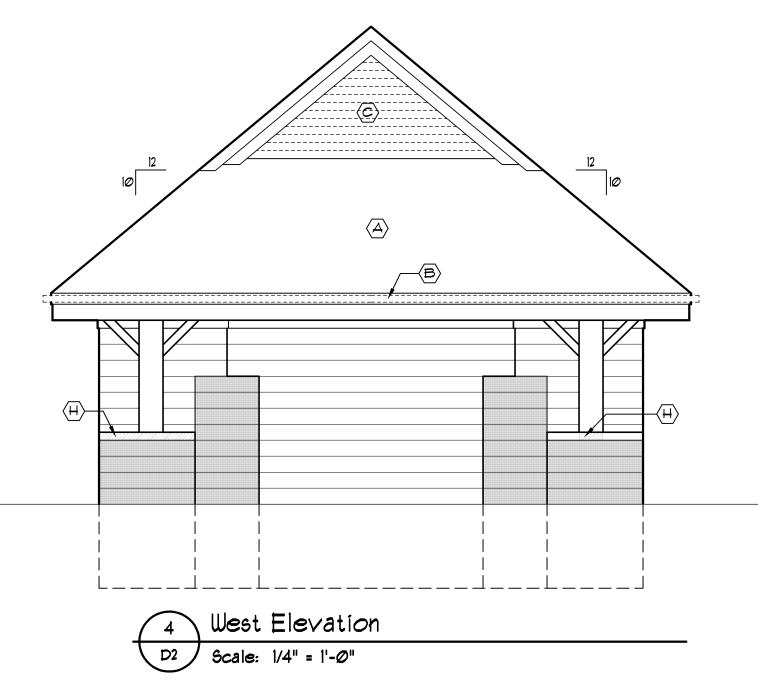

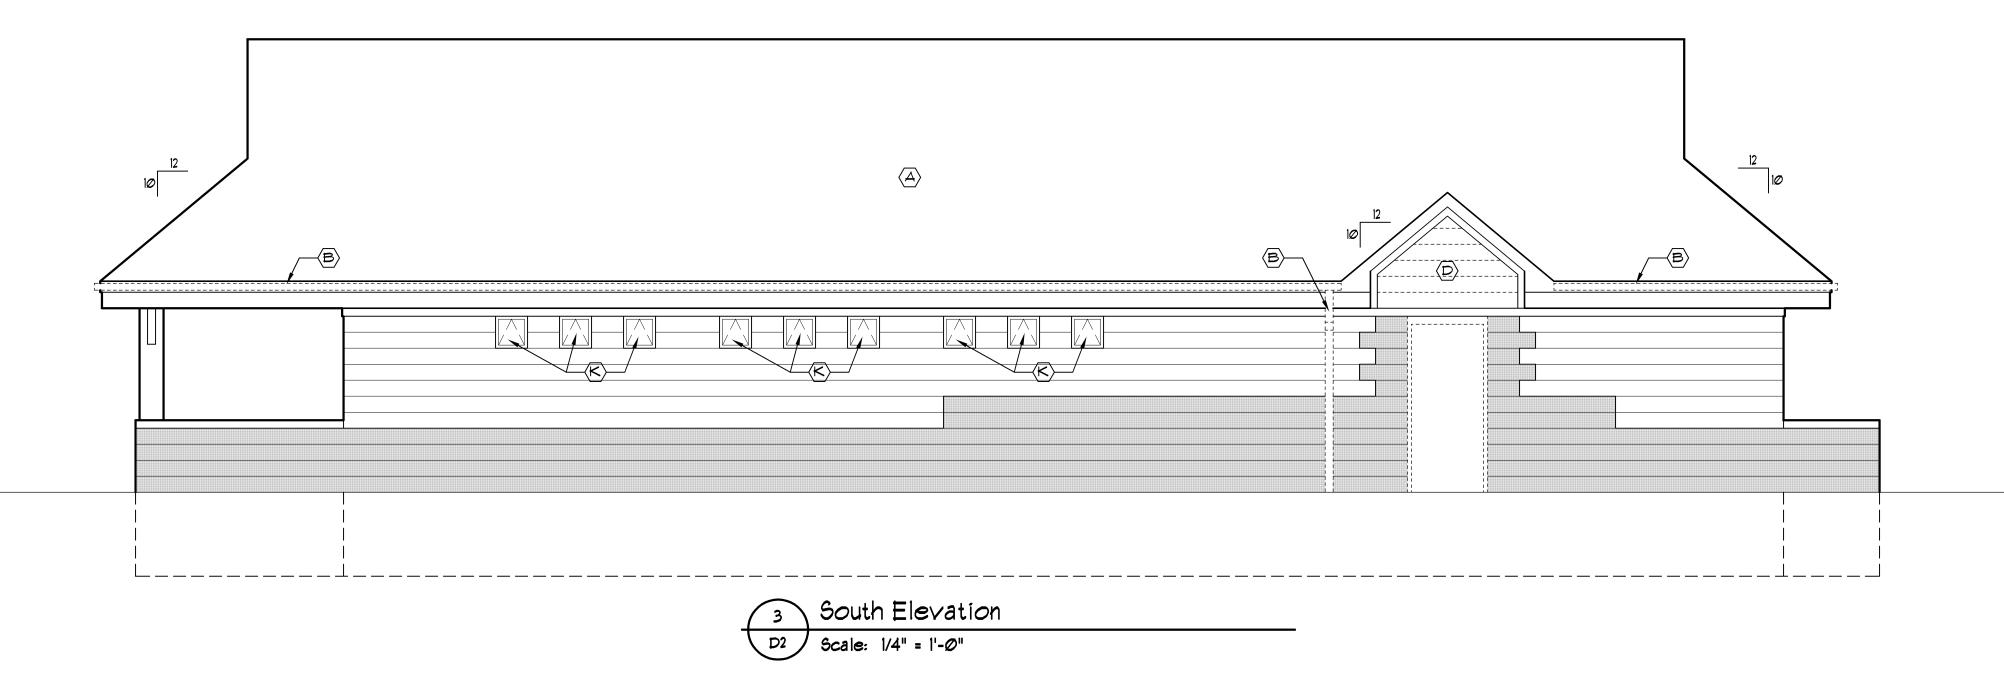

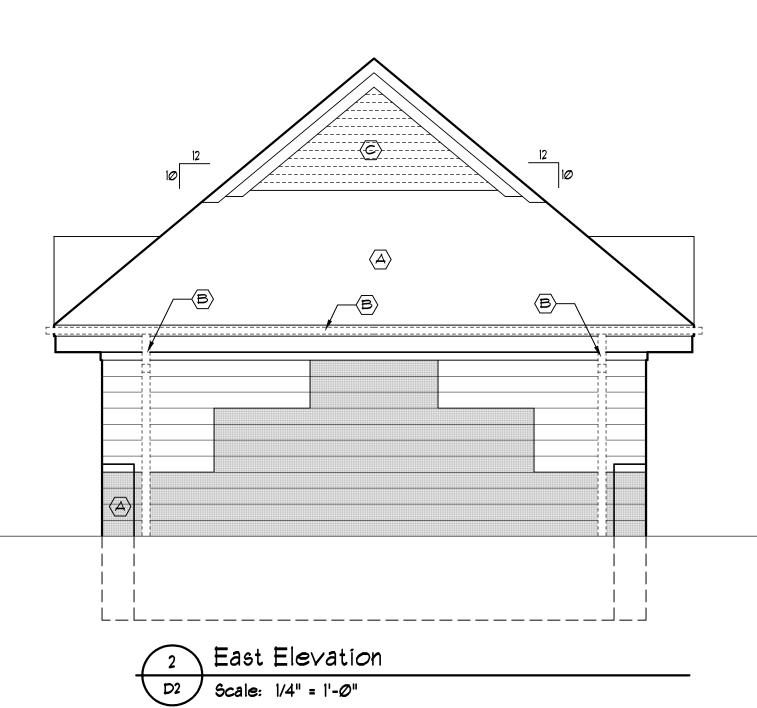

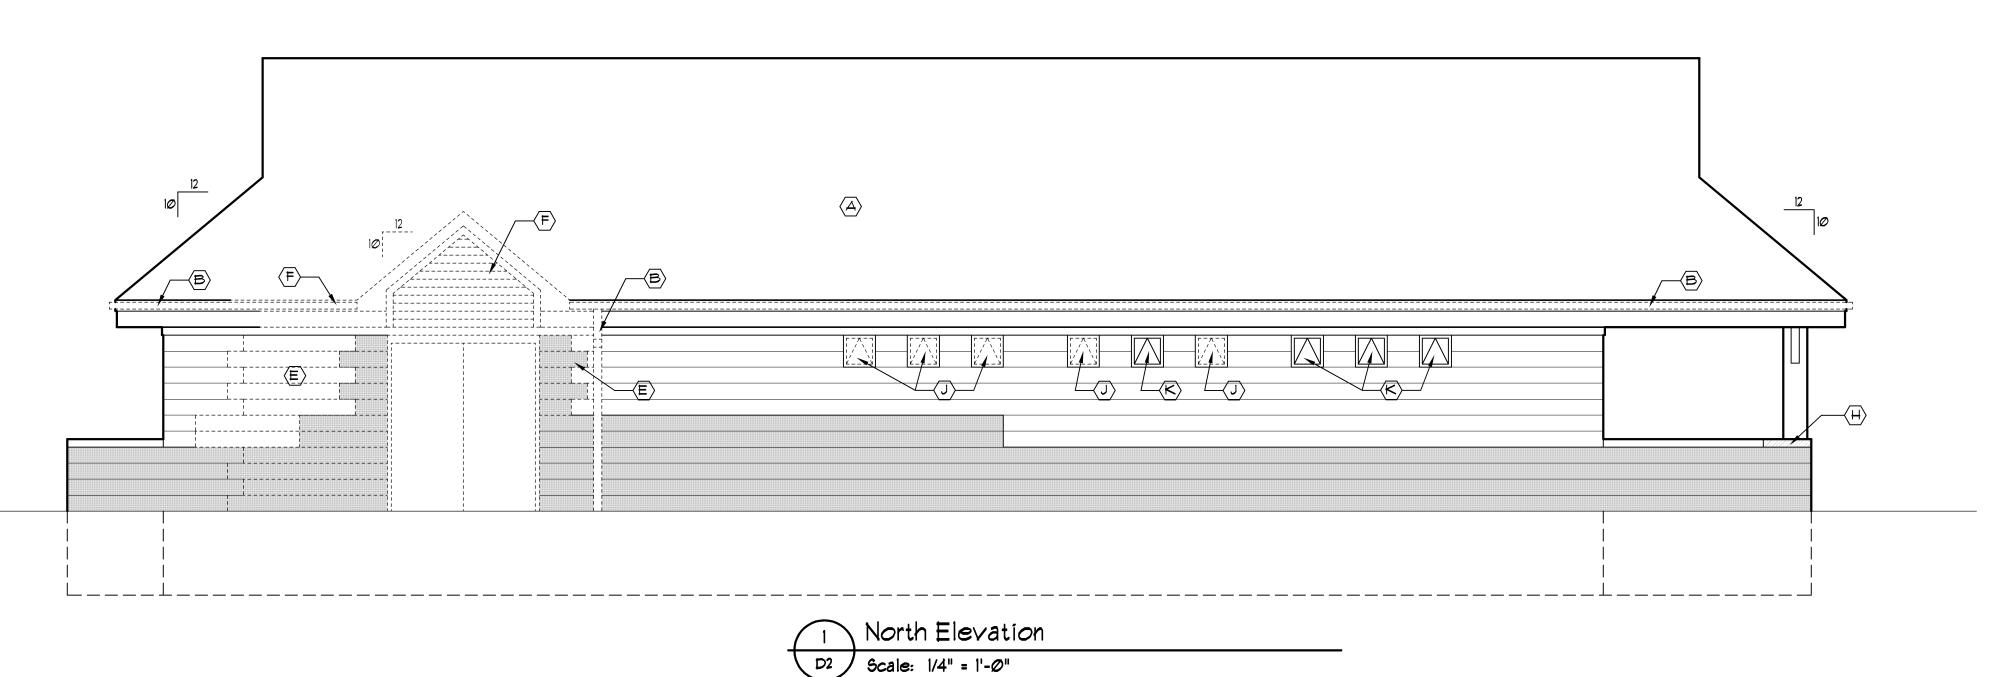

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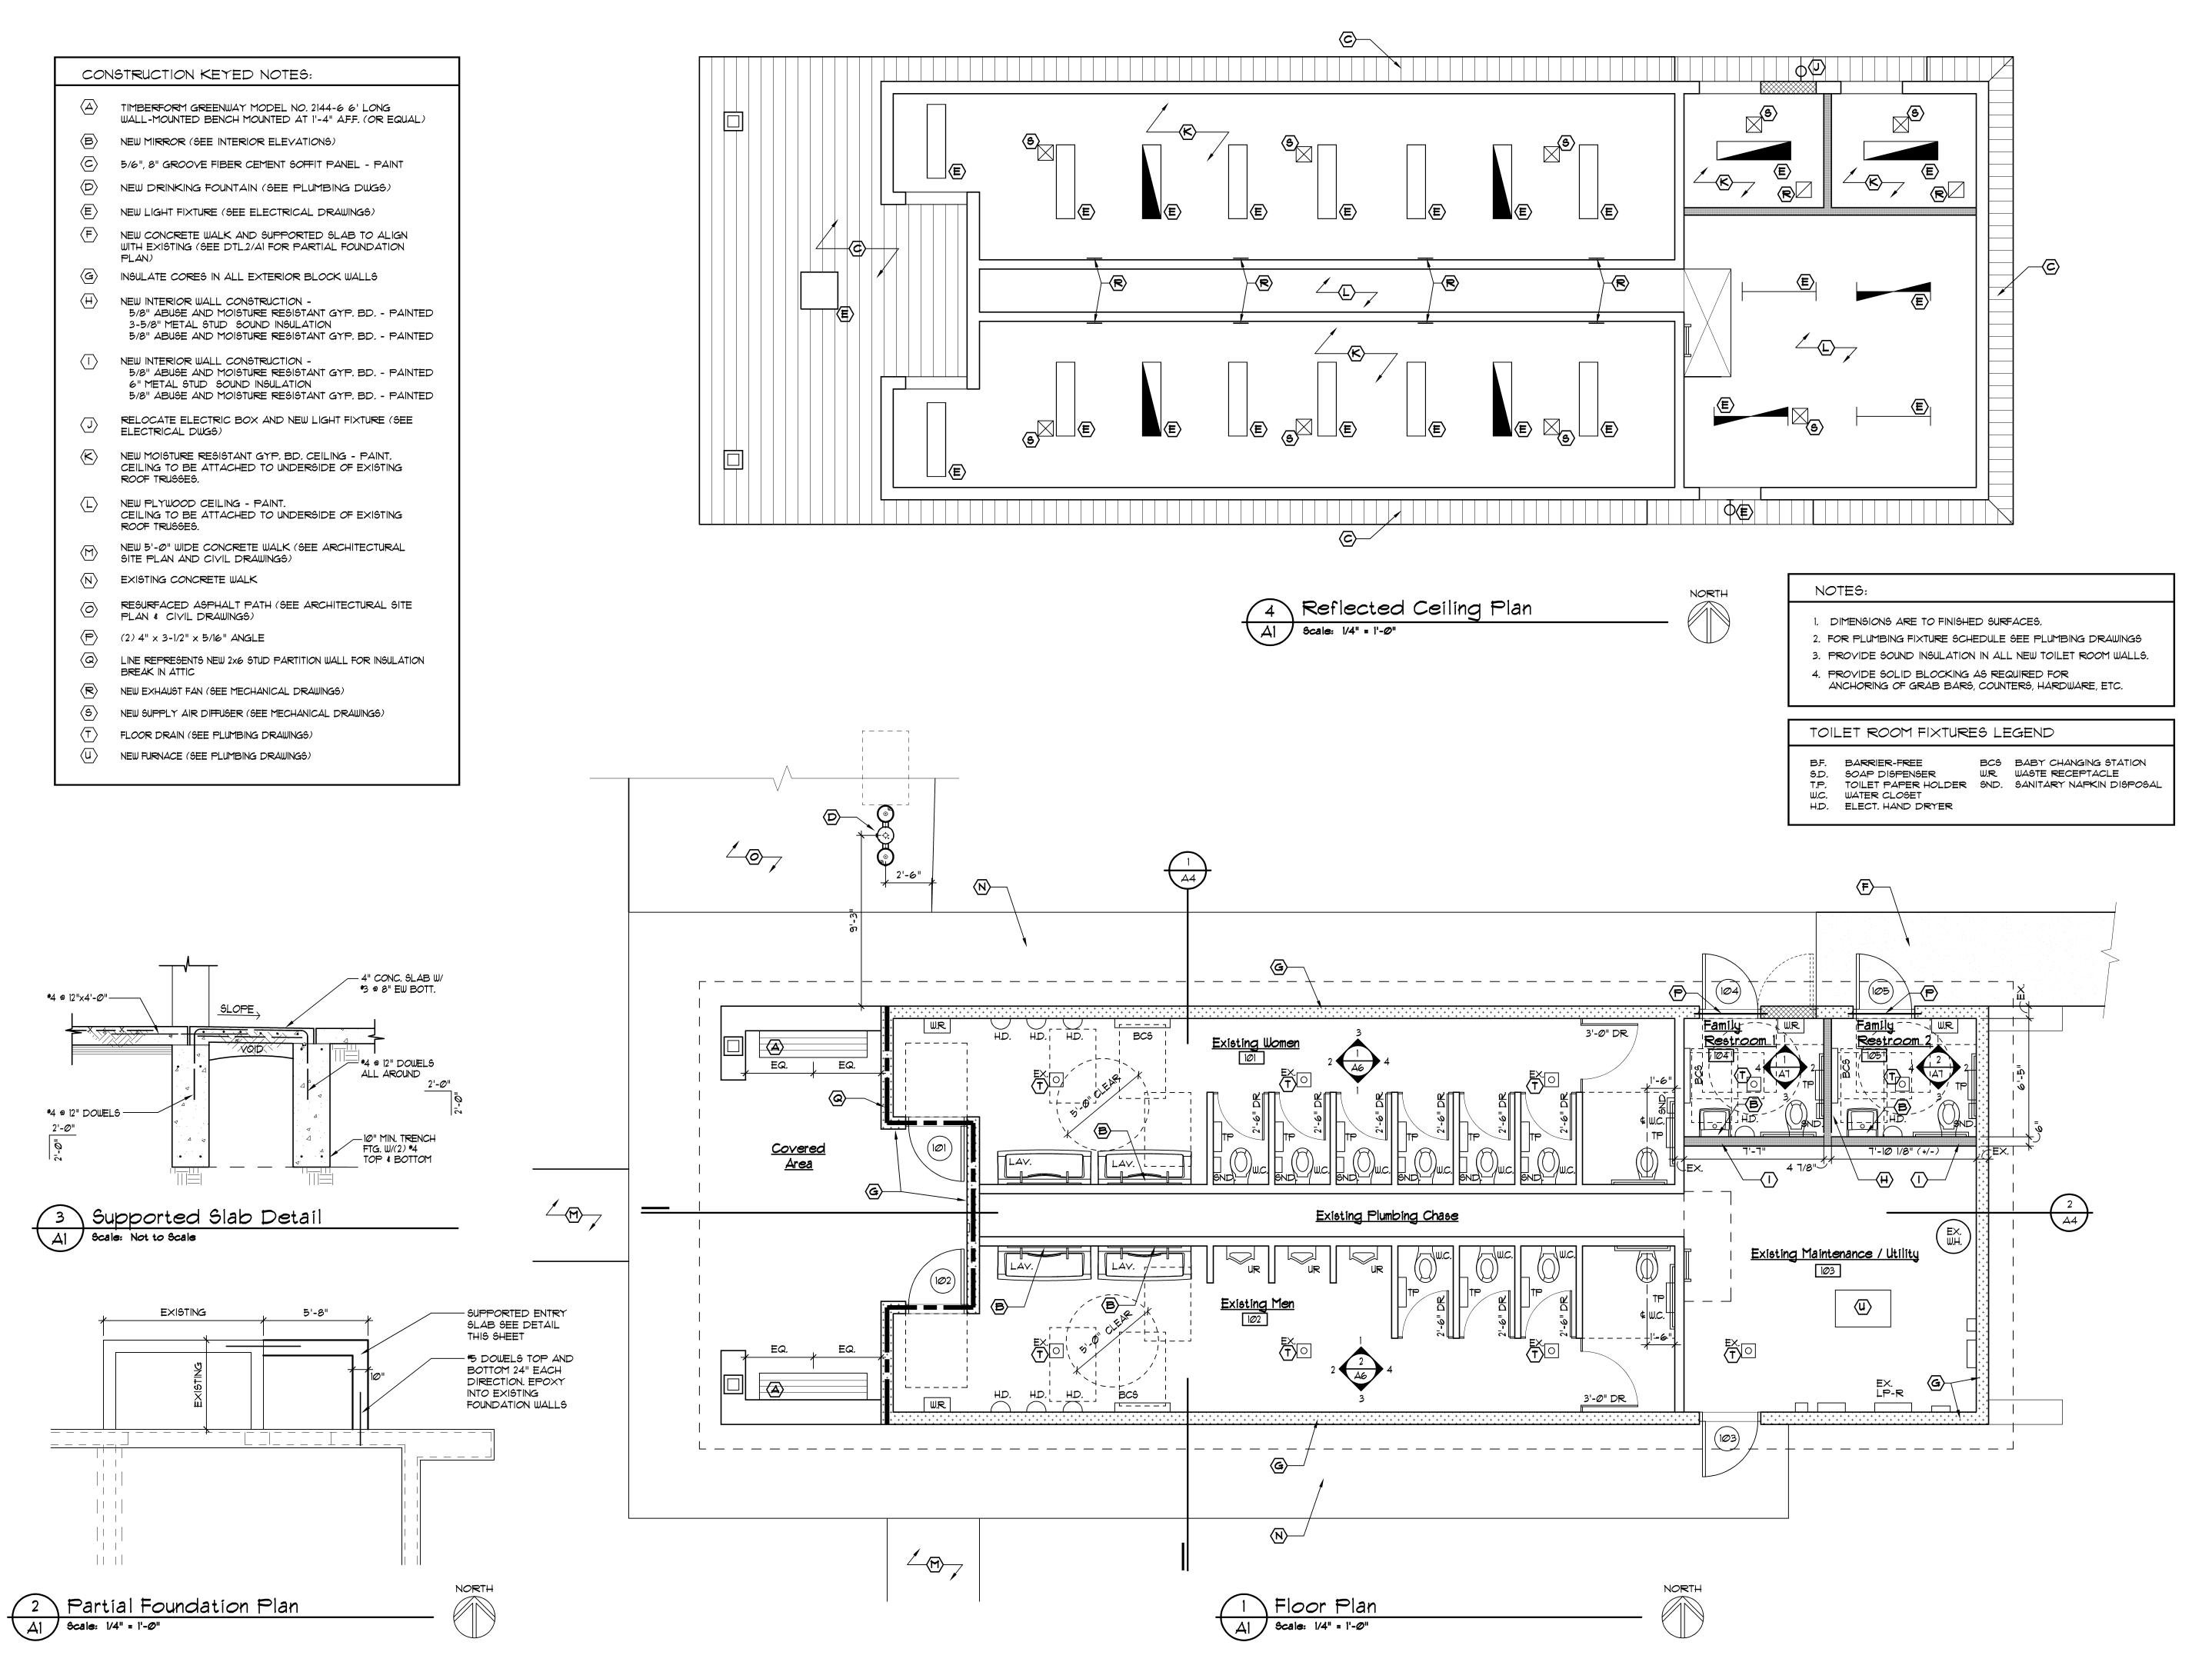
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ROOM	ROOM	FLOOR	BASE	CEILING			WALLS				REMARKS
NO.	NAME			MTL.	HGT.	FINISH	Ν	E	S	W	
101	EXISTING WOMEN'S RESTROOM	C.T6,7,8,9	C.T 6	GYP. BD.	9'-4"	PT 4	MAS./PT 3	MAS./PT 3	MAS./PT 3	MAS./PT 3	SEE CT TILE PATTERN TYPICAL
1Ø2	EXISTING MEN'S RESTROOM	C.T6,7,8,9	C.T 6	GYP. BD.	9'-4"	PT 4	MAS./PT 3	MAS./PT 3	MAS./PT 3	MAS./PT 3	SEE CT TILE PATTERN TYPICAL
103	EXISTING MAINTENANCE/UTILITY	-	-	PLYWOOD	9'-4"	PT 4	MAS./PT 3	MAS./PT 3	MAS./PT 3	MAS./PT 3	
104	FAMILY RESTROOM I	C.T 6 \$ 7	C.T 5	GYP. BD.	9'-4"	PT 4	MAS./PT 3	GYP./PT 8 C.T 5	GYP./PT 8 C.T 5	MAS./PT 3	SEE CT TILE PATTERN TYPICAL
1Ø5	FAMILY RESTROOM 2	C.T 6 \$ 7	C.T 5	GYP. BD.	9'-4"	PT 4	MAS./PT 3	MAS./PT 3	GYP./PT 8 C.T 5	GYP./PT 8 C.T 5	SEE CT TILE PATTERN TYPICAL

	DOOR SCHEDULE													
DOOR	DOOR SIZE		DOOR		HDWR.	R. FRAME				DETAILS		1 40-	CODED	
NO.	DOOR SIZE	TYPE MAT'L. FINISH					YPE MAT'L, FINISH		SILL	JAMB	HEAD	LABEL	REMARKS	
101	3'-@"xT'-@"x1-3/4"	В	H.M.	PAINT	-	E×.	H.M.	PAINT	2Ø2	-	-	-	1, 5, 10, 12, 13, 14	
1Ø2	3'-@"xT'-@"x1-3/4"	B	H.M.	PAINT	-	E×.	H.M.	PAINT	2Ø2	-	-	-	1, 5, 10, 12, 13, 14	
1Ø3	3'-0"x1'-0"x1-3/4"	Д	H.M.	PAINT	-	E×.	H.M.	PAINT	2Ø2	-	-	-	1, 5, 11, 14, 15	
104	3'-0"x1'-0"x1-3/4"	В	H.M.	PAINT	-	<b>F</b> 1	H.M.	PAINT	2Ø2	2Ø1	-	-	1, 5, 9, 10, 14	
1Ø5	3'-Ø"x1'-Ø"x1-3/4"	В	H.M.	PAINT	-	<b>F</b> 1	H.M.	PAINT	2Ø2	2Ø1	-	-	1, 5, 10, 12, 13, 14	

#### ABBREVIATIONS CODED REMARKS

AL./GL. = ALUMINUM & GLASS 1. CLOSER ALUM. = ALUMINUM SAFETY GLASS VISION LITE CANOD. = CLEAR ANODIZED 3. SAFETY GLASS SIDE LITE

= BI-FOLD 4. VINYL CARPET TO TILE JOINER = HOLLOW METAL 5. METAL THRESHOLD = HOLLOW METAL KNOCK DOWN 6. MARBLE THRESHOLD

= GLASS 7. YINYL REDUCING STRIP = BY MANUFACTURER 8. TERRAZZO STRIP = OVERHEAD DOOR 9. GROUT FILLED FRAME = PRE-FIN. METAL KNOCK DOWN FRAME

10. LIMIT DOOR TO 90° SWING = PLASTIC LAMINATE 11. DOOR TO OPEN 135° = PRE-FINISHED 12. PUSH / PULL = STEEL

CONC. BLOCK - -

CORE SOLID

GROUT FIRST BLOCK


13. WALL MOUNTED DOOR STOP 14. WEATHER STRIPPING

15. KICK DOWN DOOR STOP

# GENERAL DOOR & FRAME NOTES

1. ALL DOOR FRAMES ARE TO RECEIVE CONTINUOUS BEAD OF SEALANT AT PERIMETER - BOTH SIDES.

2. ALL H.M. FRAMES SHALL BE GROUT FILLED. 3. ALL H.M. DOORS TO BE GALVANIZED, PAINTED

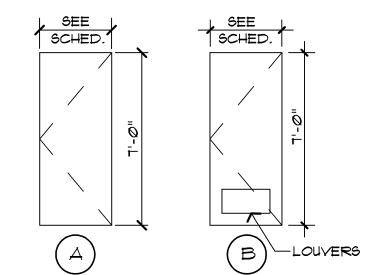

DOOR TYPES

NO SCALE


PROVIDE BULLNOSE BLOCK AT ALL

EXPOSED INTERIOR

C.M.U. JAMBS TYP.

CONT. SEALANT

EACH SIDE OF FRAME (TYP).

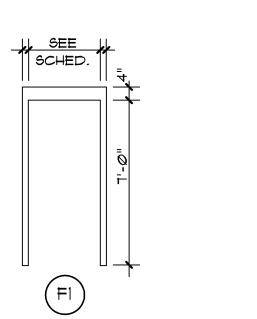

FRAME TYPES

- VALLEY FLASHING (TYP.)

VALLEY FLASHING (TYP.)

NO SCALE

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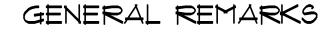
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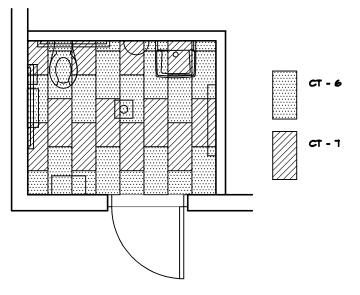
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# MATERIAL KEY


- = ACOUSTIC CEILING TILE ACC = ACOUSTIC CEILING CANOPY AL/GL. = ALUMINUM & GLASS
- = CABINETRY CONC. = CONCRETE CPT. = CARPET C.T. = CERAMIC TILE
- C.T.B. = CERAMIC TILE BASE E.C. = EXPOSED CONSTRUCTION = EPOXY PAINT
- = FABRIC WALL COVERING G.B. = GYPSUM BOARD MAS. = MASONRY
- = PRE-FIN. METAL KNOCK DOWN FRAME
- P. LAM. = PLASTIC LAMINATE
- PRE-FIN. = PRE-FINISHED = RUBBER BASE WD. = STAINED WOOD
- V.B. = VINYL BASE YCT. = VINYL COMPOSITION TILE **VSF** = VINYL SHEET FLOORING
- = YINYL WALL COVERING YWC. = WALL PROTECTION




- 1. FLOOR MATERIAL CHANGES OCCUR AT CENTERLINE OF DOOR.
- 2. ACCESS PANELS, ELECTRICAL PANELS, HVAC REGISTERS & FIRE EXTINGUISHER CABINETS SHALL BE PRE-FINISHED OR PAINTED TO MATCH ADJACENT WALLS OR CEILINGS.
- 3. ALL DOOR & WINDOW FRAMES TO RECEIVE A CONTINUOUS BEAD OF SEALANT AT ALL PERIMETER EDGES.
- 4. ALL EXPOSED STEEL SHALL BE PAINTED.
- 5. REFER TO REFLECTED CEILING PLANS AND SECTIONS WHERE CEILING HEIGHT VARIES.
- 6. ALL GYPSUM BOARD SOFFITS SHALL BE PAINTED.




TYPICAL TOILET ROOM 104 \$ 105 CERAMIC TILE PATTERN

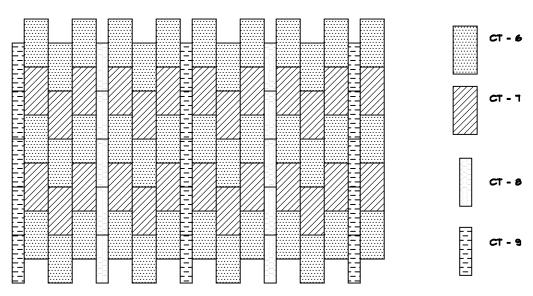

TYPICAL TOILET ROOM 101 \$ 102 CERAMIC TILE PATTERN

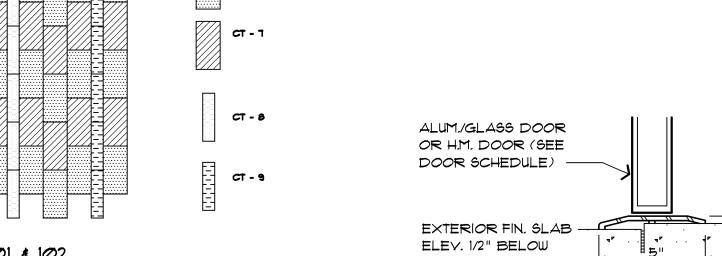


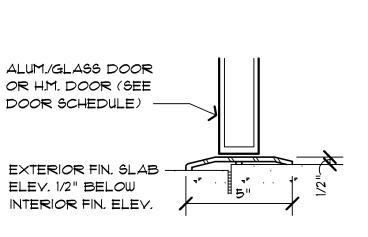


P. LAM.

STL.

WD.

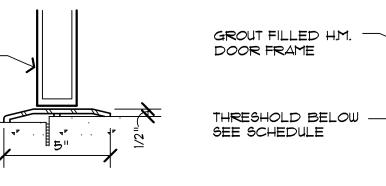

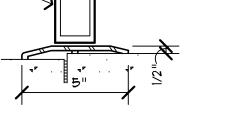



= STAIN & VARNISH (FIELD FINISHED)

= WOOD, SOLID CORE





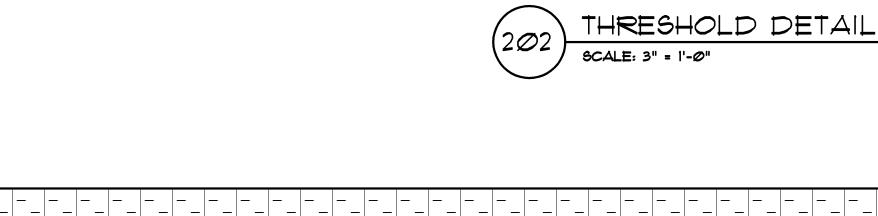


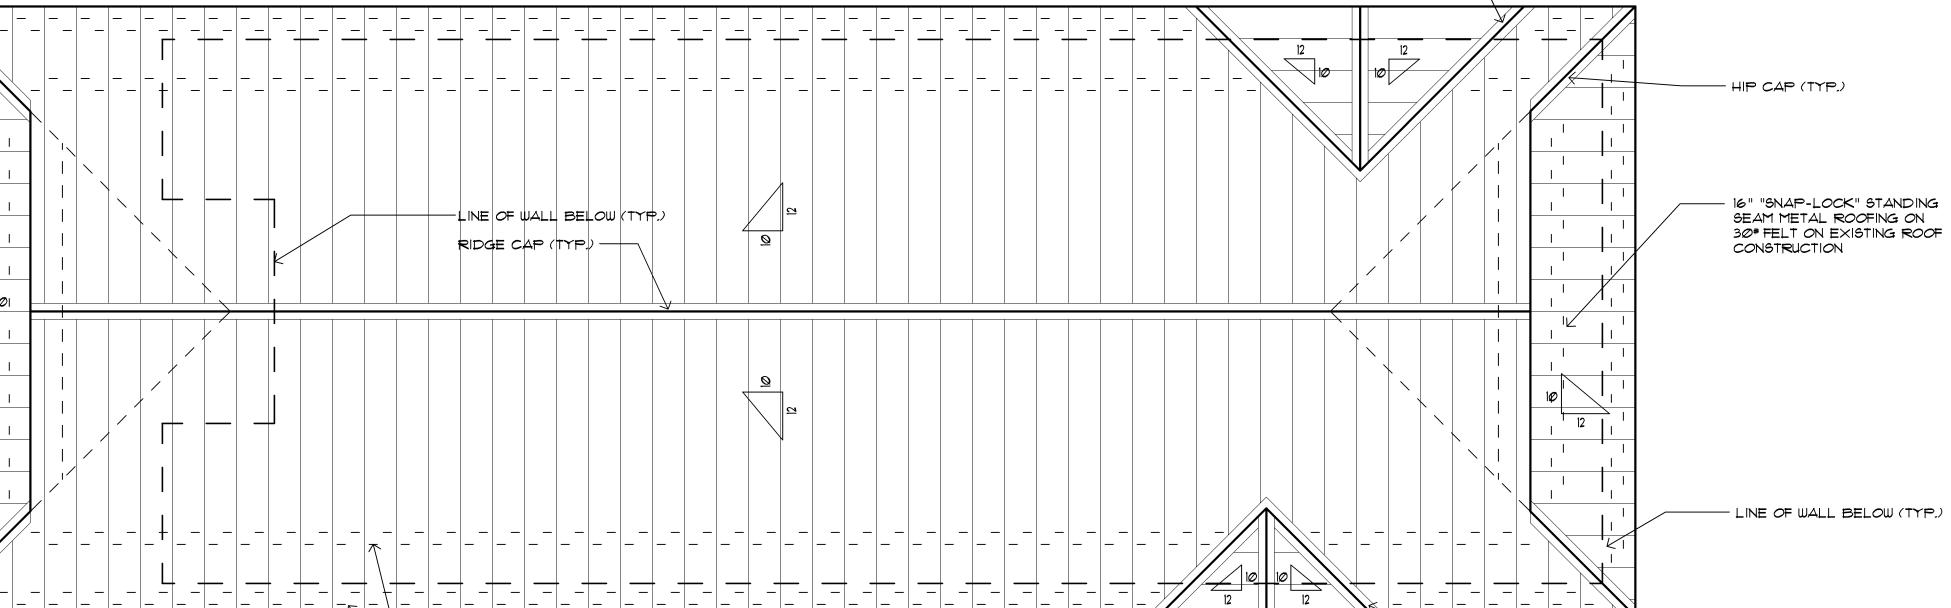

SNOW GUARDS PLACED STARTING 6" FROM EDGE. PLACE 2 GUARDS BETWEEN EACH 16" SEAM STAGGERED 6" APART. SECOND ROW 2'-0" UP ROOF FROM FIRST STAGGERED ROW.

Roof Plan Scale: 1/4" = 1'-0"



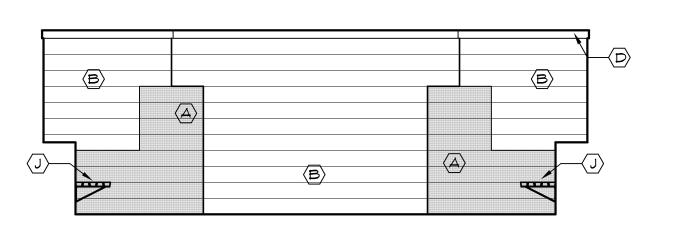


∖ Elevation @ Entry Wall A3 Scale: 1/4" = 1'-0"

# EXTERIOR FINISH MATERIAL SCHEDULE


- (A) EXISTING SPLIT FACE CONC. BLOCK TO REMAIN
- (B) EXISTING SMOOTH FACE CONC. BLOCK TO REMAIN
- © EXISTING MASONRY CAP TO REMAIN
- COVER EXISTING FASCIA/TRIM WITH ALUMINUM FACING -COLOR TO BE SELECTED
- (E) EXISTING AWNING WINDOW IN ANOD. ALUM. FRAME TO REMAIN
  - NEW "SNAP LOCK" STANDING SEAM METAL ROOF ON 30\* FELT ON EXISTING ROOF CONSTRUCTION
- (H) EXISTING 4x4 CEDAR BRACKET PAINT
- 5/4×4 SMOOTH FACE FIBER CEMENT TRIM BD. -PAINT COLOR TO BE SELECTED

(G) EXISTING CEDAR CLAD POST - PAINT


- TIMBERFORM GREENWAY MODEL NO. 2144-6 6' LONG WALL-MOUNTED BENCH MOUNTED AT 1'-4" A.F.F. (OR EQUAL)
- NEW PRE-FIN. ALUM. GUTTER COLOR TO BE SELECTED
  - NEW PRE-FIN. ALUM. DOWN SPOUT COLOR TO BE SELECTED
- WOODTONE RUSTIC SERIES FIBER CEMENT LAP SIDING: 1" EXPOSURE #211 WINCHESTER BROWN
- REPLACE GLAZING IN EXISTING ALUMINUM FRAME AWNING WINDOW
- REPLACE EXISTING DAMAGED 4" MASONRY CAP MATCH EXISTING FINISH AND COLOR
- R MASONRY INFILL TO MATCH B
- (5) SNOW GUARDS SEE ROOF PLAN FOR PLACEMENT

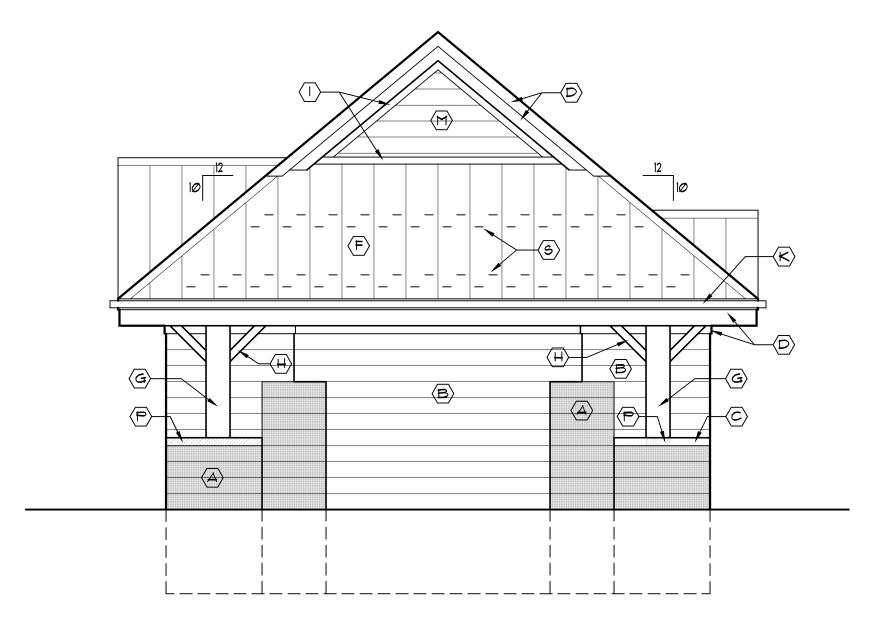




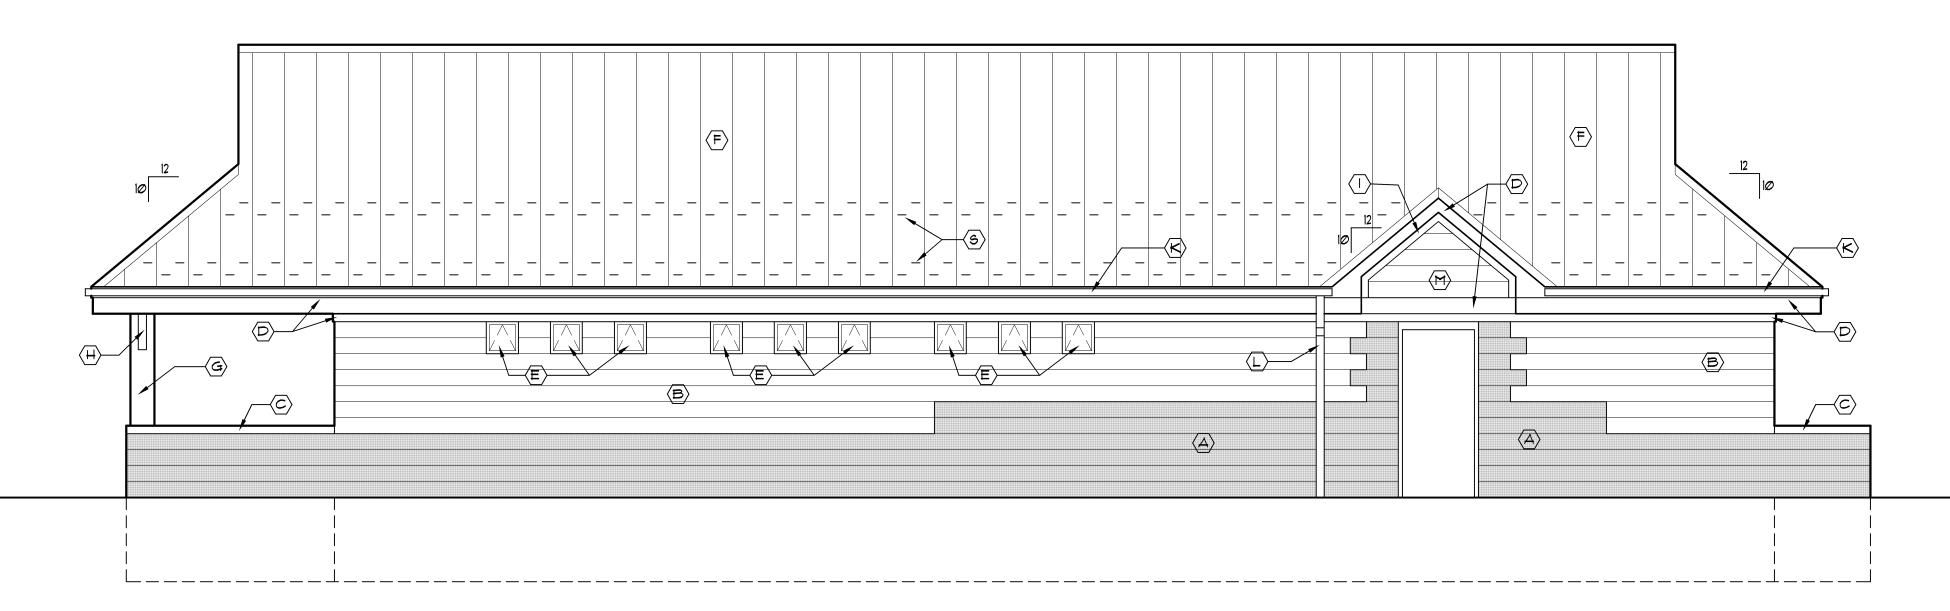



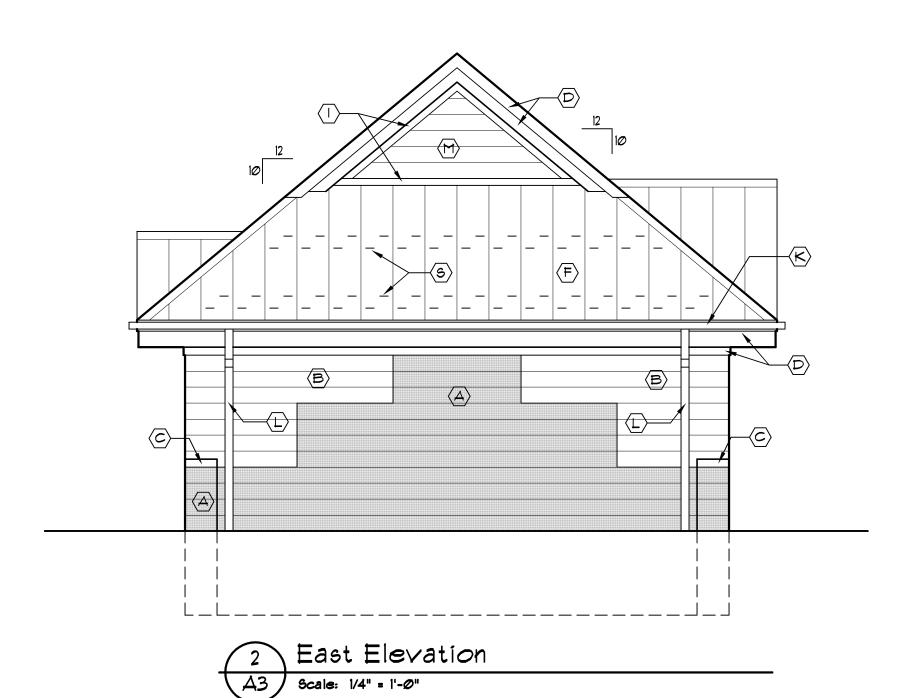

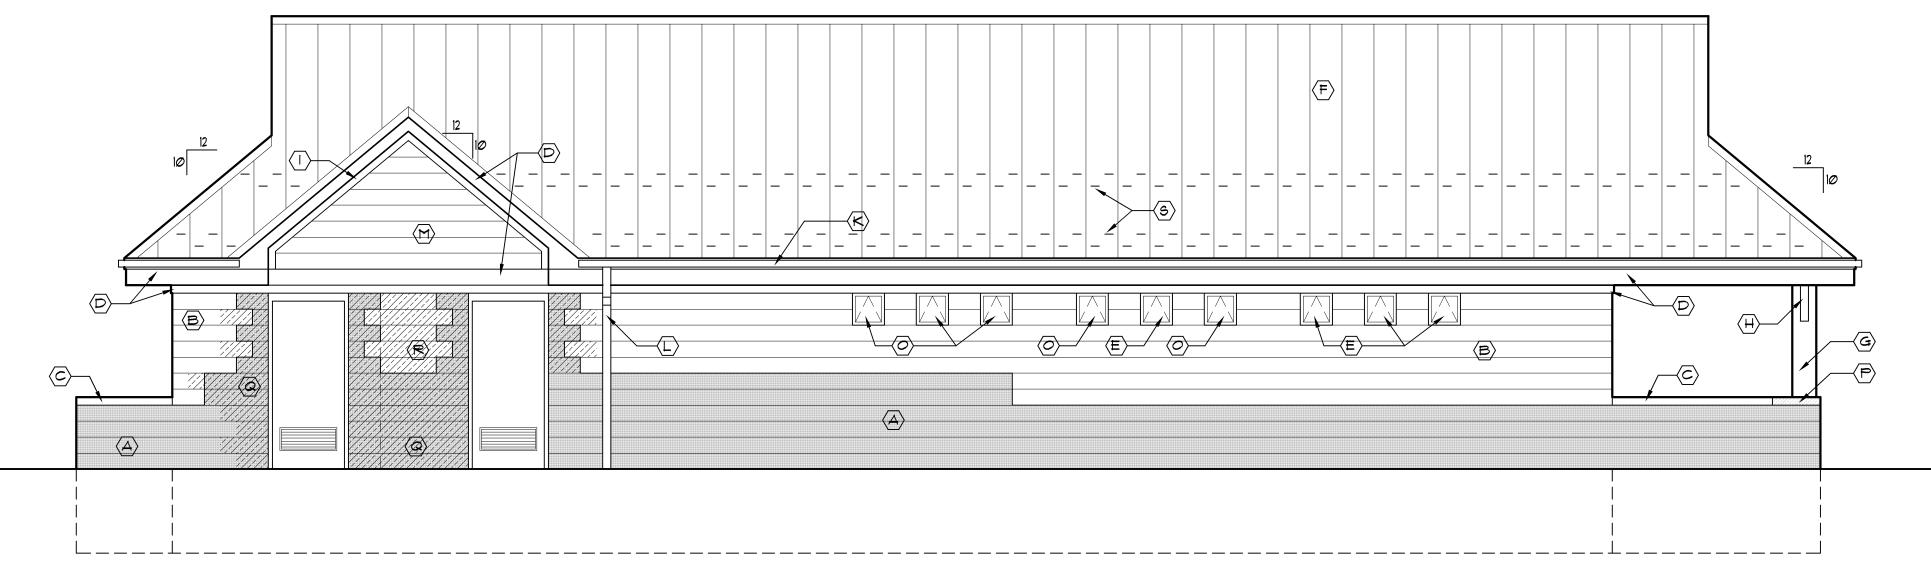


North Elevation

Scale: 1/4" = 1'-0"

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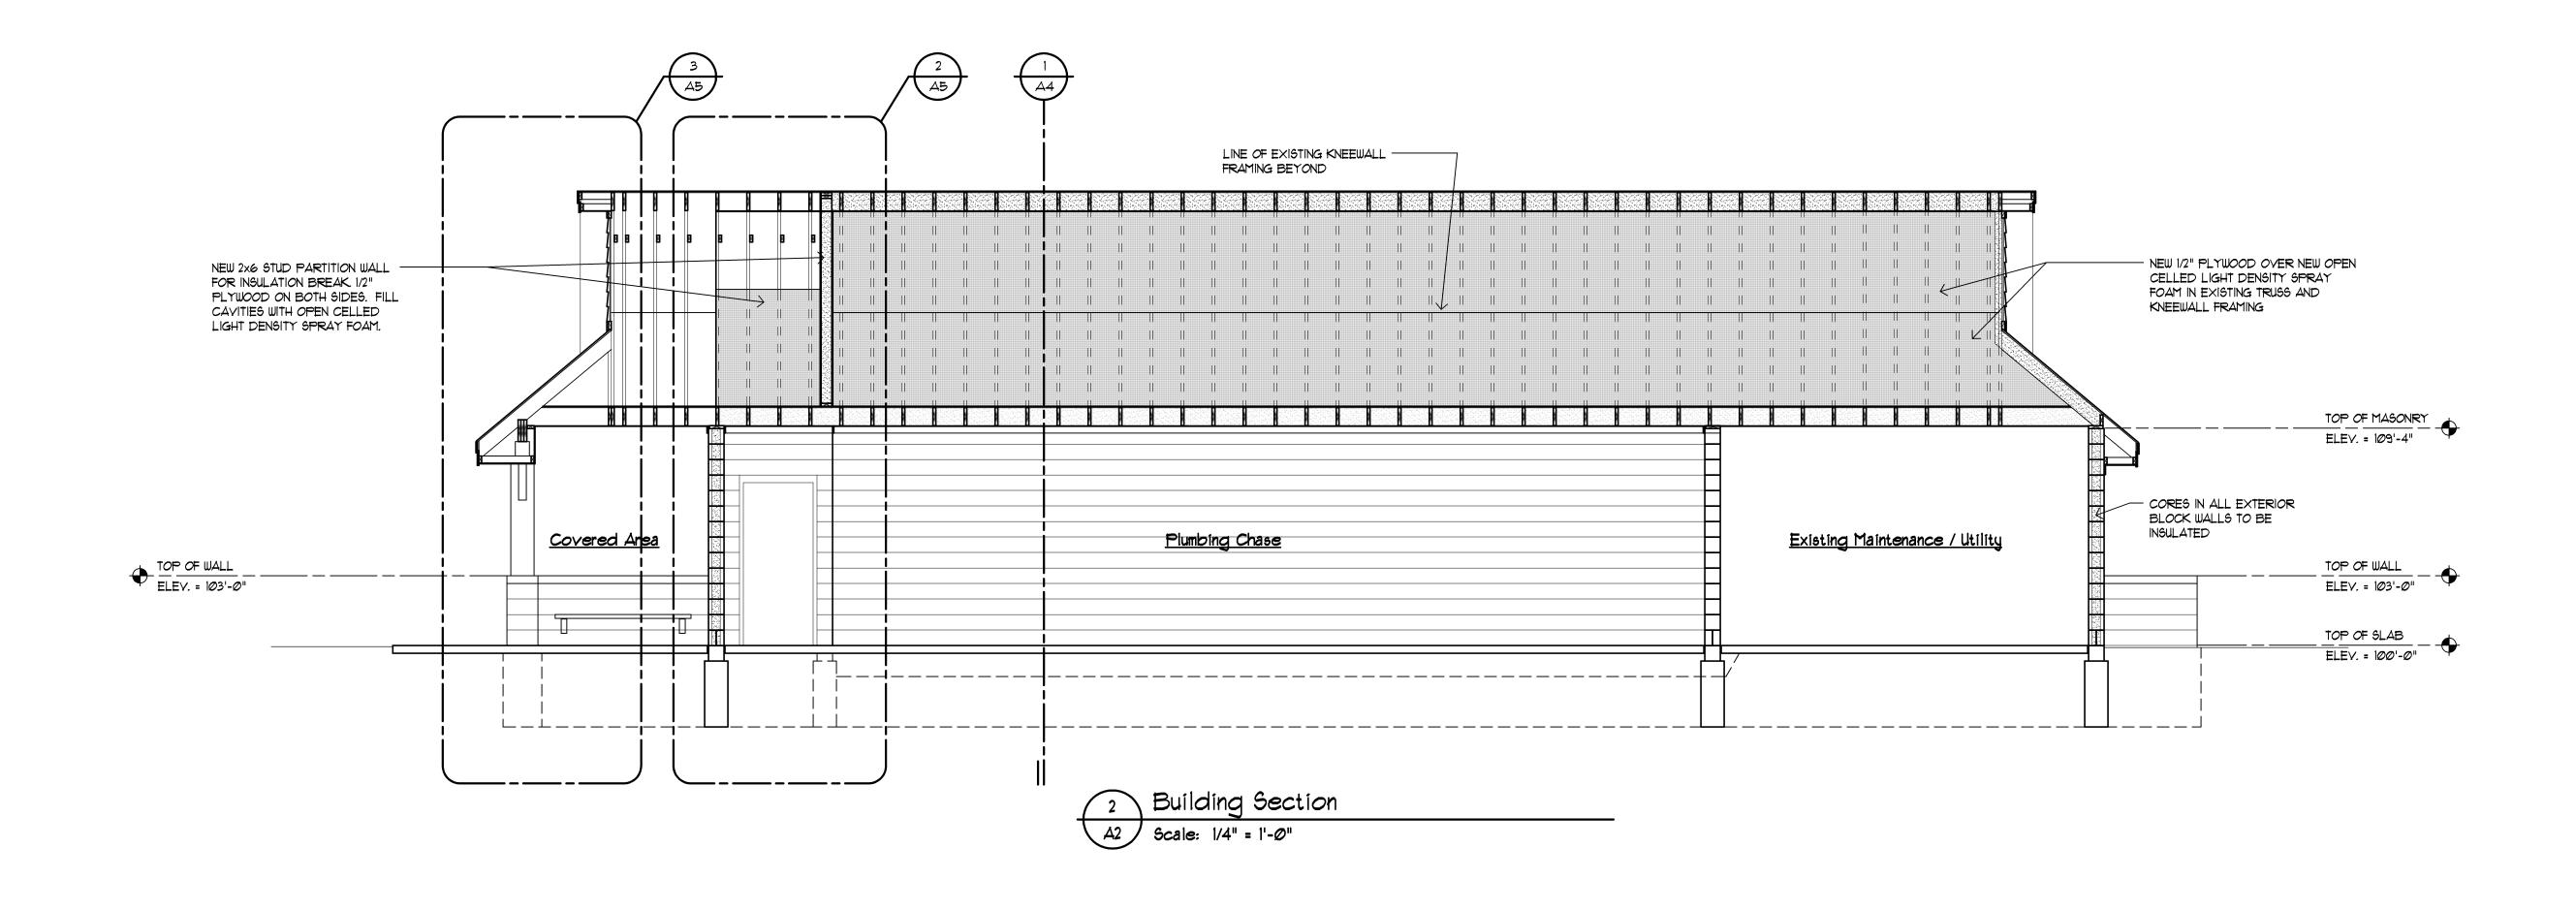
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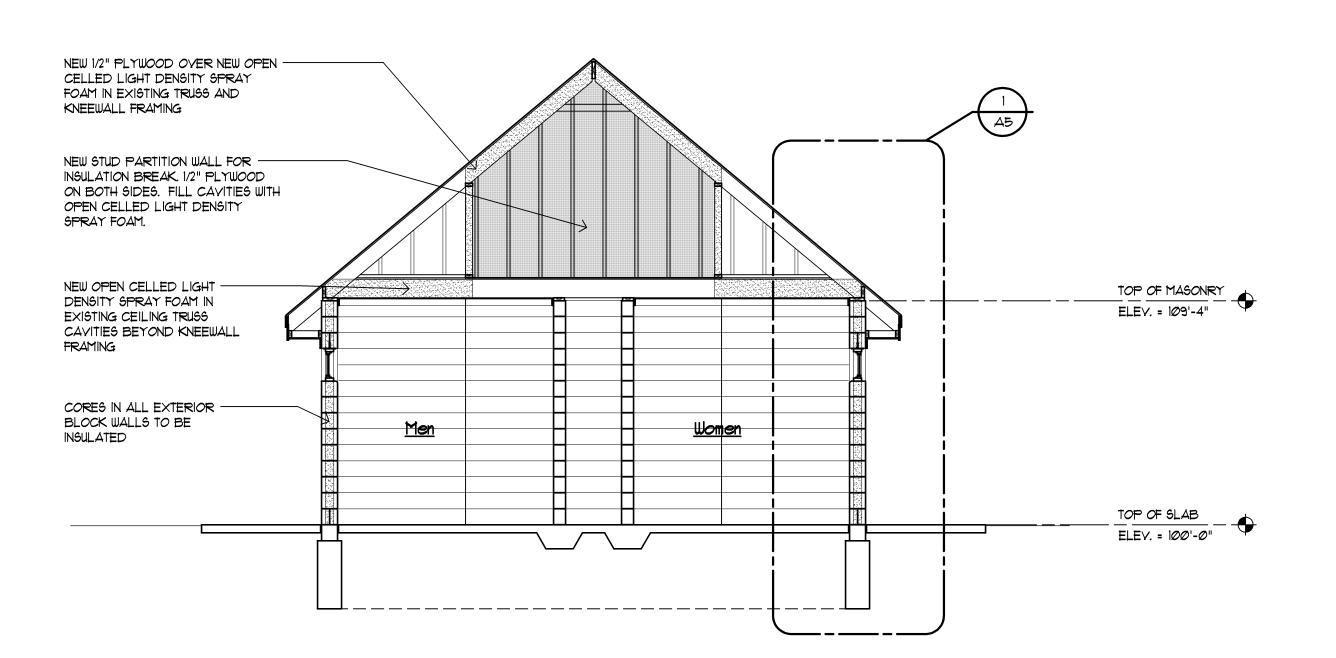
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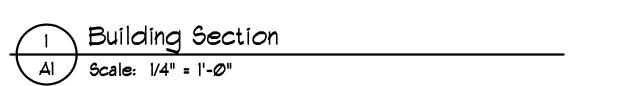
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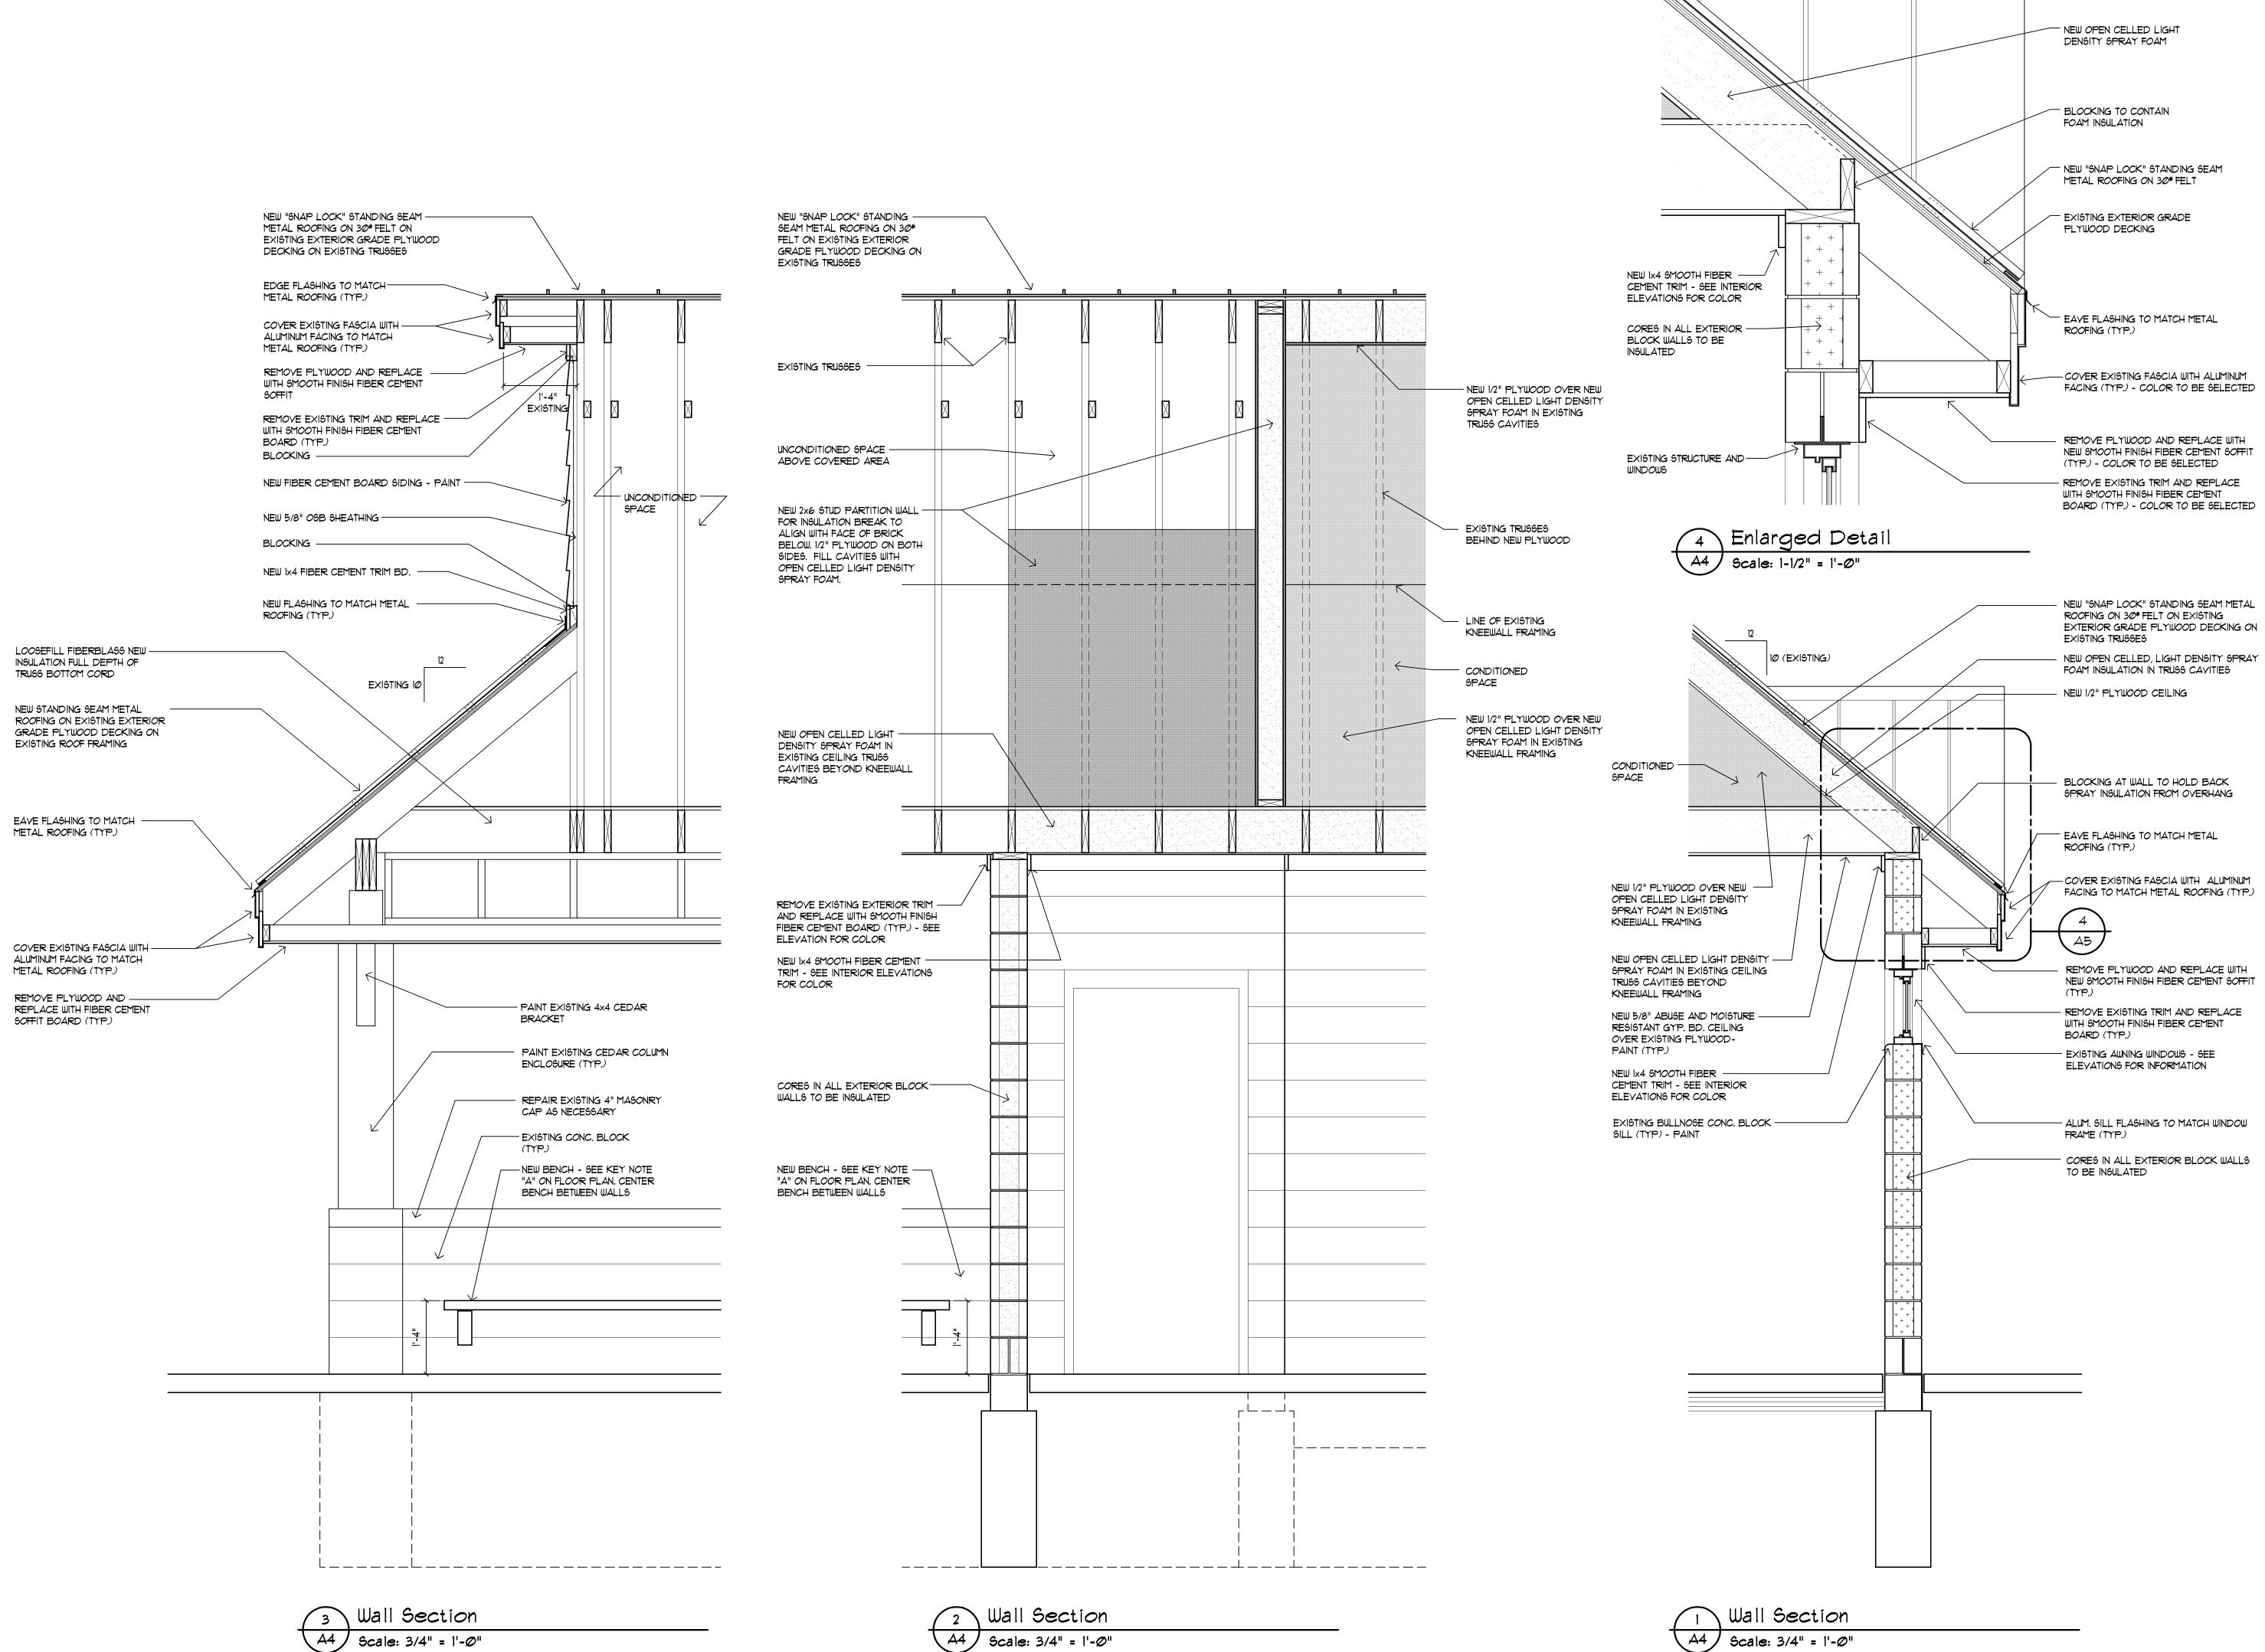


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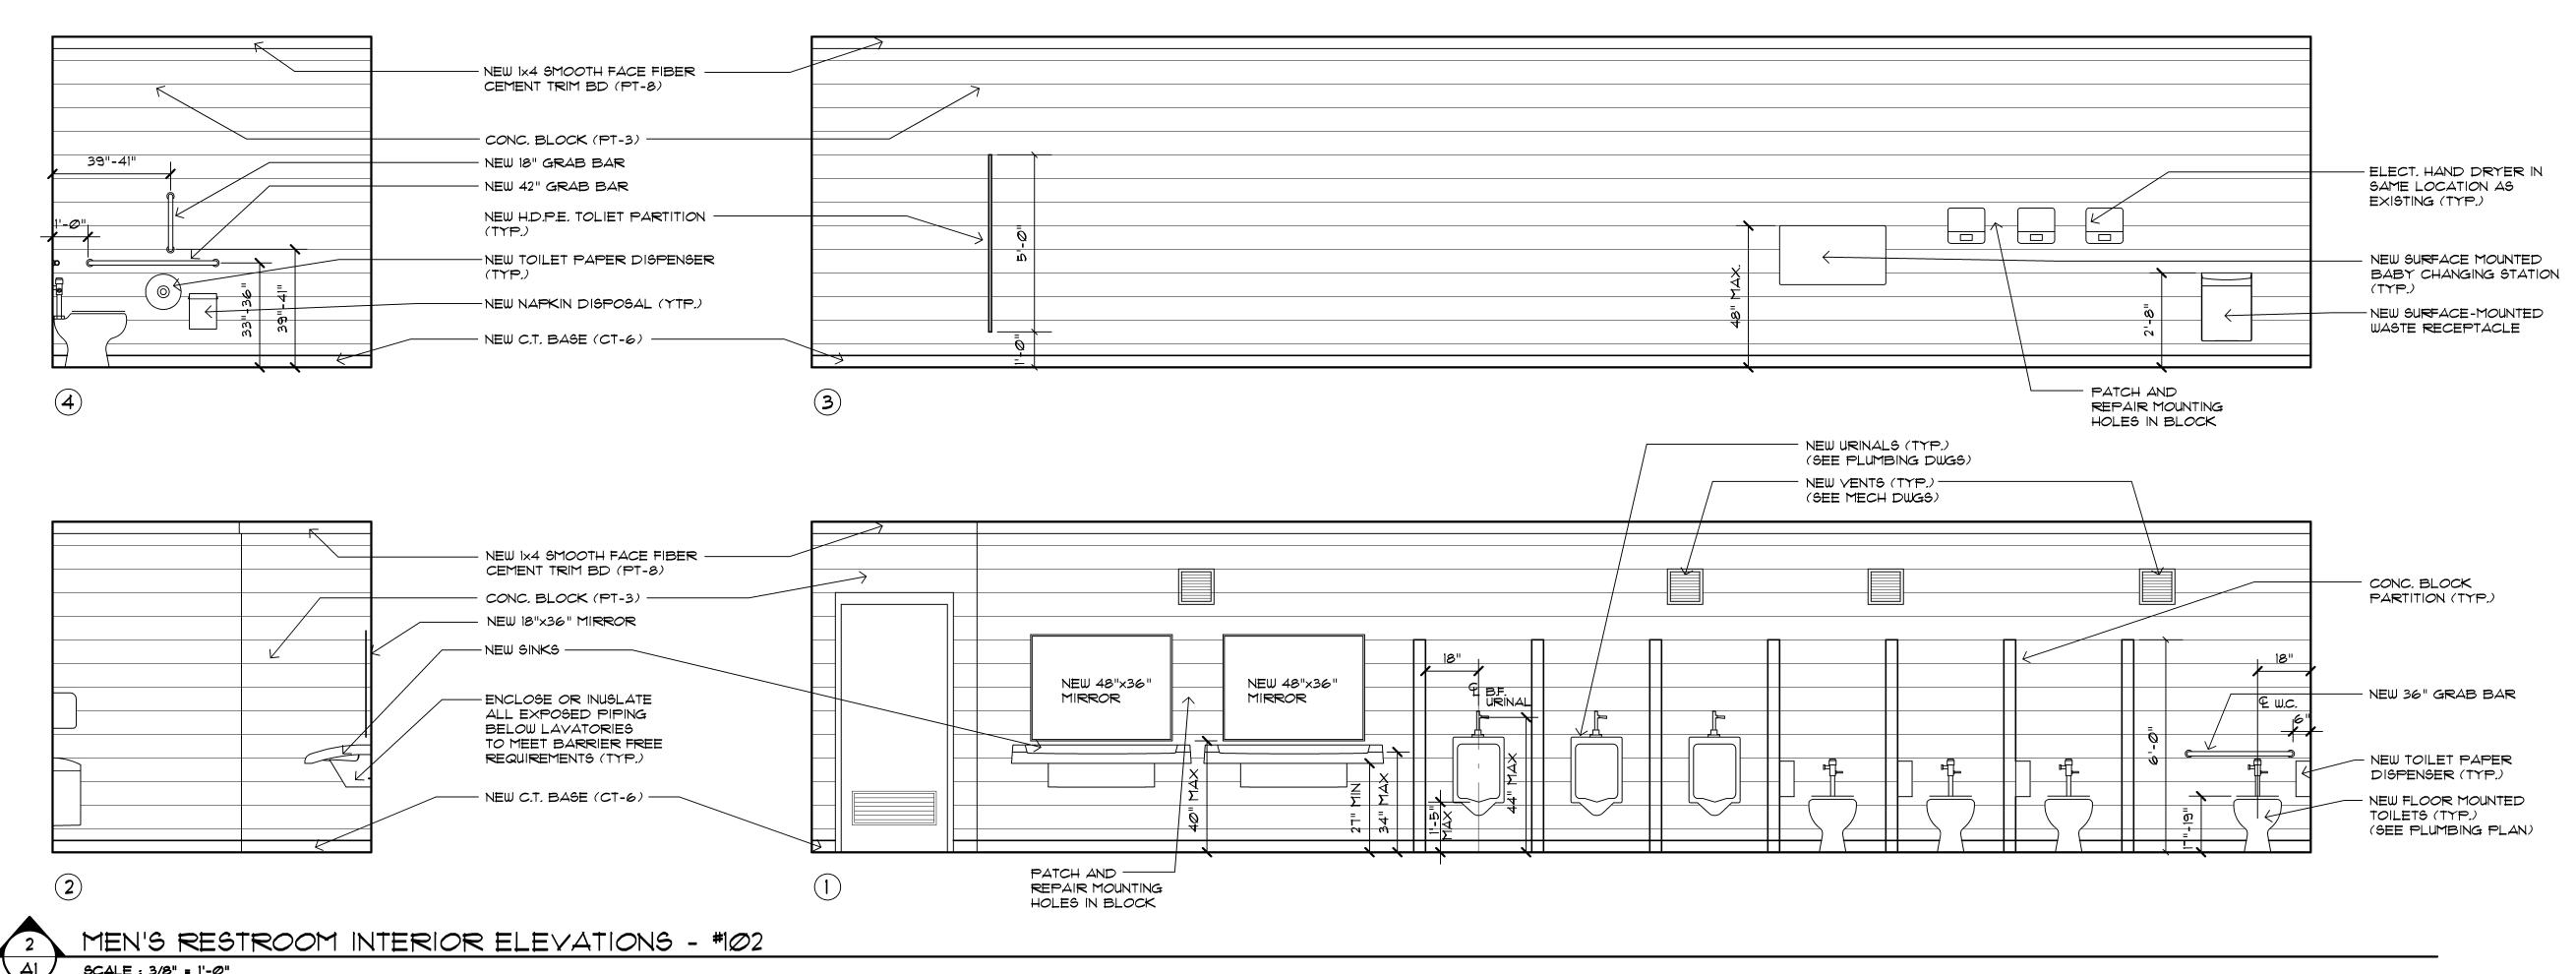
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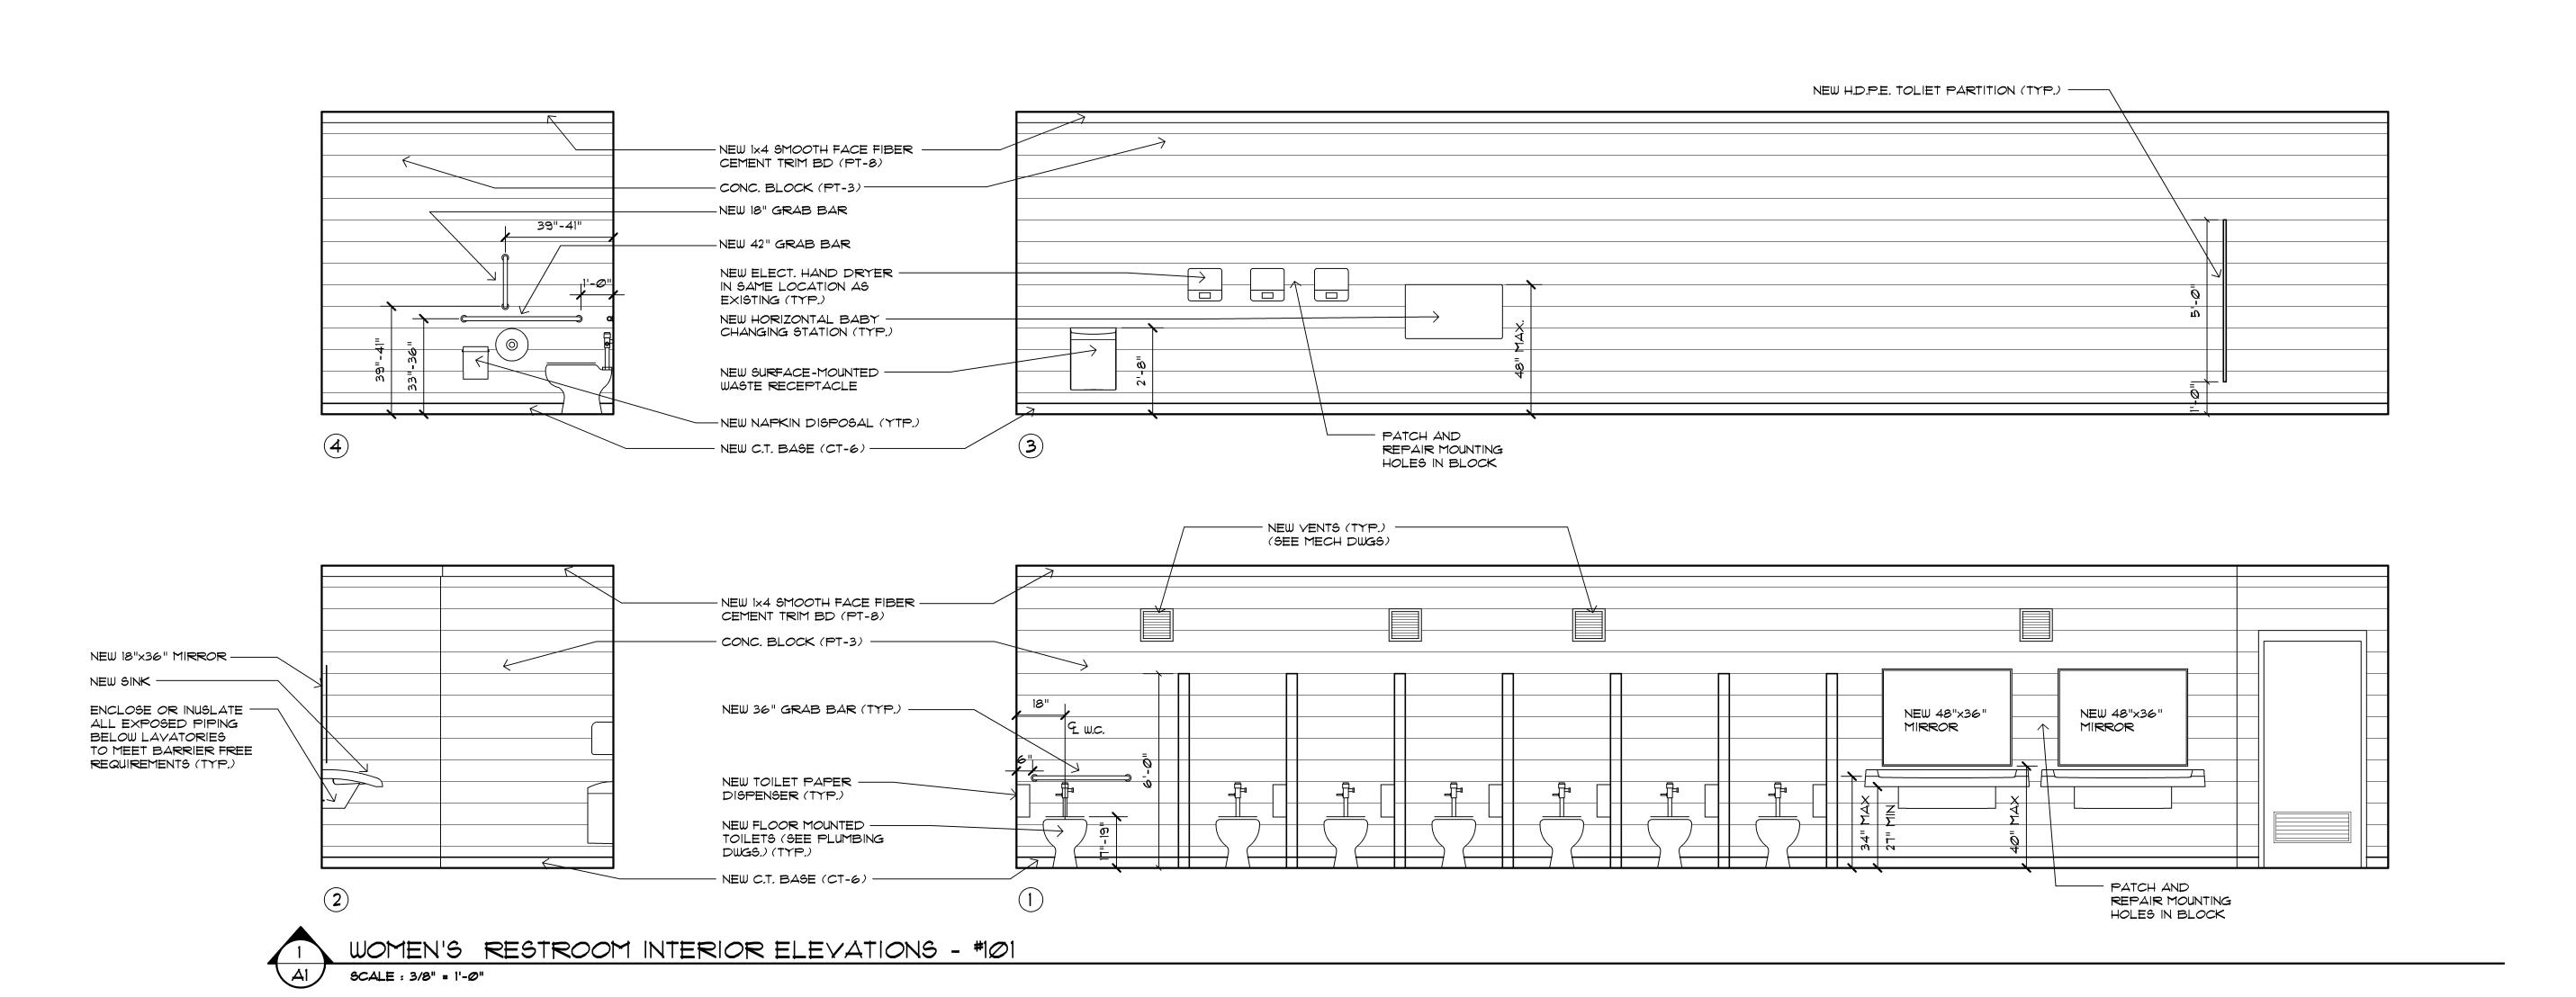
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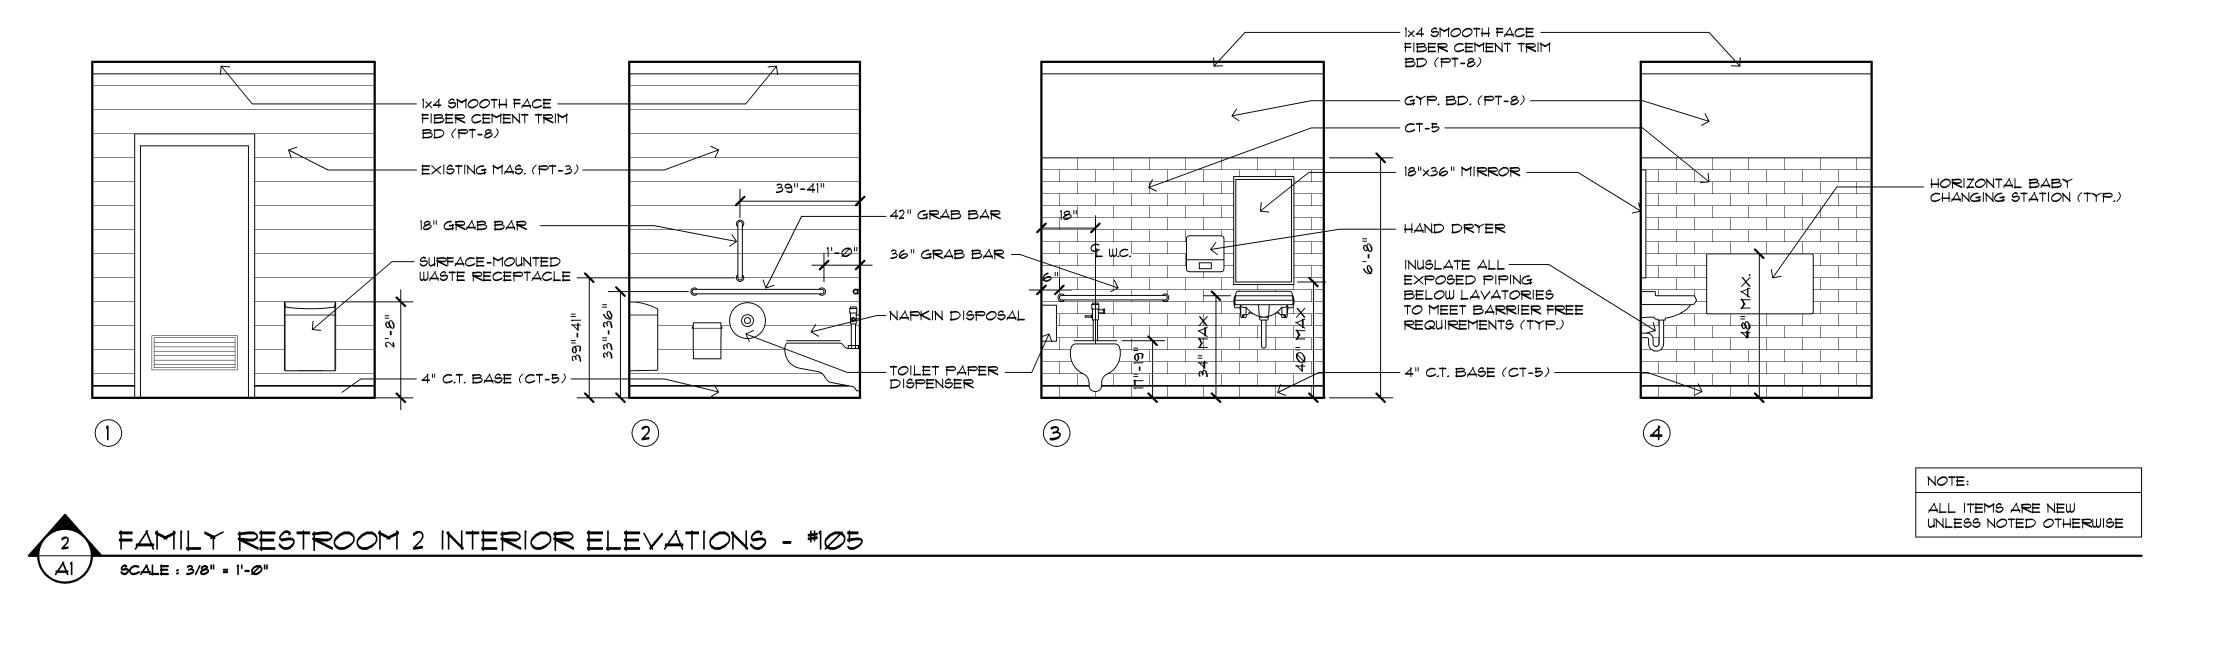
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— GYP. BD. (PT-8)

- 42" GRAB BAR

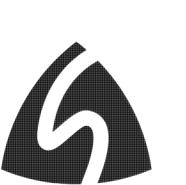36" GRAB BAR -

-NAPKIN DISPOSAL

— TOILET PAPER — DISPENSER

3

39"-41"

- 1x4 SMOOTH FACE

- 18"x36" MIRROR —

INUSLATE ALL EXPOSED PIPING BELOW LAVATORIES

– 4" C.T. BASE (CT-5) —

TO MEET BARRIER FREE REQUIREMENTS (TYP.)

4

- HAND DRYER

FIBER CEMENT TRIM BD (PT-8)

EXISTING MAS. (PT-3) -

— 1x4 9MOOTH FACE — FIBER CEMENT TRIM BD (PT-8)

- EXISTING MAS. (PT-3)

- SURFACE-MOUNTED WASTE RECEPTACLE -

18" GRAB BAR —


FAMILY RESTROOM | INTERIOR ELEVATIONS - #104

SCALE : 3/8" = 1'-0"

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project sheet title

- HORIZONTAL BABY CHANGING STATION (TYP.)


ALL ITEMS ARE NEW UNLESS NOTED OTHERWISE

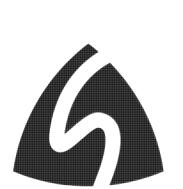NOTE:

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sheet no. 16078A RRB-A7



RESTROOMS & UTILIT | MECHANICAL DEMOLITION PLAN
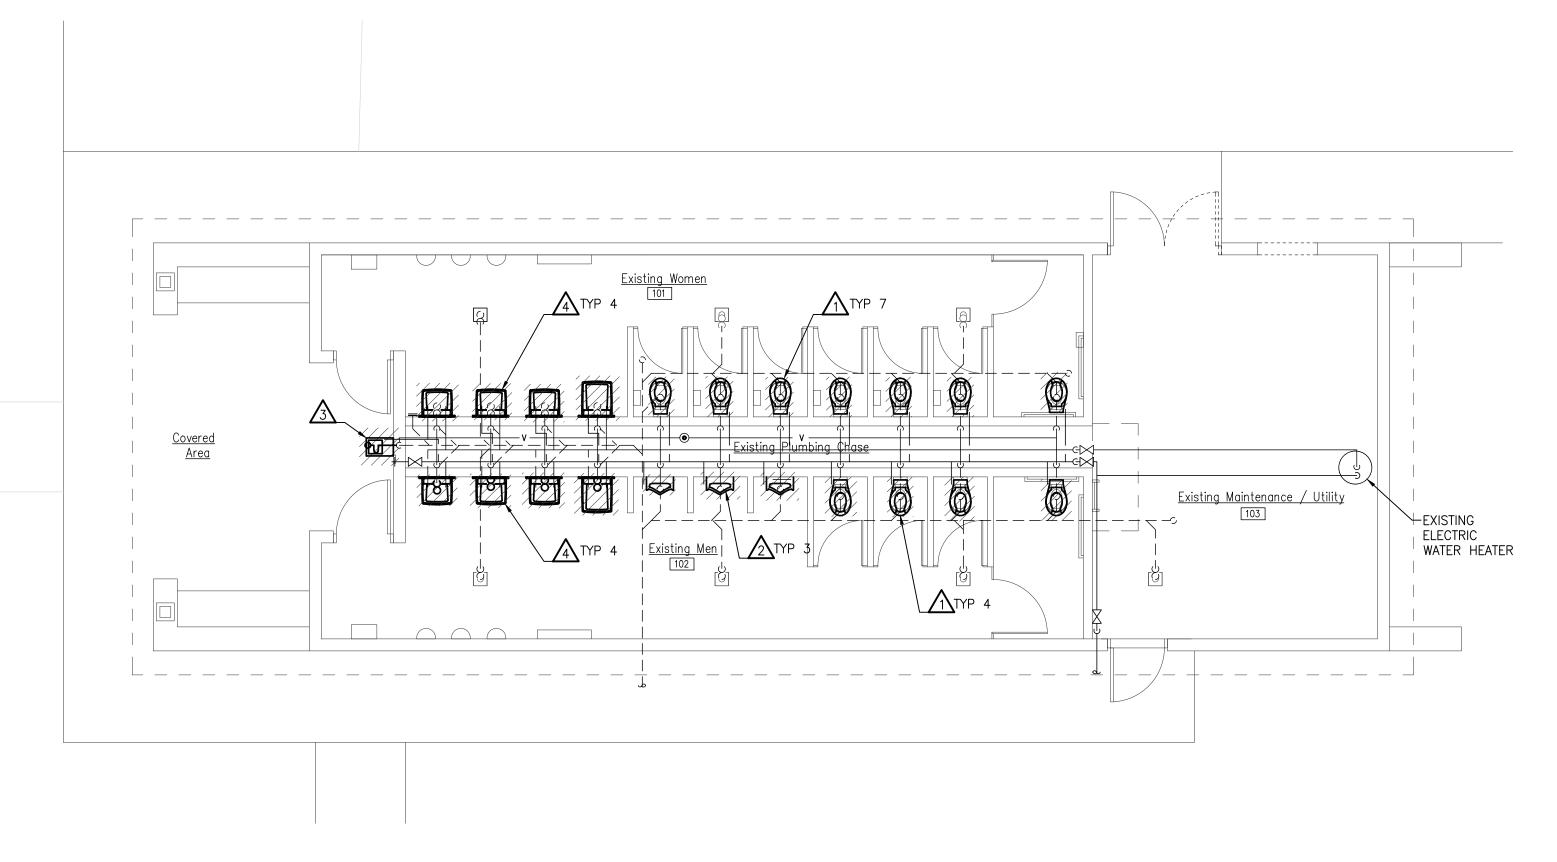
# GENERAL DEMOLITION NOTES

- ANY INTERRUPTIONS OF EXISTING SERVICES AND/OR EQUIPMENT SHALL BE PERFORMED AT A TIME APPROVED IN ADVANCE BY THE OWNER'S REPRESENTATIVE SO AS NOT TO INTERFERE WITH THE PRESENT BUILDING'S OPERATION.
- 2. THESE DRAWINGS ARE DIAGRAMMATIC AND INDICATE THE GENERAL EXTENT OF WORK TO BE PERFORMED. THE EXACT EXTENT OF DEMOLITION SHALL BE AS REQUIRED BY THE NEW WORK.
- 3. ALL MECHANICAL ITEMS TO BE REMOVED SHALL BE REMOVED COMPLETE WITH ALL RELATED ITEMS INCLUDING HANGERS, SUPPORTS, CONTROLS, ETC. CAP ALL OPEN ENDED PIPES AND DUCTWORK.
- 4. ALL DEMOLITION OF THE EXISTING MECHANICAL SYSTEMS, INCLUDING BUT NOT LIMITED TO PIPING, DUCTWORK, CONTROLS, SUPPORTS, HANGERS, AND EQUIPMENT SHALL BE UNDER SCOPE OF DIVISION 20 THRU 23 OF THE SPECIFICATIONS.
- 5. THE OWNER SHALL HAVE FIRST RIGHT OF REFUSAL ON ALL EQUIPMENT BEING REMOVED.

# DEMOLITION DEDEM NOTES

REMOVE EXISTING FLOOR MOUNTED WATER CLOSET, ASSOCIATED FLUSH VALVE AND ACCESSORIES COMPLETE. PREPARE FOR NEW CONNECTION.

REMOVE EXISTING WALL MOUNTED URINAL, ASSOCIATED FLUSH VALVE AND ACCESSORIES COMPLETE. PREPARE FOR NEW CONNECTION.

REMOVE EXISTING DRINKING FOUNTAIN, PLUMBING PIPING AND ACCESSORIES COMPLETE. PATCH EXTERIOR WALL TO MATCH EXISTING.

REMOVE EXISTING WALL MOUNTED SINK AND ACCESSORIES COMPLETE. PREPARE PIPING FOR NEW CONNECTION.

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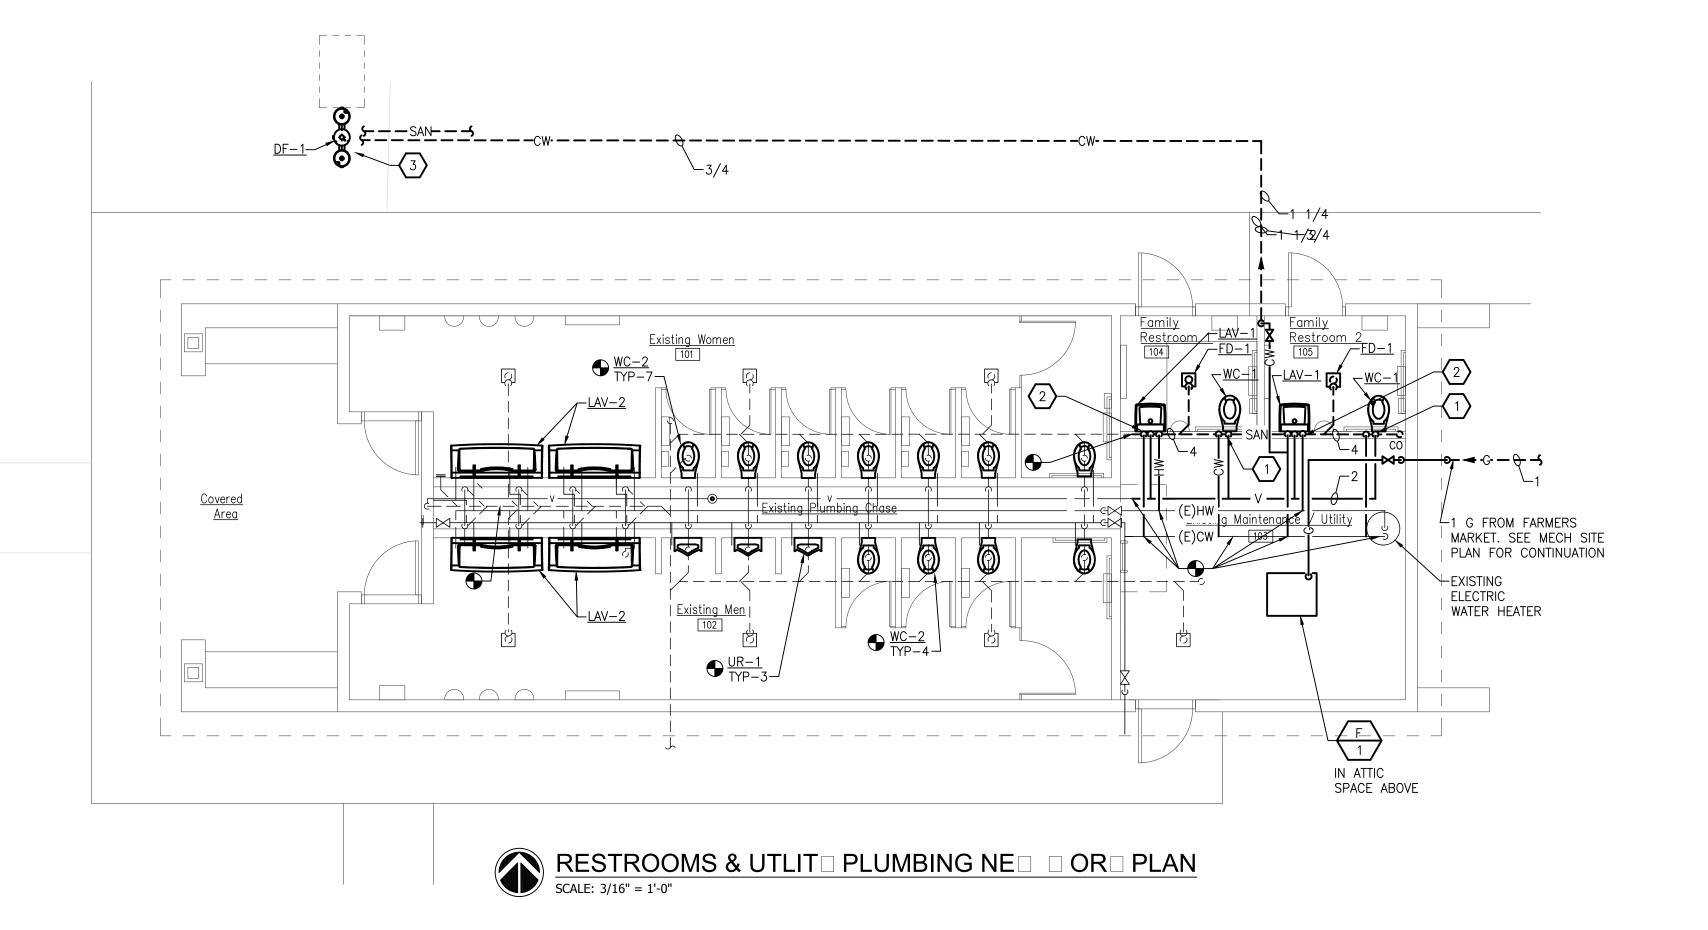
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	PLUMBING FIXTURE SCHEDULE														
TAG	BARRIER FREE	ITEM	PIF WASTE	PE CONNE	CTION SIZ	ES HW	MANUFACTURER & MODEL NO.	ACCESSORIES							
FD-1	_	FLOOR DRAIN	FLOOR DRAIN 3" 1 1/2" - ZURN: Z-415-B												
LAV-1	Y	WALL MOUNTED LAVATORY	1 1/2"	1 1/2"	1/2"	1/2"	AMERICAN STANDARD: LUCERNE	FAUCET: AMERICAN STANDARD: RELIANT 3. DECK MOUNTED SOAP DISPENSER: AMERICAN STANDARD MODEL # 4503.115. PROVIDE ASSE 1070 MIXING VALVE.							
LAV-2	Y	WALL MOUNTED TROUGH LAVATORY	1 1/2"	1 1/2"	1/2"	1/2"	BRADLEY: VERGE WASH BASIN: LVGD2								
DF-1	-	BI-LEVEL DRINKING FOUNTAIN WITH BOTTLE FILLER AND PET BOWL	2"	1 1/2"	1/2"	_	MOST DEPENDABLE: MODEL # 10145 SM, COLOR BLUE	ATTACHED HOSE BIBB. PROVIDE PET BOWL ADDITION							
UR-1	Y	WALL MOUNTED URINAL	2"	1 1/2"	3/4"	_	KOHLER: DEXTER. MODEL: K-5016-ET	FLUSH VALVE: KOHLER K-13521, 1.0 GPF							
WC-1	Y	WALL MOUNTED WATER CLOSET	4"	2"	1"	_	KOHLER: KINGSTON. MODEL: K-4325	FLUSH VALVE: KOHLER K-13516, 1.6 GPF							
WC-2	Y	FLOOR MOUNTED WATER CLOSET	4"	2"	1"	_	KOHLER: WELLWORTH. MODEL: K-4406	FLUSH VALVE: KOHLER K-13517C, 1.28 GPF							

# NOTES:

- 1. SUPPLY ALL FIXTURES WITH LOOSE KEY STOPS.
- 2. PROVIDE ALL ACCESSORIES NECESSARY FOR COMPLETE AND OPERABLE INSTALLATION.
- 3. PROVIDE CARRIERS FOR ALL FIXTURES PER MANUFACTURER'S RECOMMENDATIONS.
- 4. WHERE REQUIRED AND WHERE DESIGNATED, FIXTURES SHALL BE FURNISHED AND INSTALLED IN ACCORDANCE TO THE LATEST EDITION OF "THE BARRIER" FREE DESIGN REQUIREMENTS OF THE STATES CONSTRUCTION CODE.
- 5. REFER TO ARCHITECTURAL ELEVATIONS FOR EXACT LOCATION/MOUNTING HEIGHT OF ALL FIXTURES.



### MECHANICAL GENERAL NOTES

- 1. THESE DRAWINGS ARE DIAGRAMMATIC & INDICATE THE GENERAL EXTENT OF THE WORK. PROVIDE PLUMBING AND HVAC SYSTEMS COMPLETE PER SPECIFICATION, SMACNA STANDARDS, AND PER APPLICABLE CODES INCLUDING ALL NECESSARY OFFSETS, FITTINGS, SPECIAL RADIUS OR MITERED ELBOWS WHICH ARE REQUIRED DUE TO SPACE CONSTRAINTS OR OTHER STRUCTURAL CONDITIONS.
- 2. CONTRACTOR SHALL COORDINATE HIS WORK WITH THE WORK OF ALL OTHER TRADES. VERIFY ALL CLEARANCES PRIOR TO THE FABRICATION OF ANY WORK.
- 3. DUCTWORK/PIPING SHALL NOT BE LOCATED OVER ELECTRICAL EQUIPMENT/PANELS. PROVIDE REQUIRED CLEARANCE IN FRONT OF ELECTRICAL EQUIPMENT. DUCTWORK/PIPING SHALL NOT INTERFERE WITH ELECTRICAL EQUIPMENT CLEARANCE.
- 4. THE CONTRACTOR SHALL PROVIDE ALL MISCELLANEOUS SUPPORTING STEEL, ETC. FOR THE PROPER INSTALLATION OF ALL MECHANICAL SYSTEMS.
- 5. COORDINATE FLOOR, WALL, ROOF PENETRATIONS, LOUVER SIZES, PAD LOCATIONS ETC. WITH ARCHITECTURAL TRADES.
- 6. REFER TO ARCHITECTURAL REFLECTED CEILING PLANS FOR EXACT LOCATION OF GRILLES, REGISTERS, AND DIFFUSERS.
- 7. PIPING/DUCTWORK SHALL NOT BE LOCATED OVER ELECTRICAL EQUIPMENT/ PANELS. PROVIDE REQUIRED CLEARANCE IN FRONT/ABOVE OF ELECTRICAL EQUIPMENT. PIPING SHALL NOT INTERFERE WITH ELECTRICAL EQUIPMENT CLEARANCE.
- 8. PROVIDE CODE REQUIRED CLEARANCE/ACCESS DOORS FOR DAMPERS, VALVES. REFER TO ARCHITECTURAL PLANS FOR CEILING TYPES.
- 9. FOR EQUIPMENT VALVING, COMPONENT, AND PIPING ARRANGEMENT, REFER TO PIPING DIAGRAMS AND DETAILS.
- 10. BRANCH DUCTWORK TO GRILLES, REGISTERS AND DIFFUSERS SHALL BE THE SAME SIZE AS THE GRILLE, REGISTER OR DIFFUSER NECK SIZE WHERE NO DUCT SIZE IS INDICATED ON PLAN.
- 11. MAXIMUM LENGTH OF FLEXIBLE DUCT SHALL BE 5'-0".

# □E□ED NOTES

- 1) ROUTE 4" SANITARY, 2" VENT AND 1" CW DOWN TO WATER CLOSET.
- 2 ROUTE 1/2" SANITARY, 1 1/4" VENT, 1/2" HOT WATER DOWN TO LAVATORY.
- ROUTE 3" SANITARY AND 1/2" COLD WATER DOWN TO DRINKING FOUNTAIN.



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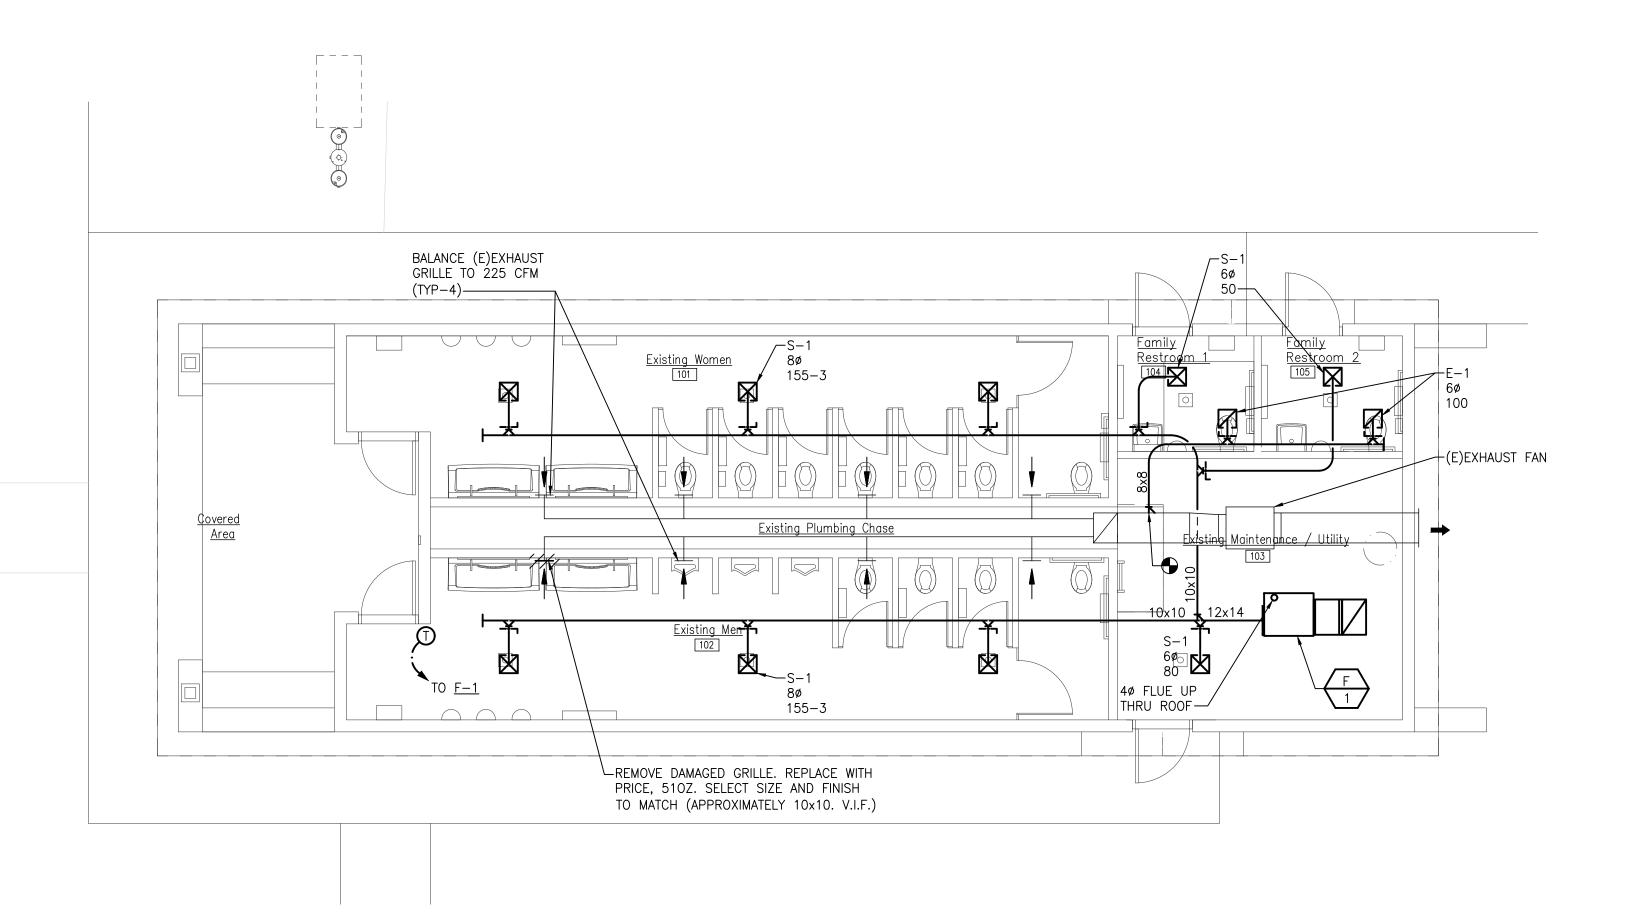


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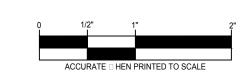
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	FURNACE SCHEDULE														
UNIT ID	UNIT ID SERVICE SUPPLY CFM OA CFM ESP BLOWER TAG INPUT (MBH) OUTPUT (MBH) OUTPUT (MBH) FF AFUE UNIT AMPACITY FUSE SIZE (AMPS) VOLTS PHASE MODEL NO. REMARKS											REMARKS			
F-1	CONCESSIONS & RESTROOMS	1,100	150	0.25	1/5	66	54	80%	3.1	15	120	1	ML180U H070	ML180UH070	

NOTES:







### MECHANICAL GENERAL NOTES

- 1. THESE DRAWINGS ARE DIAGRAMMATIC & INDICATE THE GENERAL EXTENT OF THE WORK. PROVIDE PLUMBING AND HVAC SYSTEMS COMPLETE PER SPECIFICATION, SMACNA STANDARDS, AND PER APPLICABLE CODES INCLUDING ALL NECESSARY OFFSETS, FITTINGS, SPECIAL RADIUS OR MITERED ELBOWS WHICH ARE REQUIRED DUE TO SPACE CONSTRAINTS OR OTHER STRUCTURAL CONDITIONS.
- 2. CONTRACTOR SHALL COORDINATE HIS WORK WITH THE WORK OF ALL OTHER TRADES. VERIFY ALL CLEARANCES PRIOR TO THE FABRICATION OF ANY WORK.
- 3. DUCTWORK/PIPING SHALL NOT BE LOCATED OVER ELECTRICAL EQUIPMENT/PANELS. PROVIDE REQUIRED CLEARANCE IN FRONT OF ELECTRICAL EQUIPMENT. DUCTWORK/PIPING SHALL NOT INTERFERE WITH ELECTRICAL EQUIPMENT CLEARANCE.
- 4. THE CONTRACTOR SHALL PROVIDE ALL MISCELLANEOUS SUPPORTING STEEL, ETC. FOR THE PROPER INSTALLATION OF ALL MECHANICAL SYSTEMS.
- 5. COORDINATE FLOOR, WALL, ROOF PENETRATIONS, LOUVER SIZES, PAD LOCATIONS ETC. WITH ARCHITECTURAL TRADES.
- 6. REFER TO ARCHITECTURAL PLANS FOR SPECIFICATIONS AND EXACT LOCATIONS OF FIXTURES (STANDARD AND BARRIER FREE), SINKS, ETC. REFER TO FOOD SERVICE PLANS FOR SPECIFICATIONS AND EXACT LOCATIONS OF FOOD SERVICE EQUIPMENT. REFER TO PLUMBING FIXTURE SCHEDULE FOR CONNECTION SIZES, ACCESSORIES, AND ADDITIONAL INFORMATION.
- 7. REFER TO ARCHITECTURAL REFLECTED CEILING PLANS FOR EXACT LOCATION OF GRILLES, REGISTERS, AND DIFFUSERS.
- 8. PIPING/DUCTWORK SHALL NOT BE LOCATED OVER ELECTRICAL EQUIPMENT/ PANELS. PROVIDE REQUIRED CLEARANCE IN FRONT/ABOVE OF ELECTRICAL EQUIPMENT. PIPING SHALL NOT INTERFERE WITH ELECTRICAL EQUIPMENT CLEARANCE.
- 9. PIPING SHALL NOT BE INSTALLED IN A LOCATION THAT RESTRICTS THE ACCESS TO MECHANICAL DEVICES REQUIRING ACCESS.
- 10. HOT AND COLD WATER PIPING RUN-OUTS TO LAVS AND SINKS SHALL BE 3/4" UNLESS NOTED OTHERWISE. REFER TO PLUMBING FIXTURE SCHEDULE FOR CONNECTION SIZES. PROVIDE BRANCH LINE ISOLATION VALVES ON DOMESTIC PIPING TO EACH GROUP OF FIXTURES AND TOILET ROOMS. PROVIDE FULL OPEN VALVES PER PLUMBING CODE.
- 11. HOT AND COLD WATER PIPING RUN-OUTS TO LAVS AND SINKS SHALL BE 3/4" UNLESS NOTED OTHERWISE. REFER TO SPECIFICATIONS FOR FIXTURE CONNECTION SIZES.
- 12. PROVIDE CODE REQUIRED CLEARANCE/ACCESS DOORS FOR DAMPERS, VALVES, AND CLEANOUTS LOCATED IN WALLS OR ABOVE HARD CEILINGS, AND LOCATIONS OF CLEANOUTS INSTALLED IN STORM AND SANITARY PIPING. COORDINATE LOCATIONS WITH ARCHITECT. PROVIDE CLEANOUTS AT THE BASE OF ALL STACKS. REFER TO ARCHITECTURAL PLANS FOR CEILING TYPES.
- 13. FOR EQUIPMENT VALVING, COMPONENT, AND PIPING ARRANGEMENT, REFER TO PIPING DIAGRAMS AND DETAILS.
- 14. BRANCH DUCTWORK TO GRILLES, REGISTERS AND DIFFUSERS SHALL BE THE SAME SIZE AS THE GRILLE, REGISTER OR DIFFUSER NECK SIZE WHERE NO DUCT SIZE IS INDICATED ON PLAN.
- 15. MAXIMUM LENGTH OF FLEXIBLE DUCT SHALL BE 5'-0".

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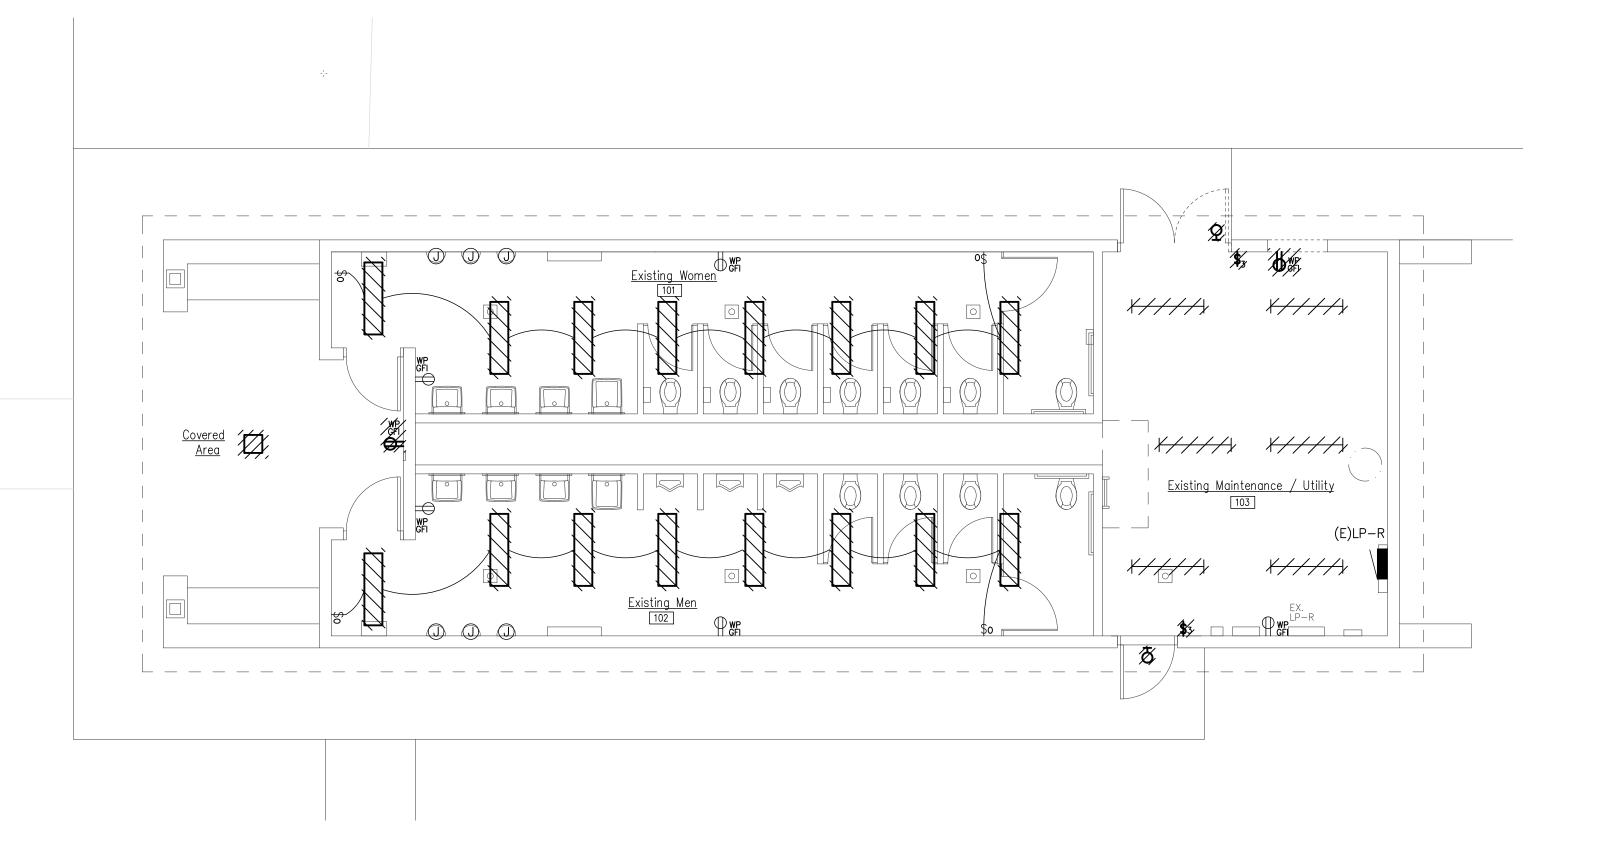


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<sup>1.</sup> MODEL NUMBERS ARE LENNOX UNLESS OTHERWISE NOTED.





# GENERAL DEMOLITION NOTES

- 2. EXAMINE THE DRAWINGS OF OTHER TRADES, BE FAMILIAR WITH THE DEMOLITION REQUIRED BY OTHER TRADES. PERFORM ALL INCIDENTAL ELECTRICAL DEMOLITION AND/OR RELOCATION OF DEVICES AND EQUIPMENT REQUIRED TO FACILITATE THE DEMOLITION WORK OF OTHER TRADES.
- EXTENT OF DEMOLITION WORK.
- LONGER THAN THE ABOVE STATED HOURS.
- REPRESENTATIVE A MINIMUM OF 72 HOURS PRIOR TO SHUT DOWN.
- 8. WHERE DEMOLITION WORK AFFECTS ELECTRICAL SERVICE TO DOWNSTREAM DEVICES TO REMAIN; EXTEND CONDUIT AND WIRE AS REQUIRED TO MAINTAIN ELECTRICAL SERVICE.
- IN BID. ALL MATERIALS SHALL BE DISPOSED OF IN ACCORDANCE WITH ALL FEDERAL, STATE AND LOCAL REGULATIONS, INCLUDING TCLP TESTING, PRIOR TO DISPOSAL AND/OR RECYCLING OF FLUORESCENT LAMPS.
- AND WALL REMAINS INTACT. MARK ALL UNUSED CIRCUIT BREAKERS AS "SPARE".
- 11. CONTRACTOR TO TAG ALL CIRCUITS AT BOTH ENDS AFFECTED BY THIS ALTERATION.
- PANELS AFFECTED BY THIS ALTERATION.
- LOCATIONS PRIOR TO SAW CUTTING OR PENETRATING ANY FLOOR SLABS.
- DESIGNATIONS.



VISIT THE SITE PRIOR TO SUBMISSION OF BID TO EXAMINE THE EXISTING CONDITIONS AND THE EXTENT OF DEMOLITION WORK.

- 3. REMOVE LIGHTING FIXTURES AND ELECTRICAL DEVICES AS INDICATED ON PLAN. DEMOLITION SHALL INCLUDE, BUT NOT BE LIMITED TO THOSE DEVICES SHOWN.
- 4. COORDINATE WITH NEW WORK PLANS, ONE LINE AND RISER DIAGRAMS FOR
- 5. COORDINATE ANY SHUTDOWN OF EXISTING SERVICES AND EQUIPMENT REMAINING IN USE WITH OWNERS' REPRESENTATIVE. WHERE EXISTING BUILDING SERVICE IS REQUIRED TO BE SHUT DOWN, INCLUDE ALL ASSOCIATED OVERTIME COST TO PERFORM THIS WORK DURING EVENINGS AND WEEKENDS. INCLUDE ALL COSTS FOR PROVIDING TEMPORARY POWER WHERE SHUTDOWNS OCCUR FOR PERIODS
- 6. COORDINATE THE SHUT DOWN OF ELECTRICAL EQUIPMENT WITH THE OWNERS'
- 7. REMOVE ALL CONDUIT AND WIRE BACK TO NEAREST UPSTREAM DEVICE REMAINING IN SERVICE.
- 9. DISPOSE OF ALL MATERIALS OFF SITE AND INCLUDE ALL COSTS FOR DISPOSAL
- 10. PROVIDE BLANK COVER PLATES WHERE SWITCHES AND DEVICES ARE REMOVED
- 12. CONTRACTOR SHALL PROVIDE UPDATED, TYPED-IN DIRECTORIES FOR ALL
- 13. CONTRACTOR SHALL VERIFY ALL UNDERGROUND AND IN-SLAB UTILITIES
- 14. REFER TO NEW WORK SHEETS FOR LIGHTING AND POWER CIRCUIT
- 15. EXTEND EXISTING CONDUIT AND WIRE AS REQUIRED FOR ALL RELOCATED

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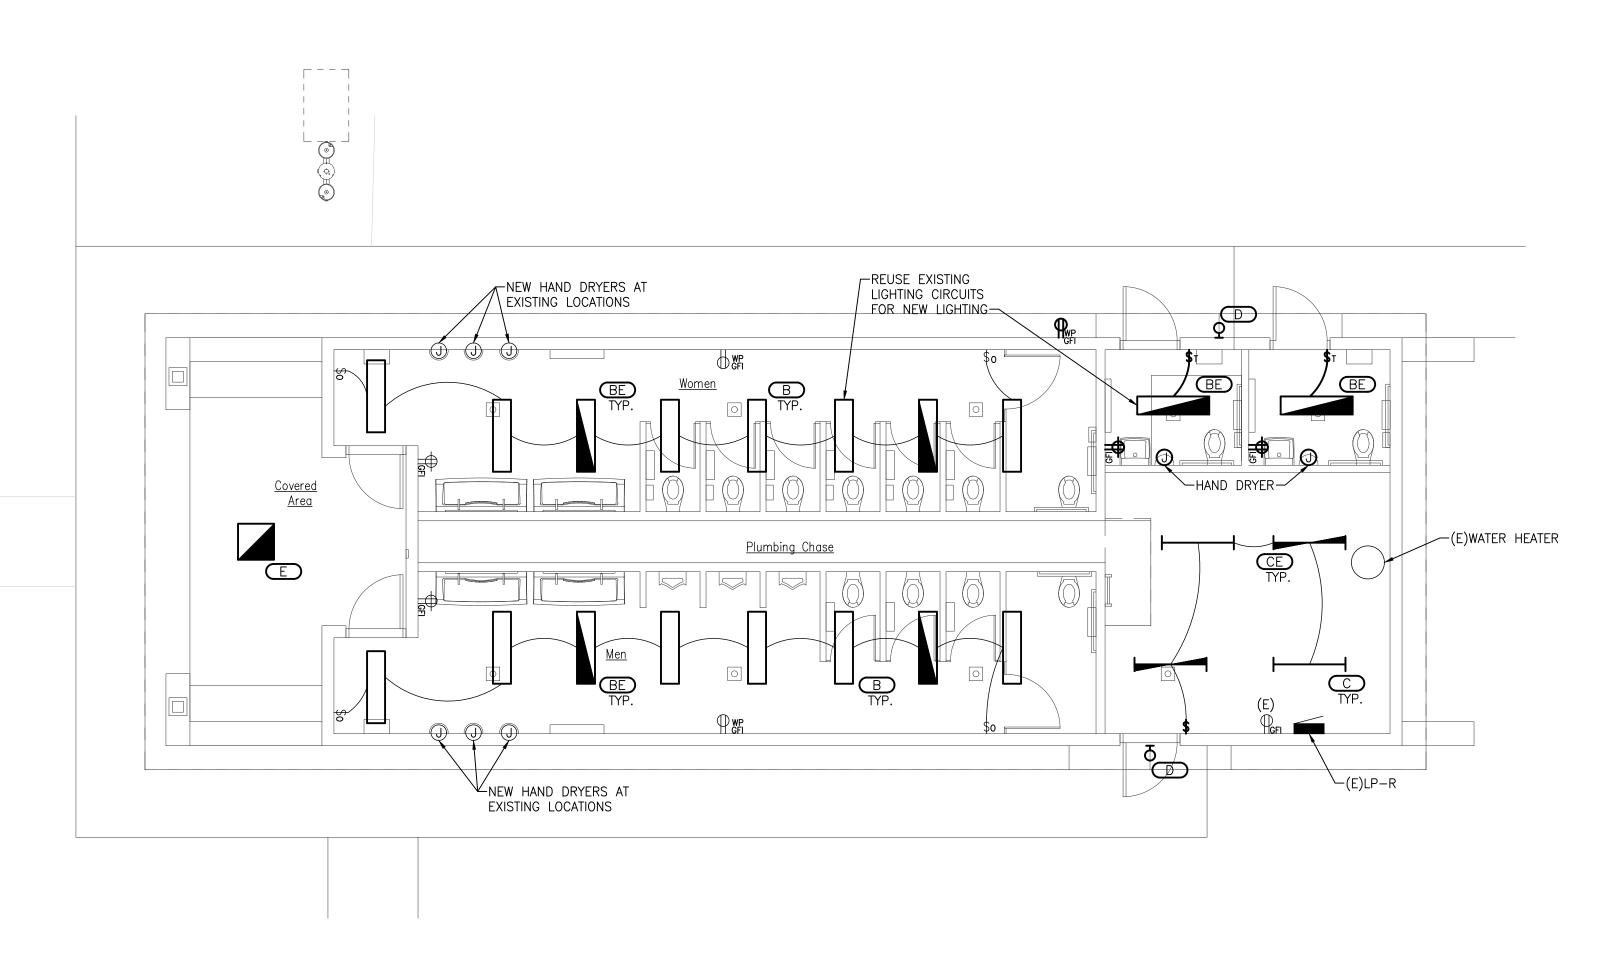
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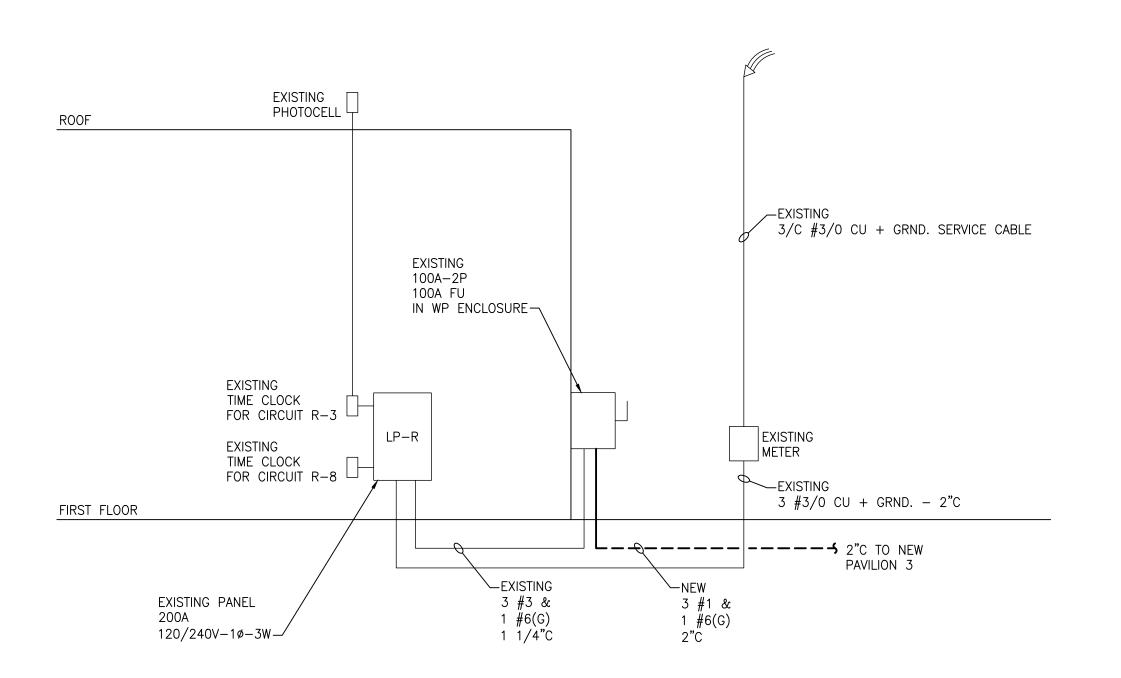
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# RESTROOMS & UTILIT | ELECTRICAL NE | OR | PLAN | SCALE:3/16" = 1'-0"



ELECTRIC ONE LINE DIAGRAM - RESTROOM BUILDING NO SCALE



# **ELECTRICAL GENERAL NOTES**

- 1. REFER TO ARCHITECTURAL REFLECTED CEILING PLAN FOR EXACT LOCATION OF ALL LIGHTING FIXTURES UNLESS OTHERWISE NOTED.
- 2. SEE LUMINAIRE SCHEDULE ON ELECTRICAL GENERAL INFORMATION SHEET.
- 3. EXIT LIGHTS AND EMERGENCY BATTERY UNITS SHALL BE UNCONTROLLED AND TIED AHEAD OF LOCAL AREA LIGHTING SWITCH, UNLESS CIRCUITED OTHERWISE.
- 4. WHERE MORE THEN ONE LIGHT SWITCH IS INDICATED TO BE INSTALLED AT THE SAME LOCATION, THEY SHALL BE GROUPED UNDER ONE COMMON FACEPLATE.
- 5. ALL ELECTRICAL DEVICES SHOWN ON THIS PLAN SHALL BE NEW UNLESS
- 6. ANY 120 VOLT BRANCH CIRCUIT FEEDER LONGER THAN 75'-0" TO LAST DEVICE SHALL BE SIZED TO THE NEXT LARGER STANDARD AWG SIZE. E.C. SHALL FIELD VERIFY ALL LENGTHS OF FEEDERS.
- 7. ALL RECEPTACLES SHALL BE 20A. RATED.

OTHERWISE NOTED.

- 8. ALL DISCONNECT SWITCHES SHALL BE HEAVY DUTY TYPE.
- 9. ALL RECEPTACLES WITHIN 6'-0" OF SINK OR OTHER WATER SUPPLY SHALL BE GFCI TYPE RECEPTACLE.
- 10. REFER TO ARCHITECTURAL FLOOR PLAN AND ELEVATIONS FOR EXACT LOCATION OF DEVICES.
- 11. ALL JUNCTION BOXES SERVING BRANCH CIRCUIT WIRING SHALL BE LABELED WITH CIRCUITS SERVED.
- 12. ALL 120 VOLT CIRCUITS SHALL UTILIZE A SEPARATE NEUTRAL.

A 4" CONCRETE HOUSE KEEPING PAD.

- 13. ALL CONDUITS SERVING 120 VOLTS OR GREATER SHALL INCLUDE A GROUND WIRE.
- 14. ALL CONDUITS SHALL BE ROUTED CONCEALED UNLESS NOTED OTHERWISE. 15. ALL ELECTRICAL EQUIPMENT MOUNTED ON THE FLOOR SHALL BE MOUNTED ON
- 16. ALL BRANCH CIRCUIT WIRING SHALL BE 2#12, 1#12GND IN 3/4" CONDUIT, UNLESS NOTED OTHERWISE.

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