



Macomb County, Michigan

Budd Park Universally Accessible Kayak Launch and Site Improvements

ΤO MA

THE IMPROVEMENTS COVERED BY THESE PLANS SHALL BE PERFORMED IN ACCORDANCE WITH THE MICHIGAN DEPARTMENT OF TRANSPORTATION 2020 STANDARD SPECIFICATIONS FOR CONSTRUCTION AND THE CITY OF EASTPOINTE STANDARD WATER MAIN SPECIFICATIONS UNLESS MODIFIED BY A SPECIAL PROVISION. ALL TRAFFIC CONTROL DEVICES SUCH AS LIGHTED ARROW BOARDS, PLASTIC DRUMS, BARRICADES, TEMPORARY SIGNAGE, AND LANE CLOSURES SHALL BE IMPLEMENTED IN ACCORDANCE WITH THE 2011 MICHIGAN MANUAL OF UNIFORM TRAFFIC CONTROL DEVICES AND THE SUPPLEMENTARY MAINTAINING TRAFFIC SPECIAL PROVISION.

PROJECT DESCRIPTION THE PROJECT CONSISTS OF THE INSTALLATION OF AN ACCESSIBLE KAYAK LAUNCH AND SITE IMPROVEMENTS SUCH AS CONCRETE SIDEWALK INSTALLATION, RECONDITIONING OF THE EXISTING GRAVEL SURFACE, ADDITIONAL PARKING AREA, AND MISCELLANEOUS ITEMS OF WORK.



WESTRICK, INC CIVIL ENGINEERS SURVEYORS ARCHITECTS

INDEX TO SHEETS


TITLE SHEET	1
TOPOGRAPHICAL SURVEY	
REMOVAL PLAN	3
CONSTRUCTION PLAN	4
GRADING PLAN	5
UNIVERSAL KAYAK LAUNCH AND OTHER SITE DETAILS	6
SOIL EROSION AND SEDIMENTATION CONTROL PLAN	7
SOIL EROSION CONTROL DETAILS AND NOTES	8
CLINTON TOWNSHIP STANDARD PAVING DETAIL SHEETS (2 PAGES)	
CLINTON TOWNSHIP STANDARD STORM SEWER DETAIL SHEETS (1 PAG	϶E)
MACOMB COUNTY DEPARTMENT OF ROADS DETAIL SHEETS (2 PAGES)	

DESIGN & CONSTRUCTION STANDARD

"I HEREBY CERTIFY THESE PLANS HAVE BEEN PREPARED UNDER MY DIRECT SUPERVISION IN ACCORDANCE WITH ACT 240, PUBLIC ACTS OF 1937 AS AMENDED- STATE OF MICHIGAN."

SCOTT J. CHABOT, P.E. No. 6201053119

DATE

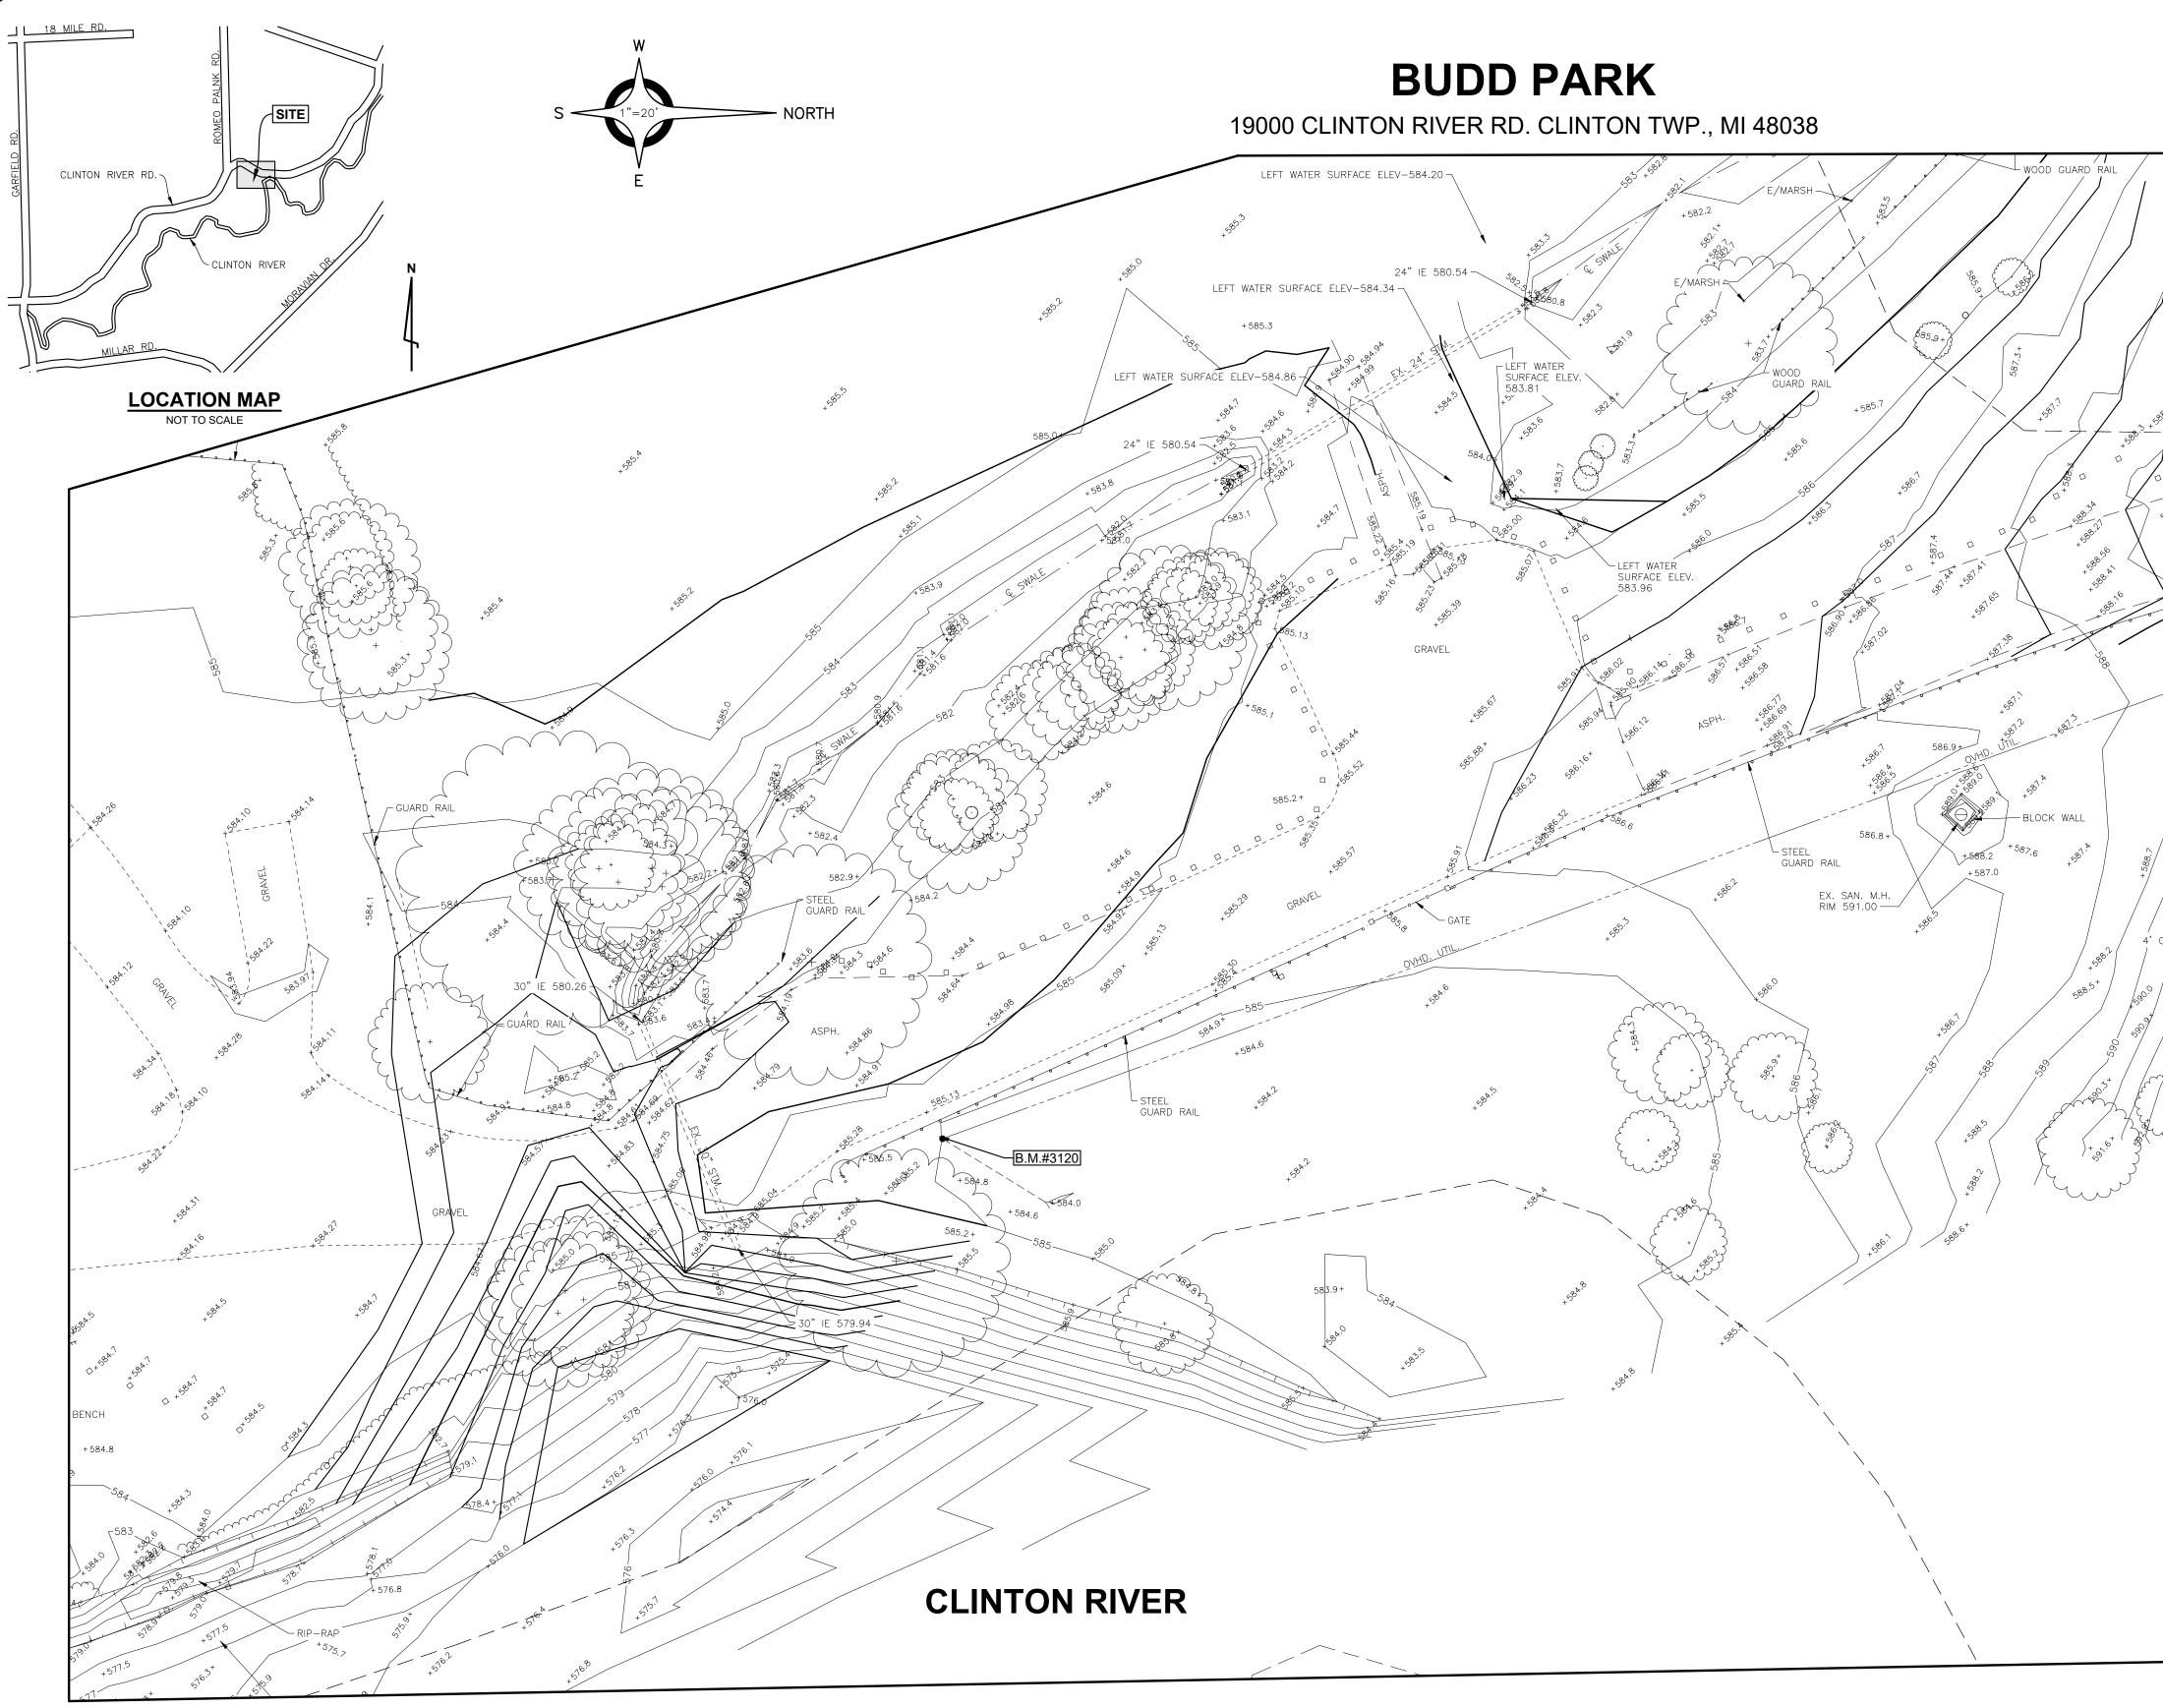


BENCH MARKS (NAVD88 DATUM)


BENCH MARK NO. 3119 MAG NAIL IN NORTH FACE OF WOOD POLE EAST QUAD. BUDD PARK ENTRANCE. ELEVATION: 598.06

BENCH MARK NO.3120 T/ NAIL WEST FACE OF WOOD POWER POLE EAST SIDE BUDD PARK DRIVE. ELEVATION: 586.26


BENCH MARK NO.3121 T/NAIL NORTHEAST FACE OF WOOD LIGHT POLE NORTH SIDE ISLAND OF BUDD PARK DRIVE CIRCLE. ELEVATION: 585.95

G:685+ CONC. CONC. x x x x x x x x x x x x x x x x x x x	Control of the second structure of the second structur
B.M.#3119 ASPH.		
Str Str <th></th> <th>10/30/2024 Additional Topographical Survey DATE SUBMITTALS/REVISIONS PROJECT NAME: CLINTON RIVER SUBDE SUBDITIALS/REVISIONS DUDD PARK SHEET TITLE:</th>		10/30/2024 Additional Topographical Survey DATE SUBMITTALS/REVISIONS PROJECT NAME: CLINTON RIVER SUBDE SUBDITIALS/REVISIONS DUDD PARK SHEET TITLE:
	LEGEND	SURVEY CLIENT: CHARTER TOWNSHIP OF CLINTON PRELIMINARY PRELIMINARY CONSTRUCTION PRELIMINARY CONSTRUCTION RECORD DRAWN BY: CHECKED BY: DATE: SAK SJC JANUARY 2025 SCALE: 1" = 20' 0 15 30 60 Know what's below. Call 72 hours before you dig.
x _p op ⁰	CENTERLINE SWALE SPOT ELEVATION ("+" INDICATES ELEVATION LOCATION UNLESS OTHERWISE INDICATED) SIGN SIGN DOUBLE GUY WIRE POWER POLE LIGHT POLE SANITARY MANHOLE STORM SEWER WATER FAUCET OVHD. UTIL. UTILITY MARKER	UTILITY INFORMATION, AS SHOWN, INDICATES APPROXIMATE LOCATIONS AND TYPES OF EXISTING FACILITIES ONLY, AS DISCLOSED BY RECORDS PROVIDED TO THIS FIRM FROM THE VARIOUS UTILITY COMPANIES. NO GUARANTEE IS GIVEN OR IMPLIED AS TO THE COMPLETENESS OR ACCURACY THEREOF. PRIOR TO CONSTRUCTION, ALL LOCATIONS AND DEPTHS OF EXISTING OVERHEAD AND UNDERGROUND UTILITIES (IN CONFLICT WITH THE CONSTRUCTION OF THESE PROPOSED IMPROVEMENTS) SHALL BE VERIFIED IN THE FIELD. DURING THE CONSTRUCTION, THE CONTRACTOR SHALL PROTECT AND SUPPORT ALL UTILITIES THAT ARE ENCOUNTERED. (ALL COSTS FOR UTILITY LOCATION VERIFICATION, SUPPORT AND PROTECTION SHALL BE INCLUDED IN THE PROPOSED PAY ITEM CONFLICTING WITH THAT UTILITY). DURING CONSTRUCTION, THE CONTRACTOR SHALL USE EXTREME CAUTION WHEN OPERATING NEAR ANY AND ALL OVERHEAD AND / OR BURIED UTILITIES. PROJECT NO. D242-0326 M:\0242\0242-0326\DWG\CIVIL\01_ENGPLANS.DWG 02_TOPO-5/9/2025 2:31:33 PM SHEET NO. D29

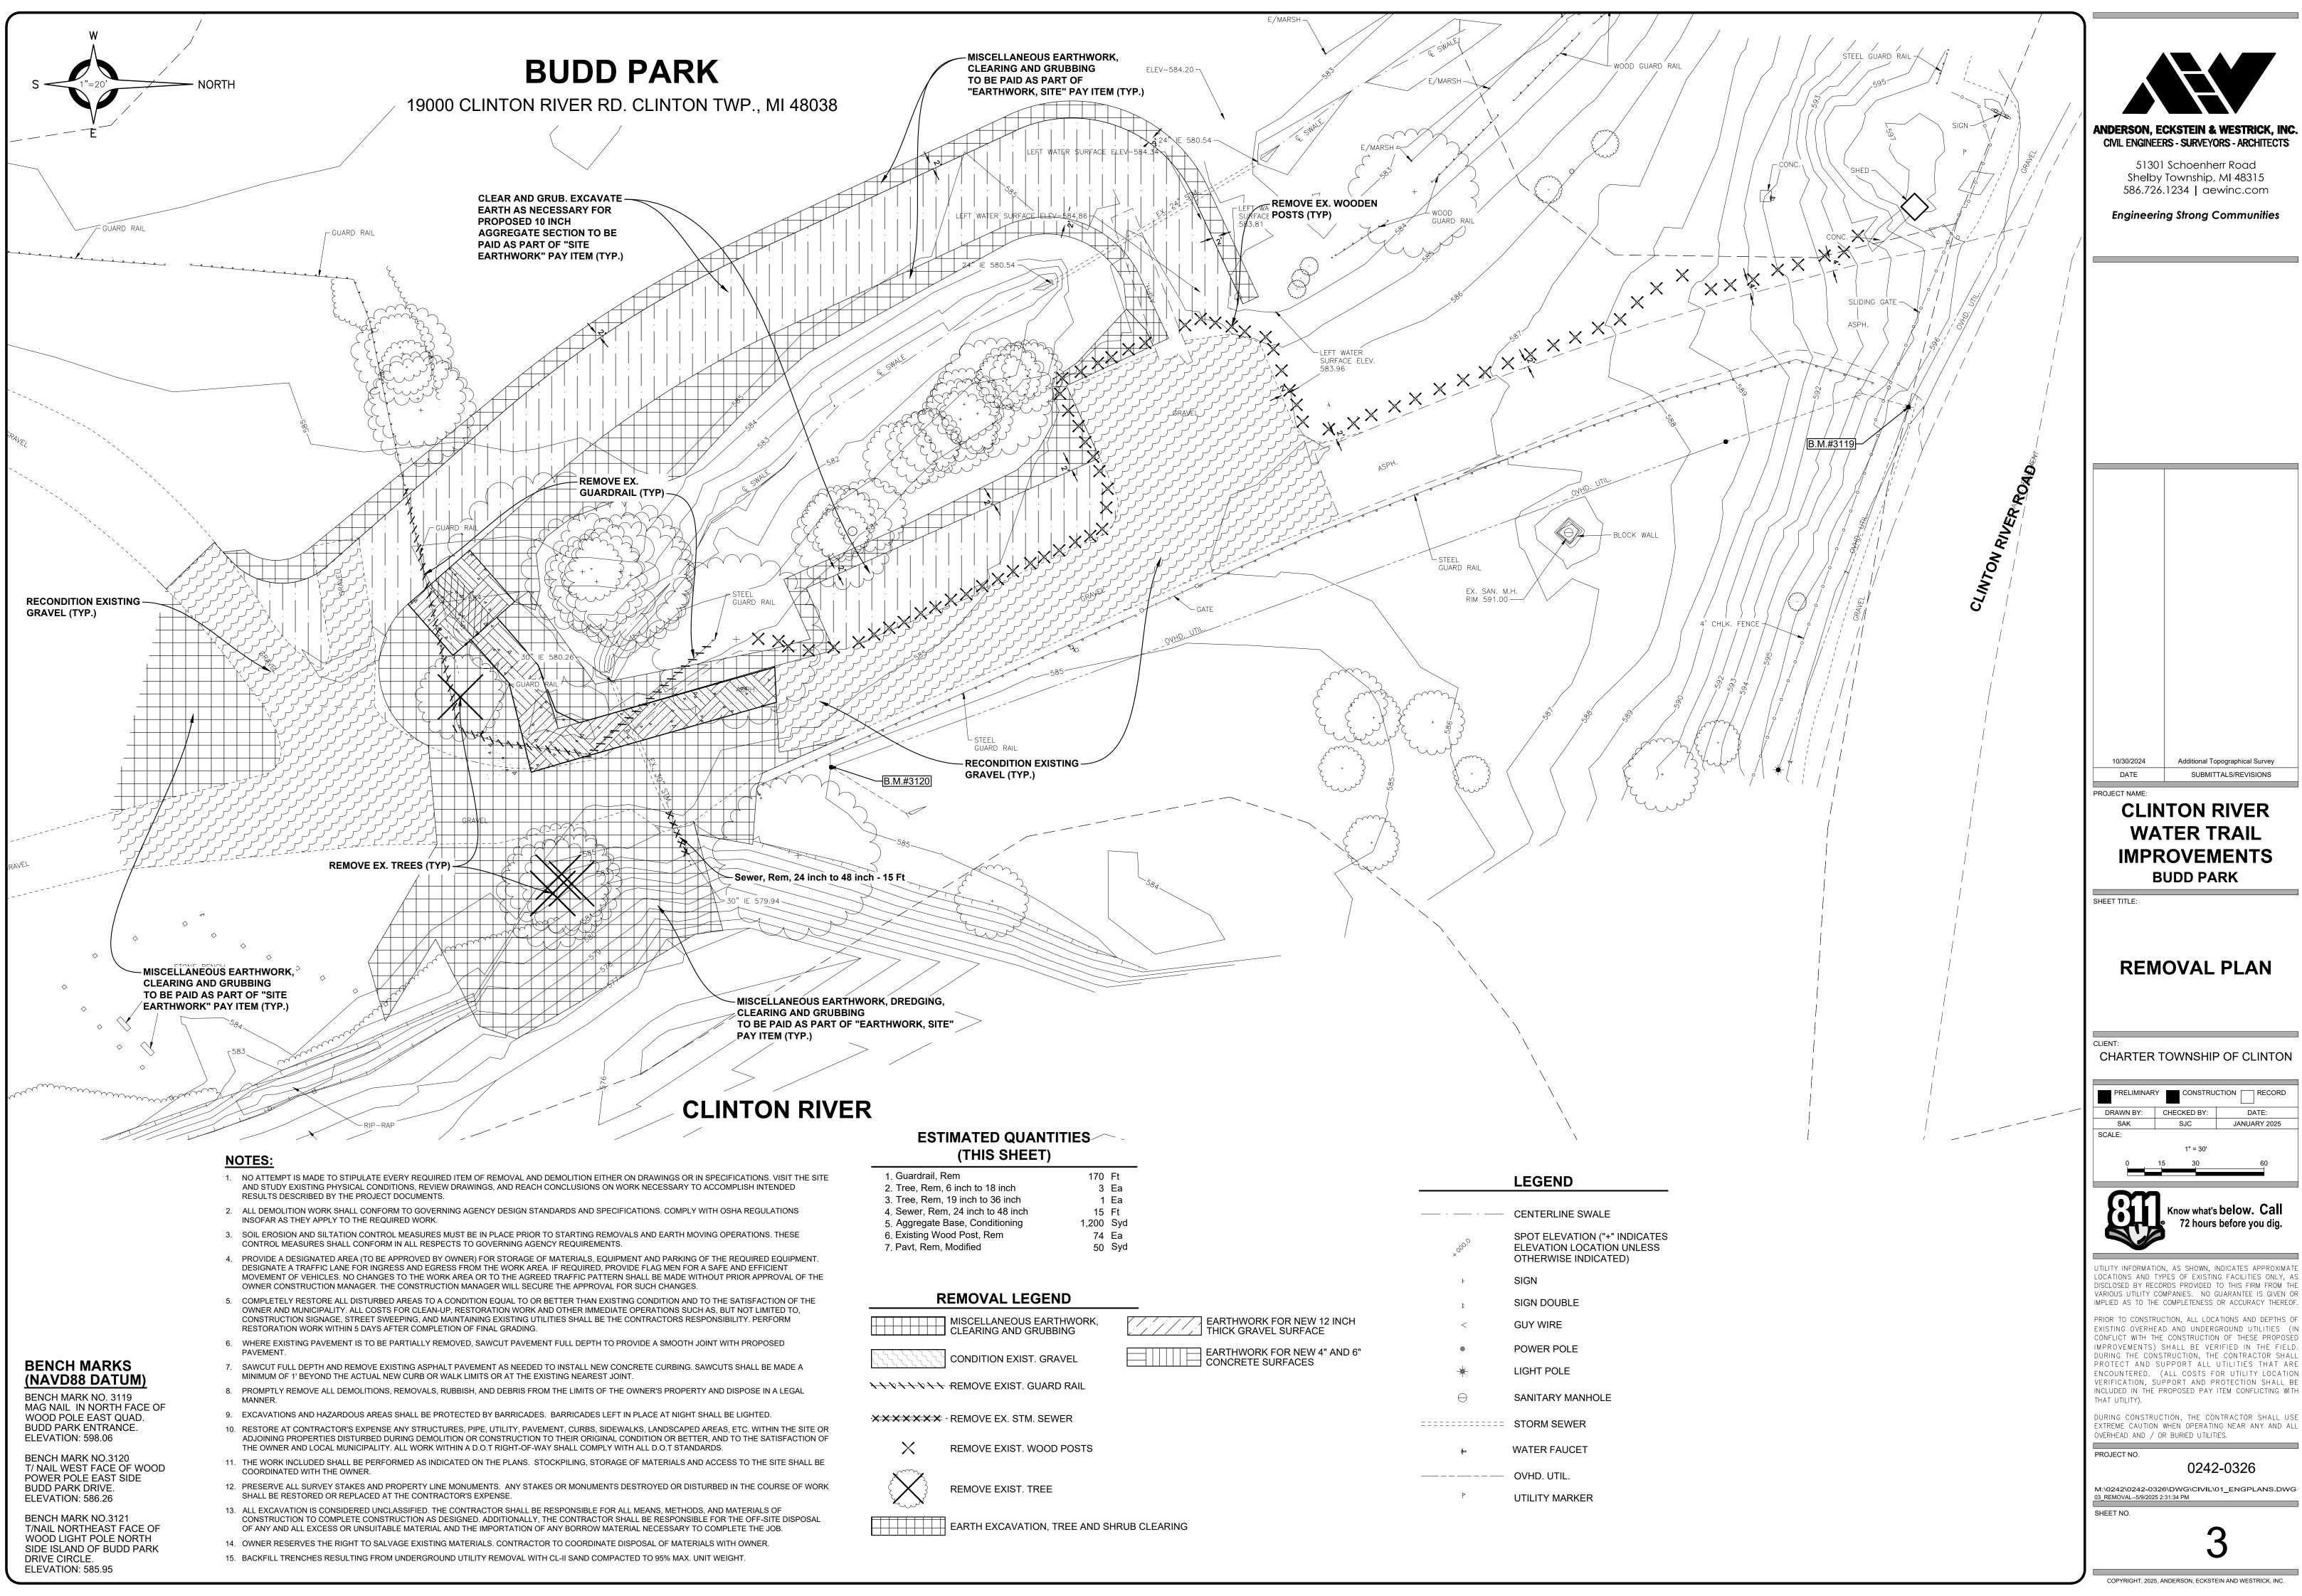

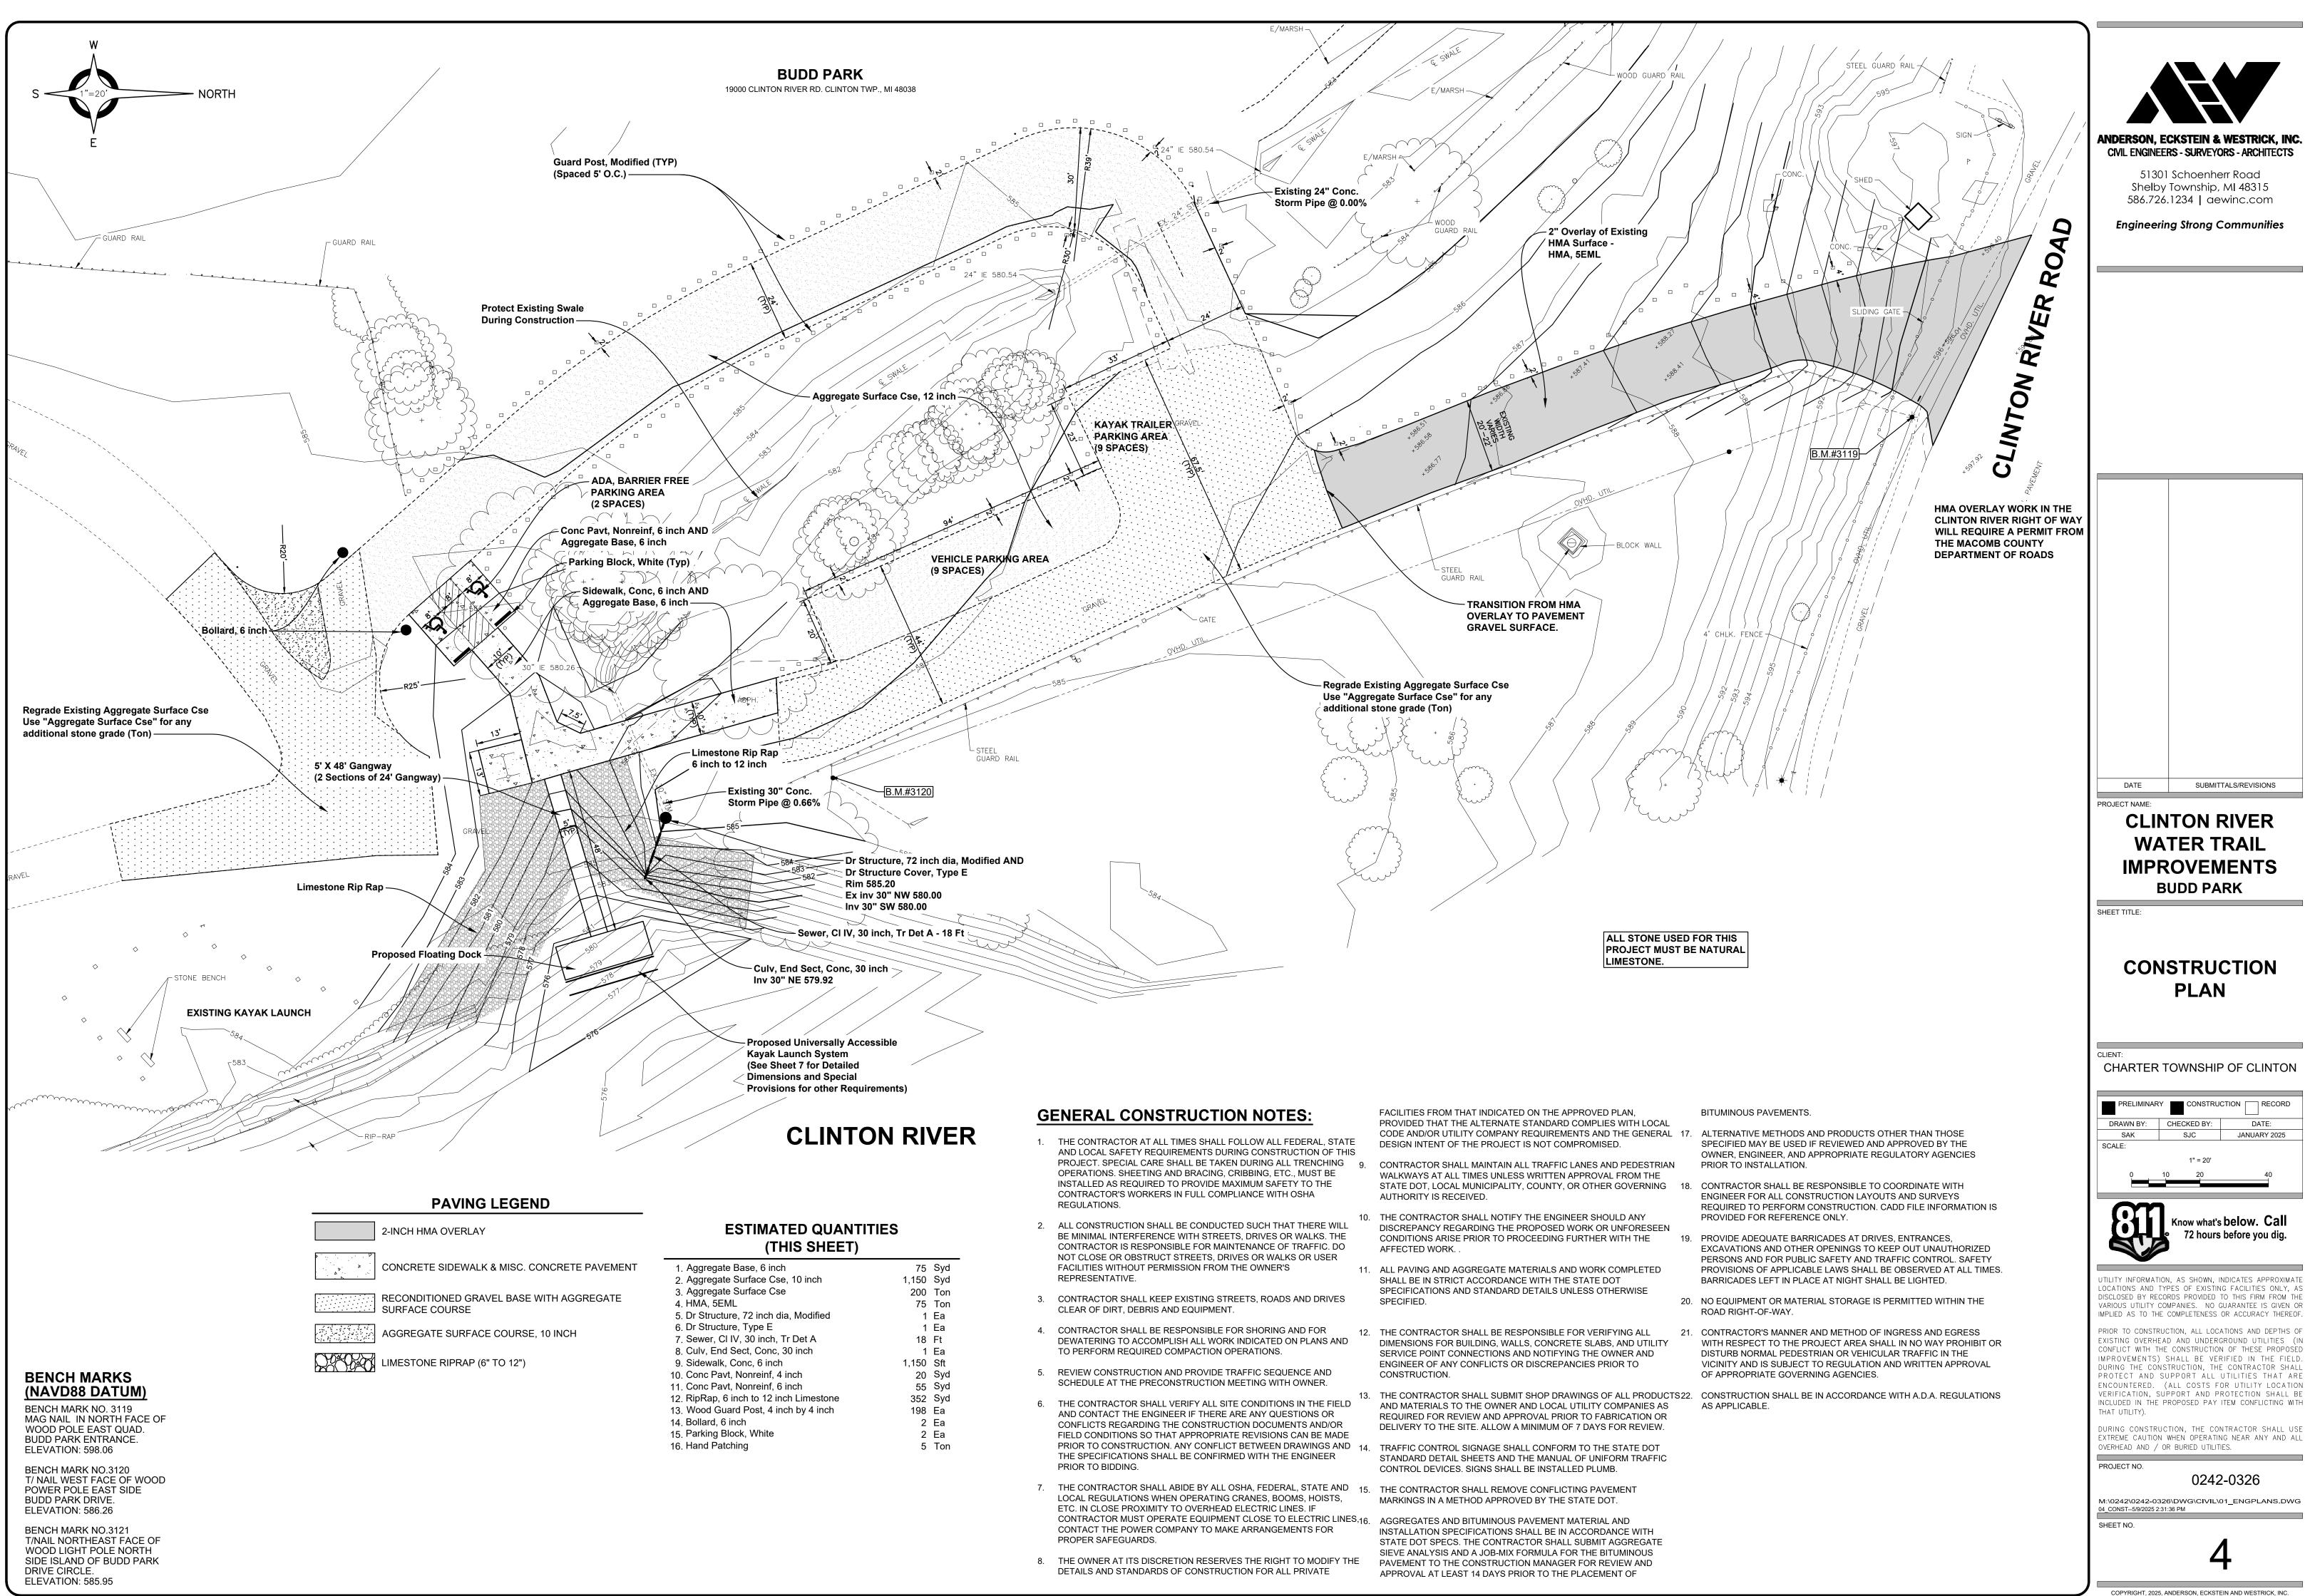


te Base, 6 inch	75	Syd
te Surface Cse, 10 inch	1,150	Syd
te Surface Cse	200	Ton
ML	75	Ton
ture, 72 inch dia, Modified	1	Ea
ture, Type E	1	Ea
CI IV, 30 inch, Tr Det A	18	Ft
d Sect, Conc, 30 inch	1	Ea
k, Conc, 6 inch	1,150	Sft
vt, Nonreinf, 4 inch	20	Syd
vt, Nonreinf, 6 inch	55	Syd
6 inch to 12 inch Limestone	352	Syd
uard Post, 4 inch by 4 inch	198	Ea
6 inch	2	Ea
Block, White	2	Ea
tching	5	Ton

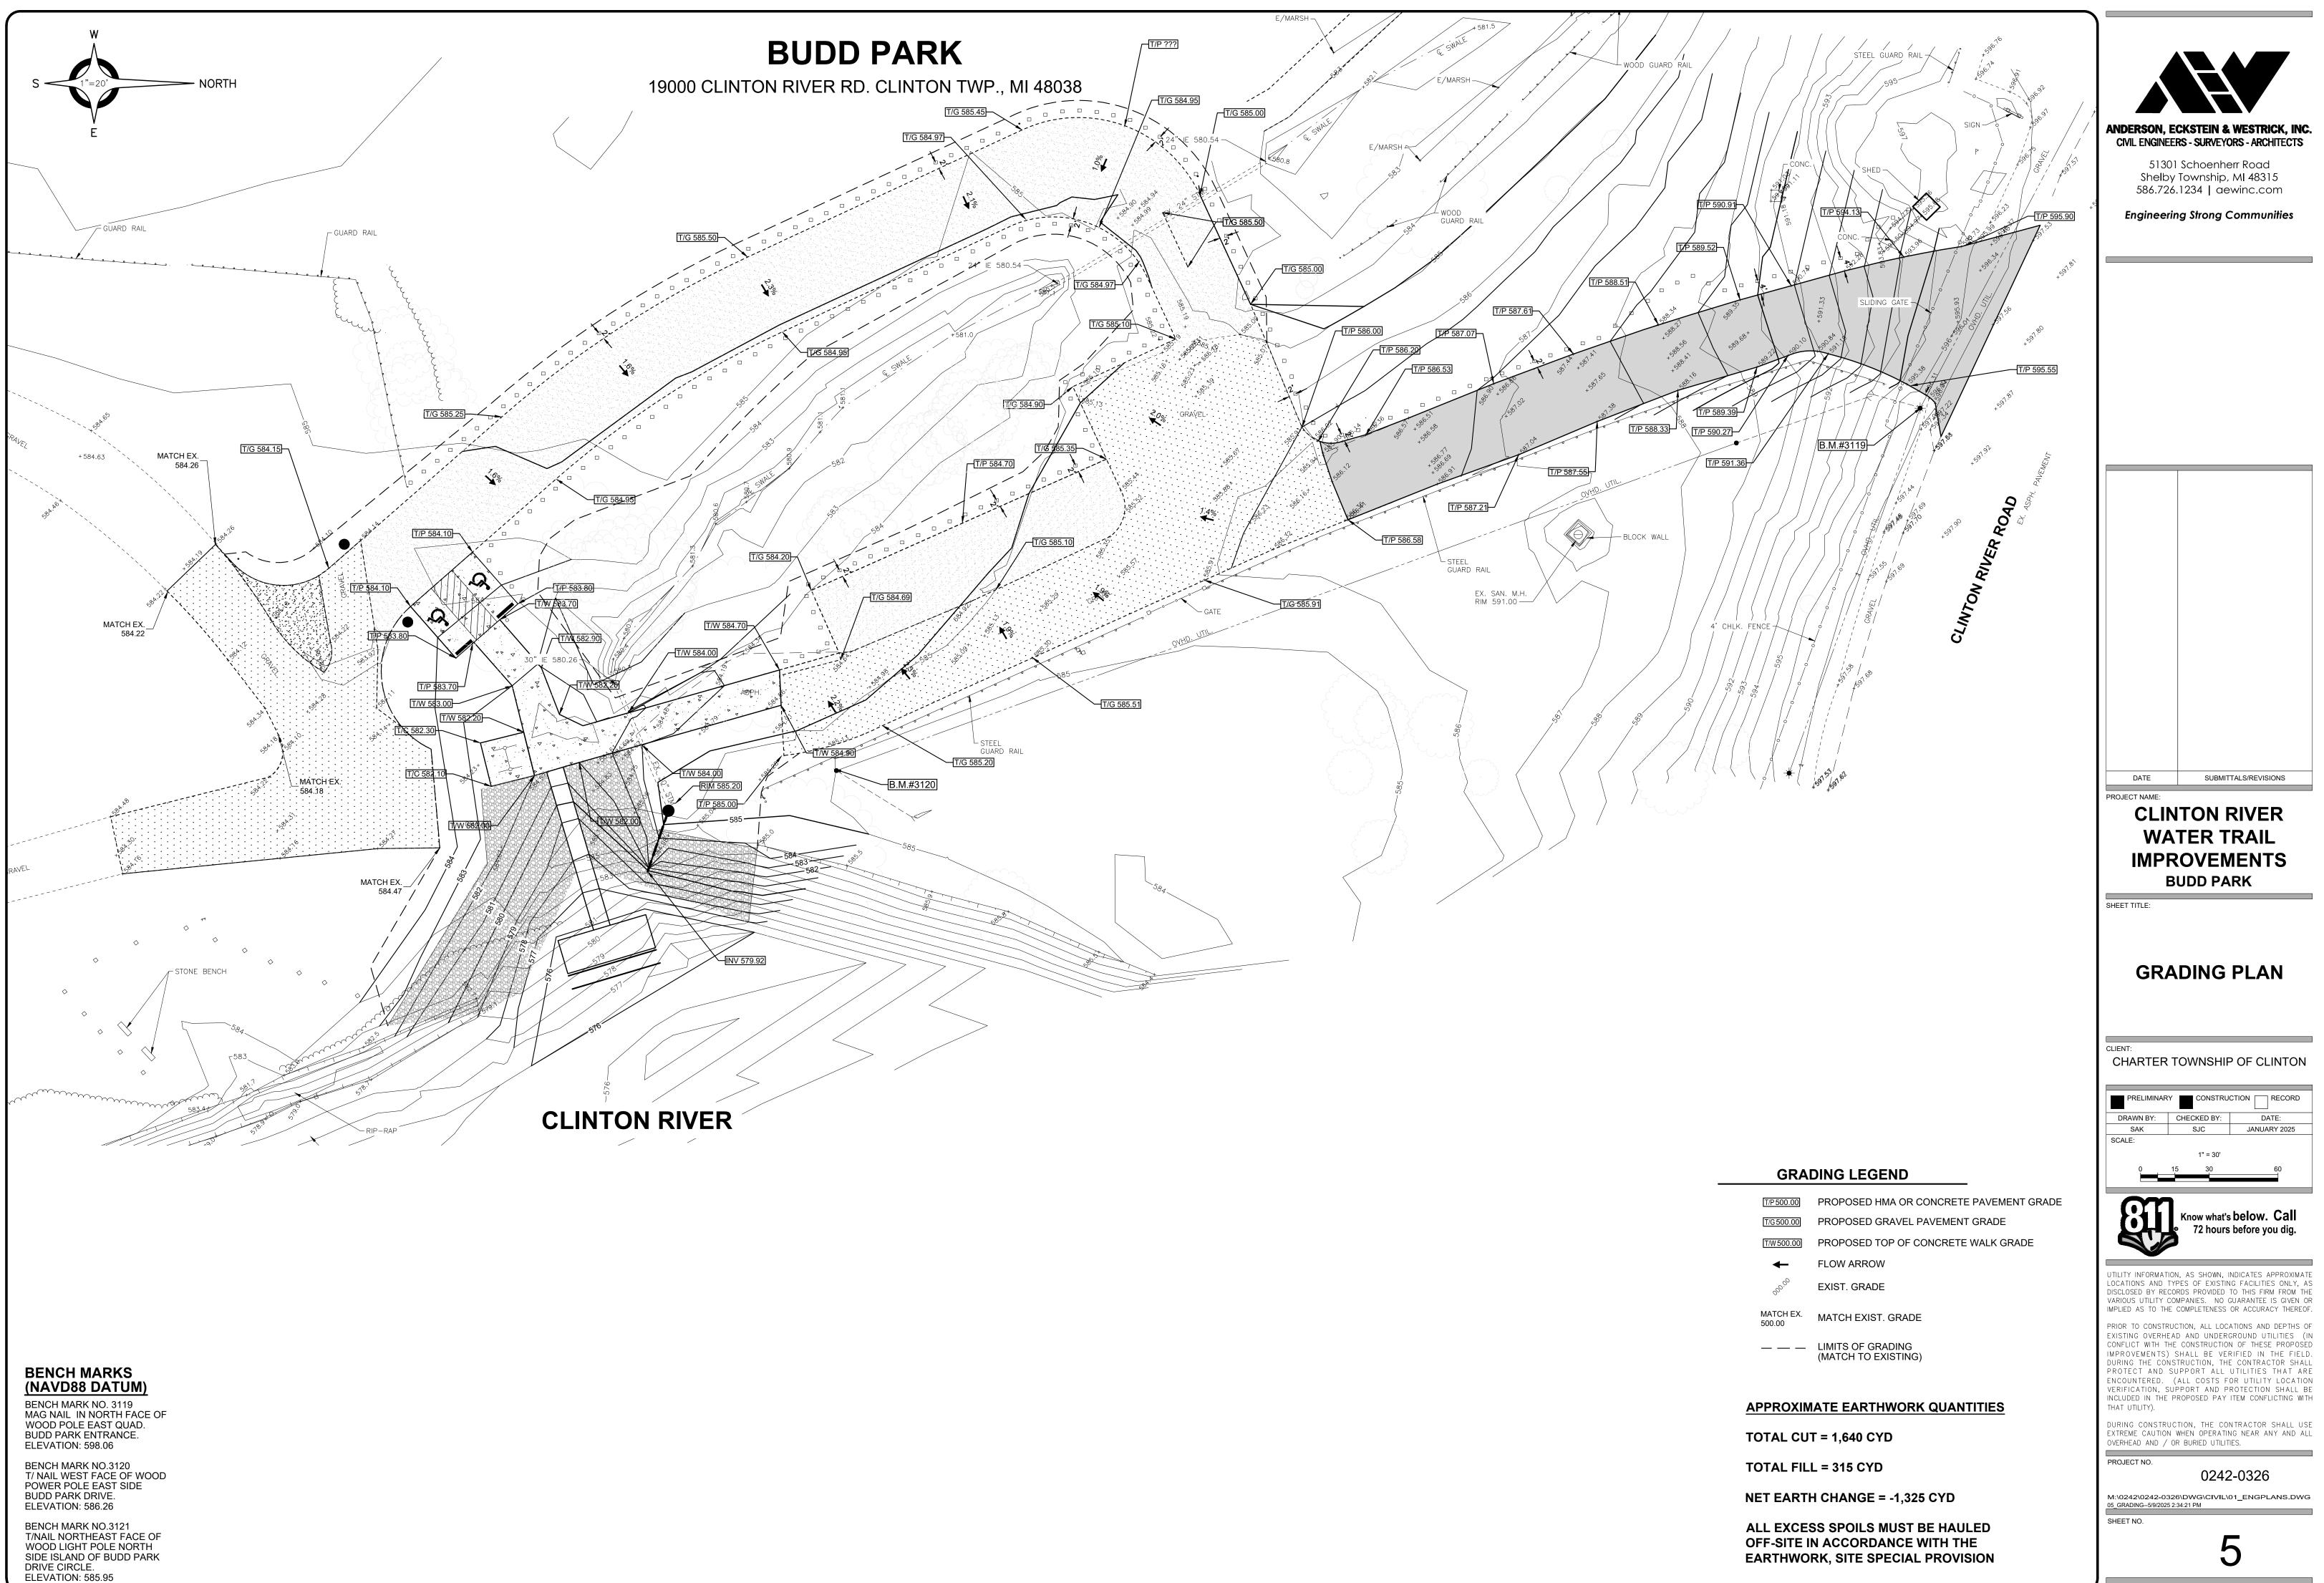



T/P 500.00	Pl
T/G 500.00	PI
T/W 500.00	PI
←	FL
0 ^{00.}	E


COPYRIGHT, 2025, ANDERSON, ECKSTEIN AND WESTRICK, INC.

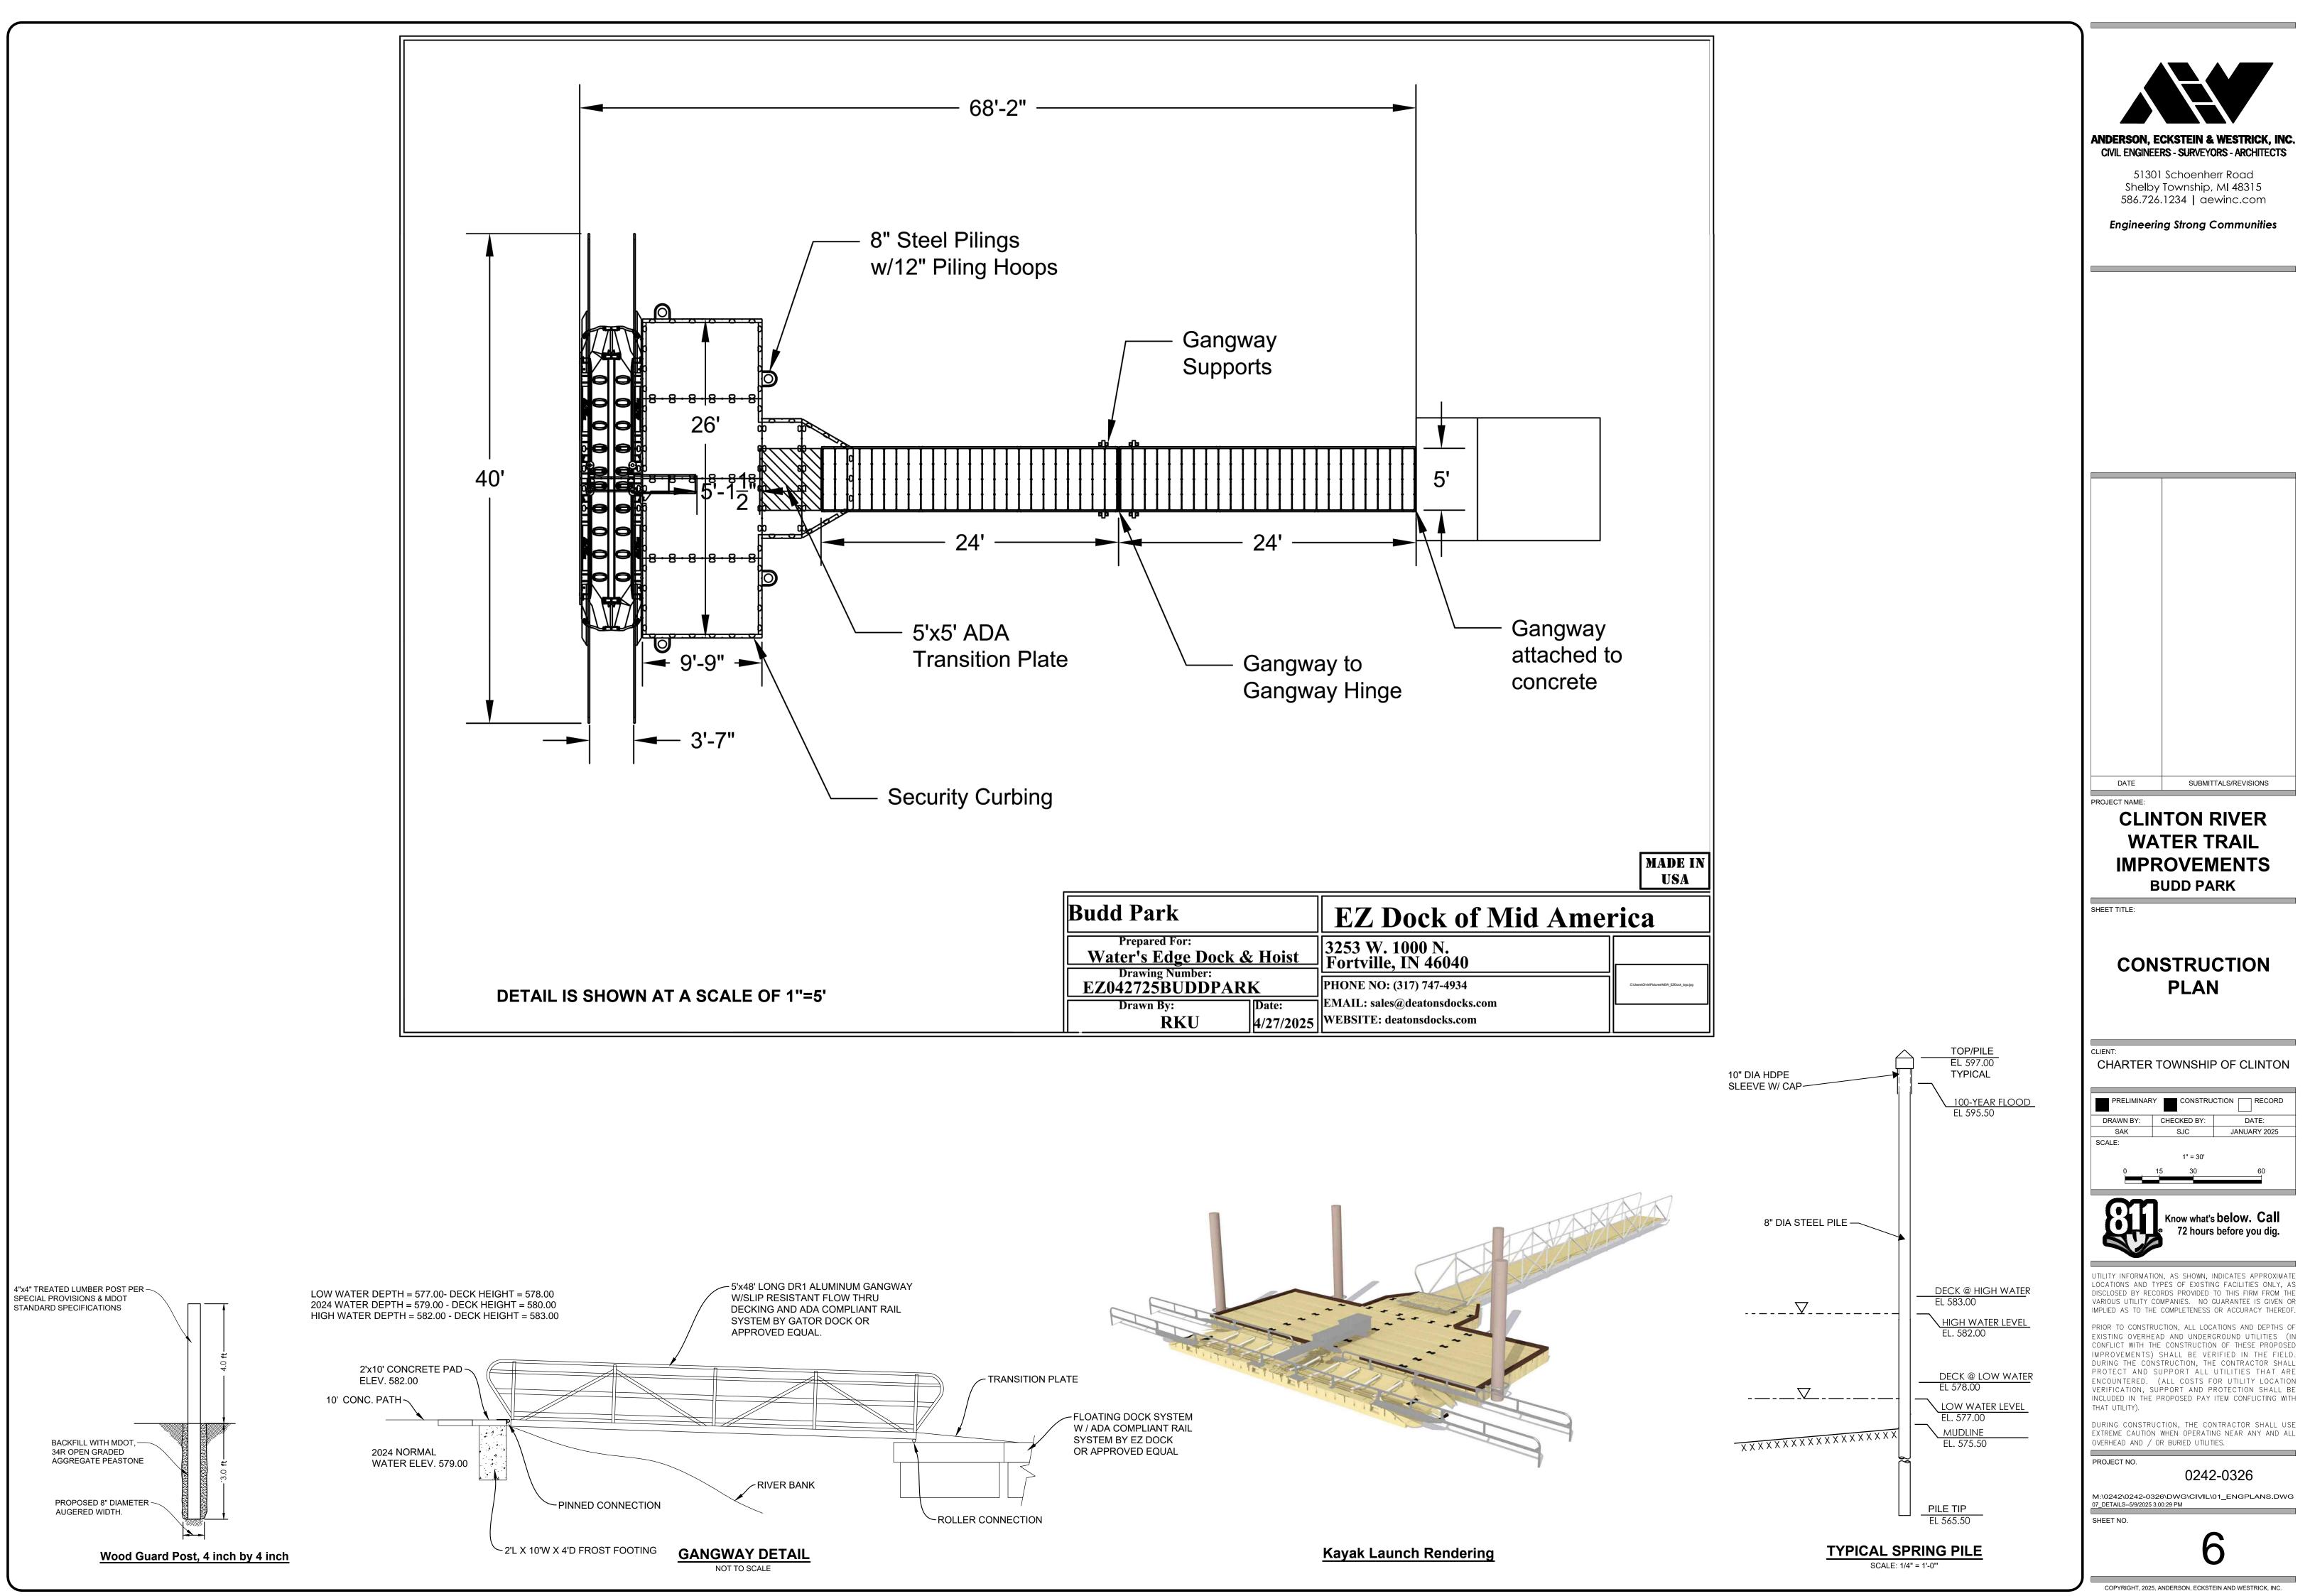

	Budd Park		EZ Dock of Mid An	
	Prepared For: Water's Edge Dock of Drawing Number:		3253 W. 1000 N. Fortville, IN 46040	
ALE OF 1"=5'	EZ042725BUDDPAR	RK	PHONE NO: (317) 747-4934	
	Drawn By:	Date:	EMAIL: sales@deatonsdocks.com	
	RKU	4/27/2025	WEBSITE: deatonsdocks.com	

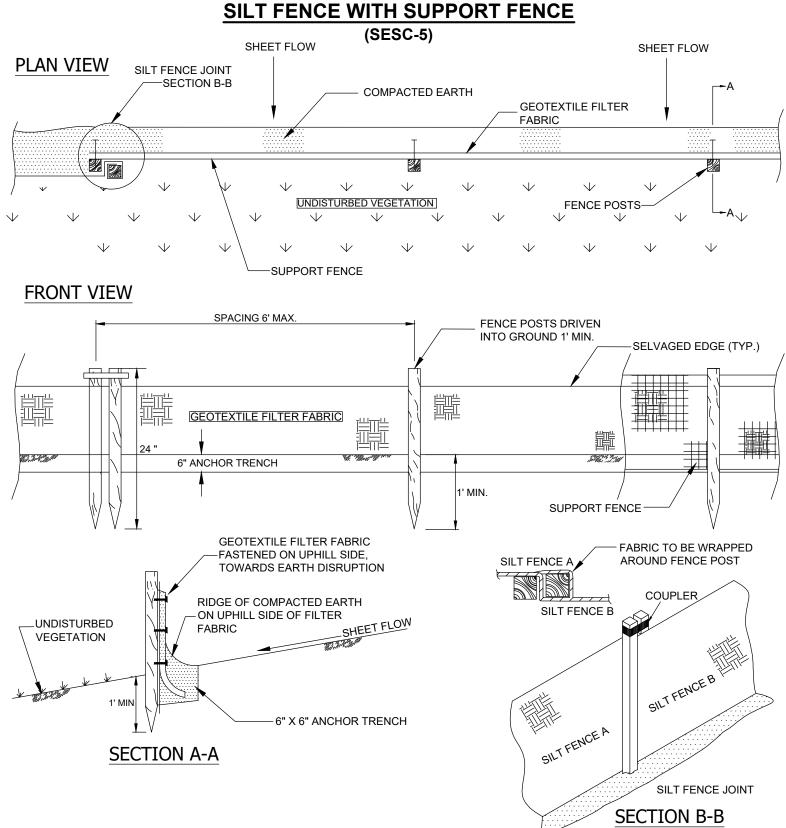

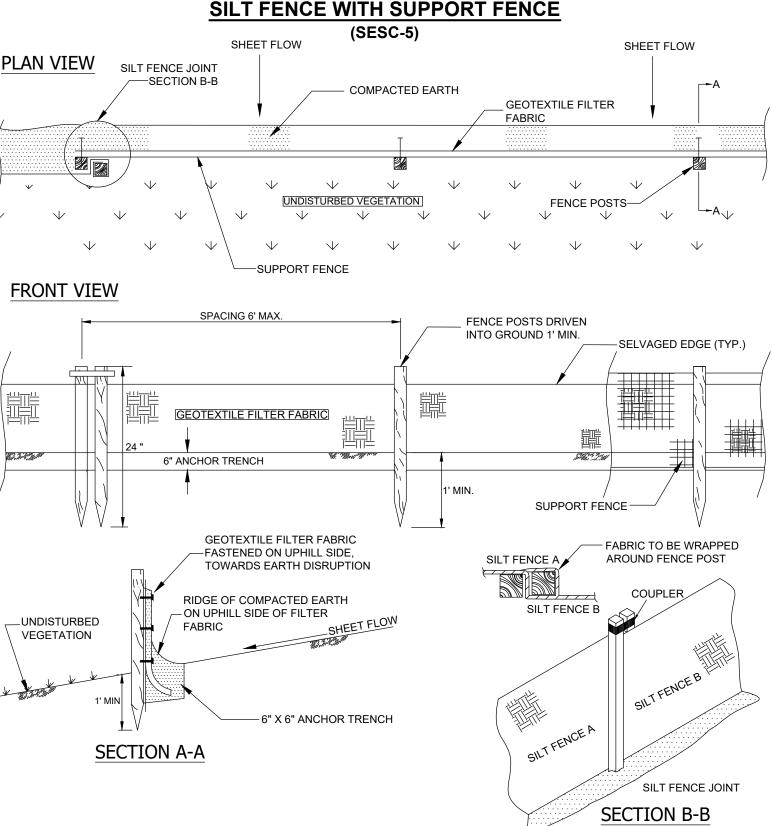

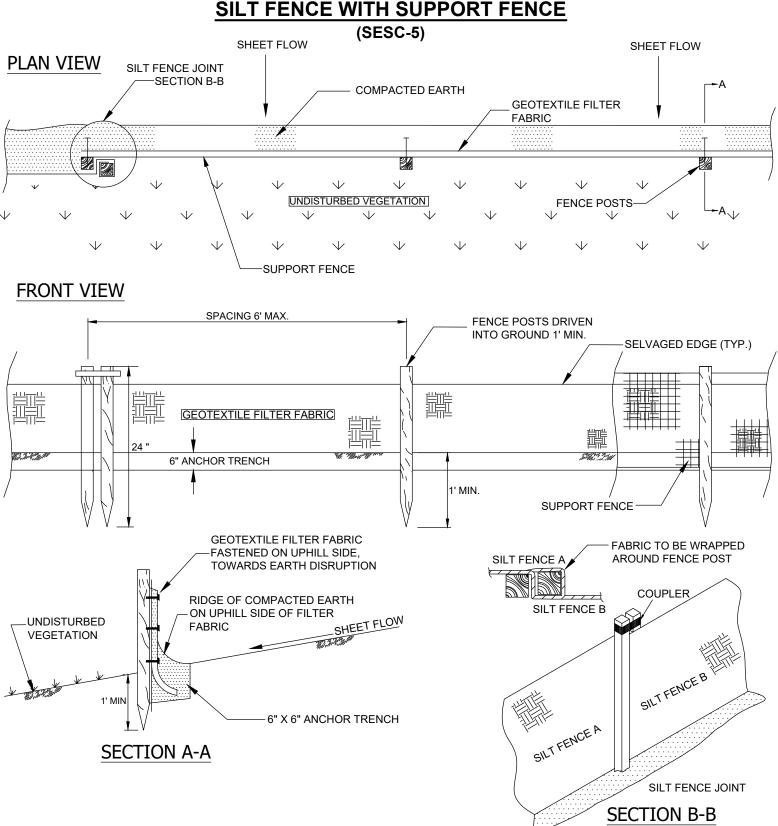

MAINTENANCE NOTES

- THE CONTRACTOR SHALL SCRAPE AS NEEDED AND SWEEP ALL TRUCK ROUTES ON A WEEKLY BASIS.
- TEMPORARY ACCESS ROADS SHALL BE MAINTAINED WEEKLY.
- THE EROSION CONTROL DEVICES SHALL BE THE CONTRACTOR'S RESPONSIBILITY.
- REQUIRED.
- DUST CONTROL TO BE MAINTAINED WITH A WATER TRUCK OR AN APPROVED METHOD ON AS NEEDED BASIS.
- CONTRACTOR TO KEEP EXPOSED GROUND TO A MINIMUM

SEQUENCE OF EVENTS

NOTICE TO PROCEED START DEMO, EARTHWORK & GRADING SIDEWALK CONSTRUCTION & PAVEMENT W INSTALL KAYAK LAUNCH, SITE WORK COMP SUBSTANTIAL COMPLETION

1" REBAR FOR BAG REMOVAL FROM INLET-OVERFLOW DUMP LOOPS-



• THE CONTRACTOR SHALL INSTRUCT ALL TRUCK DRIVERS TO CLEAN SOIL MATERIALS FROM TIRES PRIOR TO ENTERING UPON EXIST. ROADS.

• THE DESIGNATED RESPONSIBLE PARTY FOR INSTALLATION AND MAINTENANCE OF

• SILT FENCE SHALL BE CLEANED WHEN 2/3 FULL OR REPAIRED AS REQUIRED.

• SILT SCREENS SHALL BE CLEANED OR REPAIRED AS REQUIRED.

• THE CONTRACTOR SHALL SWEEP THE ROADS WITHIN THE DEVELOPMENT AS

	SEPT	OCT	NOV
	Х		
	Х		
VORK	Х	Х	
PLETE		Х	
			Х

- 1. THIS PROJECT SHALL BE CONSTRUCTED IN COMPLIANCE WITH PART 91 OF ACT 451 OF 1994, AS AMENDED. THE SOIL EROSION AND SEDIMENTATION CONTROL ACT AND THE MACOMB COUNTY SOIL EROSION AND SEDIMENTATION CONTROL ORDINANCE.
- 2. ALL EROSION AND SEDIMENTATION CONTROL WORK SHALL CONFORM TO THE STANDARDS AND SPECIFICATIONS OF THE MACOMB COUNTY PUBLIC WORKS OFFICE.
- 3. EROSION AND ANY SEDIMENTATION FROM WORK ON THIS SITE SHALL BE CONTAINED ON THE SITE AND NOT ALLOWED TO COLLECT ON ANY OFF SITE AREAS OR IN WATERWAYS. WATERWAYS INCLUDE BOTH NATURAL AND MAN MADE OPEN DITCHES, STREAMS, STORM DRAINS, LAKES, AND PONDS.
- 4. STAGING THE WORK WILL BE DONE BY THE LANDOWNER OR LANDOWNER'S REPRESENTATIVE AS DIRECTED IN THESE PLANS AND AS REQUIRED TO ENSURE PROGRESSIVE STABILIZATION OF DISTURBED FARTH CHANGE
- 5. THE LANDOWNER OR LANDOWNER'S REPRESENTATIVE SHALL BE RESPONSIBLE FOR INSTALLATION AND MAINTENANCE OF SOIL EROSION AND SEDIMENTATION CONTROL DEVICES.
- 6. THE LANDOWNER OR LANDOWNER'S REPRESENTATIVE SHALL IMPLEMENT AND MAINTAIN THE SOIL EROSION CONTROL MEASURES AS SHOWN ON THE PLANS BEFORE AND AT ALL TIMES DURING CONSTRUCTION ON THIS PROJECT. ANY MODIFICATIONS OR ADDITIONS TO SOIL EROSION CONTROL MEASURES DUE TO CONSTRUCTION OR CHANGED CONDITIONS SHALL BE COMPLIED WITH AS
- REQUIRED OR DIRECTED BY THE MACOMB COUNTY PUBLIC WORKS OFFICE. 7. IF ANY OF THE SESC MEASURES ON THE SITE ARE DEEMED INADEQUATE OR INEFFECTIVE, THE MACOMB COUNTY PUBLIC WORKS OFFICE SESC DIVISION HAS THE RIGHT TO REQUIRE ADDITIONAL
- SESC MEASURES AT THE EXPENSE OF THE LANDOWNER. 8. INSTALL CRUSHED CONCRETE ACCESS DRIVE PLACED ON GEOTEXTILE FABRIC AS INDICATED ON THE PLAN. THE ACCESS DRIVE MUST BE A MINIMUM OF 30' X 50' X 8".
- A. NEW LAYERS OF CRUSHED CONCRETE WILL BE ADDED AS OLD LAYERS BECOME COMPACTED.
- 9. INSTALL SILT FENCE AS INDICATED ON THE PLAN AND AT ADDITIONAL AREAS AS NECESSARY. A. SILT FENCE SHALL BE INSTALLED PER DETAIL.

THE HEIGHT OF THE SILT FENCE.

THE SILT FENCE AND THE INLET.

- B. BUILD UP OF SEDIMENT SHALL BE REMOVED WHEN SEDIMENT ACCUMULATES TO 1/3 TO 1/2 OF
- C. IF SILT FENCE FABRIC DECOMPOSES OR BECOMES INEFFECTIVE PRIOR TO THE END OF EXPECTED USABLE LIFE AND THE BARRIER IS STILL REQUIRED, THE SILT FENCE SHALL BE REPLACED PROMPTLY.
- D. SILT FENCE SHALL BE INSPECTED WEEKLY UNDER NORMAL CONDITIONS, WITHIN 24 HOURS OF RAINFALL AND DAILY DURING A PROLONGED RAIN EVENT. REQUIRED MAINTENANCE SHALL BE PROVIDED PROMPTLY.
- 10. INSTALL INLET FILTER ON ALL PAVEMENT CATCH BASINS PER DETAIL.
- A. INLET FILTERS SHALL BE INSPECTED WEEKLY UNDER NORMAL CONDITIONS, WITHIN 24 HOURS OF A RAINFALL, AND DAILY DURING A PROLONGED RAIN EVENT.
- LIFE AND THE BARRIER IS STILL REQUIRED, THE FABRIC SHALL BE REPLACED PROMPTLY. 11. INSTALL DRAIN GUARD ON ALL YARD CATCH BASINS PER DETAIL. SEED OR SOD THE AREA BETWEEN
- A. DRAIN GUARDS SHALL BE INSPECTED WEEKLY UNDER NORMAL CONDITIONS, WITHIN 24 HOURS OF RAINFALL, AND DURING A PROLONGED RAIN EVENT.
- B. BUILD UP OF SEDIMENT SHALL BE REMOVED WHEN SEDIMENT ACCUMULATES TO 1/3 TO 1/2 OF
- C. IF FABRIC DECOMPOSES OR BECOMES INEFFECTIVE PRIOR TO THE END OF EXPECTED USABLE

- COUNTY PUBLIC WORKS OFFICE.

- OF ONCE PER WEEK BY THE LANDOWNER OR LANDOWNER'S REPRESENTATIVE.
- ISSUED.
- PAVED UPON.
- ESTABLISHED.
- NAME OF & DISTANCE TO NEAREST WATERCOURSE: CLINTON RIVER ON SITE


CONTACT NAME & NUMBER

APPROXIMATE COMPLETION DATE TOTAL ACRES DISTURBED = <u>3.02</u> ACRES

LANDOWNER'S SIGNATURE

ACTION AGAINST THE LANDOWNER.

- THE HEIGHT OF THE SILT FENCE. LIFE AND THE BARRIER IS STILL REQUIRED, THE SILT FENCE SHALL BE REPLACED PROMPTLY.
- B. BUILDUP OF SEDIMENT AND DEBRIS SHALL BE REMOVED PROMPTLY. C. IF FABRIC DECOMPOSES OR BECOMES INEFFECTIVE PRIOR TO THE END OF EXPECTED USABLE

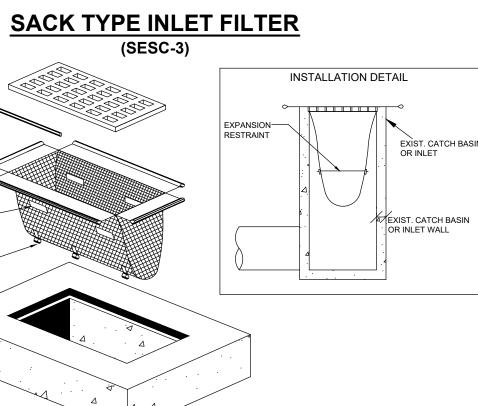

12. INLET SEDIMENT TRAPS AND ALL DITCH SEDIMENT TRAPS SHALL BE INSPECTED DAILY. THE SEDIMENT PITS SHALL BE CLEANED OUT WHEN HALF FULL, OR AS DIRECTED BY THE MACOMB

13. ALL STOCKPILED SOILS SHALL BE MAINTAINED IN SUCH A WAY AS TO PREVENT EROSION FROM LEAVING THE SITE. IF THE STOCKPILE WILL BE ON SITE FOR MORE THAN 30 DAYS, THE STOCKPILE MUST BE SEEDED. SILT FENCE MUST BE INSTALLED AROUND THE PERIMETER OF THE STOCKPILE.

. IMMEDIATELY AFTER SEEDING, MULCH ALL SEEDED AREAS WITH UNWEATHERED SMALL GRAIN STRAW, SPREAD UNIFORMLY AT THE RATE OF 1-1/2 TO 2 TONS PER ACRE OR 100 POUNDS (2-3 BALES) PER 1000 SQUARE FEET. THIS MULCH SHOULD BE ANCHORED WITH DISC TYPE MULCH ANCHORING TOOL OR OTHER MEANS AS APPROVED BY THE MACOMB COUNTY PUBLIC WORKS OFFICE. MULCH MATTING MAY BE USED IN LIEU OF LOOSE MULCH.

15. IF ANY DEWATERING IS NEEDED, IT SHALL BE DISCHARGED THROUGH A FILTER BAG OVER A WELL VEGETATED AREA. THE PUMP MUST DISCHARGE AT A NON-EROSIVE VELOCITY. IF NECESSARY, AN APPROVED ENERGY DISSIPATER MAY BE USED.

16. ALL DIRT TRACKED ONTO ANY ROADWAY SHALL BE REMOVED IMMEDIATELY. 17. STREETS AND OR PARKING AREAS WILL BE SCRAPED ON A DAILY BASIS AND SWEPT AT A MINIMUM

18. DURING DRY PERIODS, ALL DISTURBED AREAS SHALL BE WATERED FOR DUST CONTROL.

19. PERMANENT SOIL EROSION CONTROL MEASURES FOR ALL SLOPES, CHANNELS, DITCHES, OR ANY DISTURBED LAND AREA SHALL BE COMPLETED WITHIN 5 CALENDAR DAYS AFTER FINAL GRADING OR THE FINAL EARTH CHANGE HAS BEEN COMPLETED. WHEN IT IS NOT POSSIBLE TO PERMANENTLY STABILIZE A DISTURBED AREA AFTER EARTH CHANGE HAS BEEN COMPLETED OR WHERE SIGNIFICANT EARTH CHANGE HAS BEEN COMPLETED OR WHERE SIGNIFICANT EARTH CHANGES ACTIVITY CEASES, TEMPORARY SOIL EROSION CONTROL MEASURES SHALL BE IMPLEMENTED IMMEDIATELY. ALL TEMPORARY SOIL EROSION CONTROL SHALL BE MAINTAINED UNTIL PERMANENT SOIL EROSION CONTROL MEASURES ARE IMPLEMENTED. ALL PERMANENT SOIL EROSION CONTROL MEASURES WILL BE IMPLEMENTED AND ESTABLISHED BEFORE A CERTIFICATE OF COMPLIANCE IS

20. FINAL GRADE, ESTABLISH VEGETATION, AND OR LANDSCAPE ALL DISTURBED AREAS NOT BUILT OR


21. REMOVE ALL TEMPORARY SOIL EROSION DEVICES AFTER PERMANENT STABILIZATION IS

NAME(S) & PHONE NUMBER(S) FOR PERSON(S) RESPONSIBLE FOR THE MAINTENANCE OF ALL TEMPORARY & PERMANENT SOIL EROSION CONTROL MEASURES:

APPROXIMATE START DATE____

I UNDERSTAND MY RESPONSIBILITY OUTLINED UNDER THESE GUIDELINES.


DATE FAILURE TO COMPLY WITH THE SESC PLAN AND THESE GUIDELINES MAY RESULT IN ENFORCEMENT

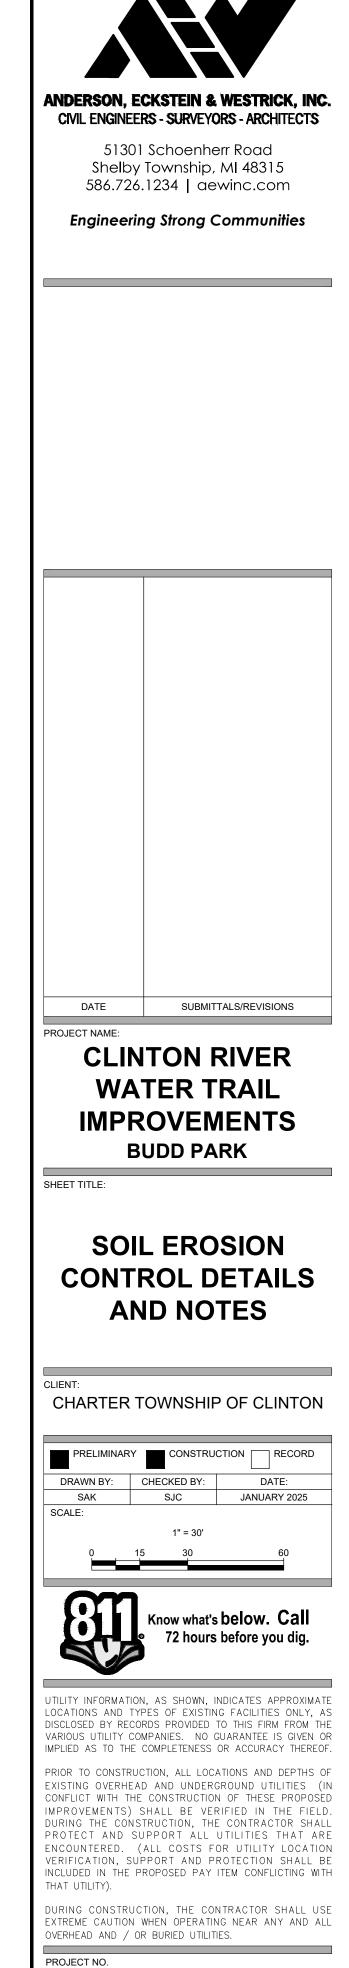


0242-0326

M:\0242\0242-0326\DWG\CIVIL\01_ENGPLANS.DWG 08_SESC DTLS--5/9/2025 2:31:39 PM SHEET NO.

COPYRIGHT, 2025, ANDERSON, ECKSTEIN AND WESTRICK, INC.

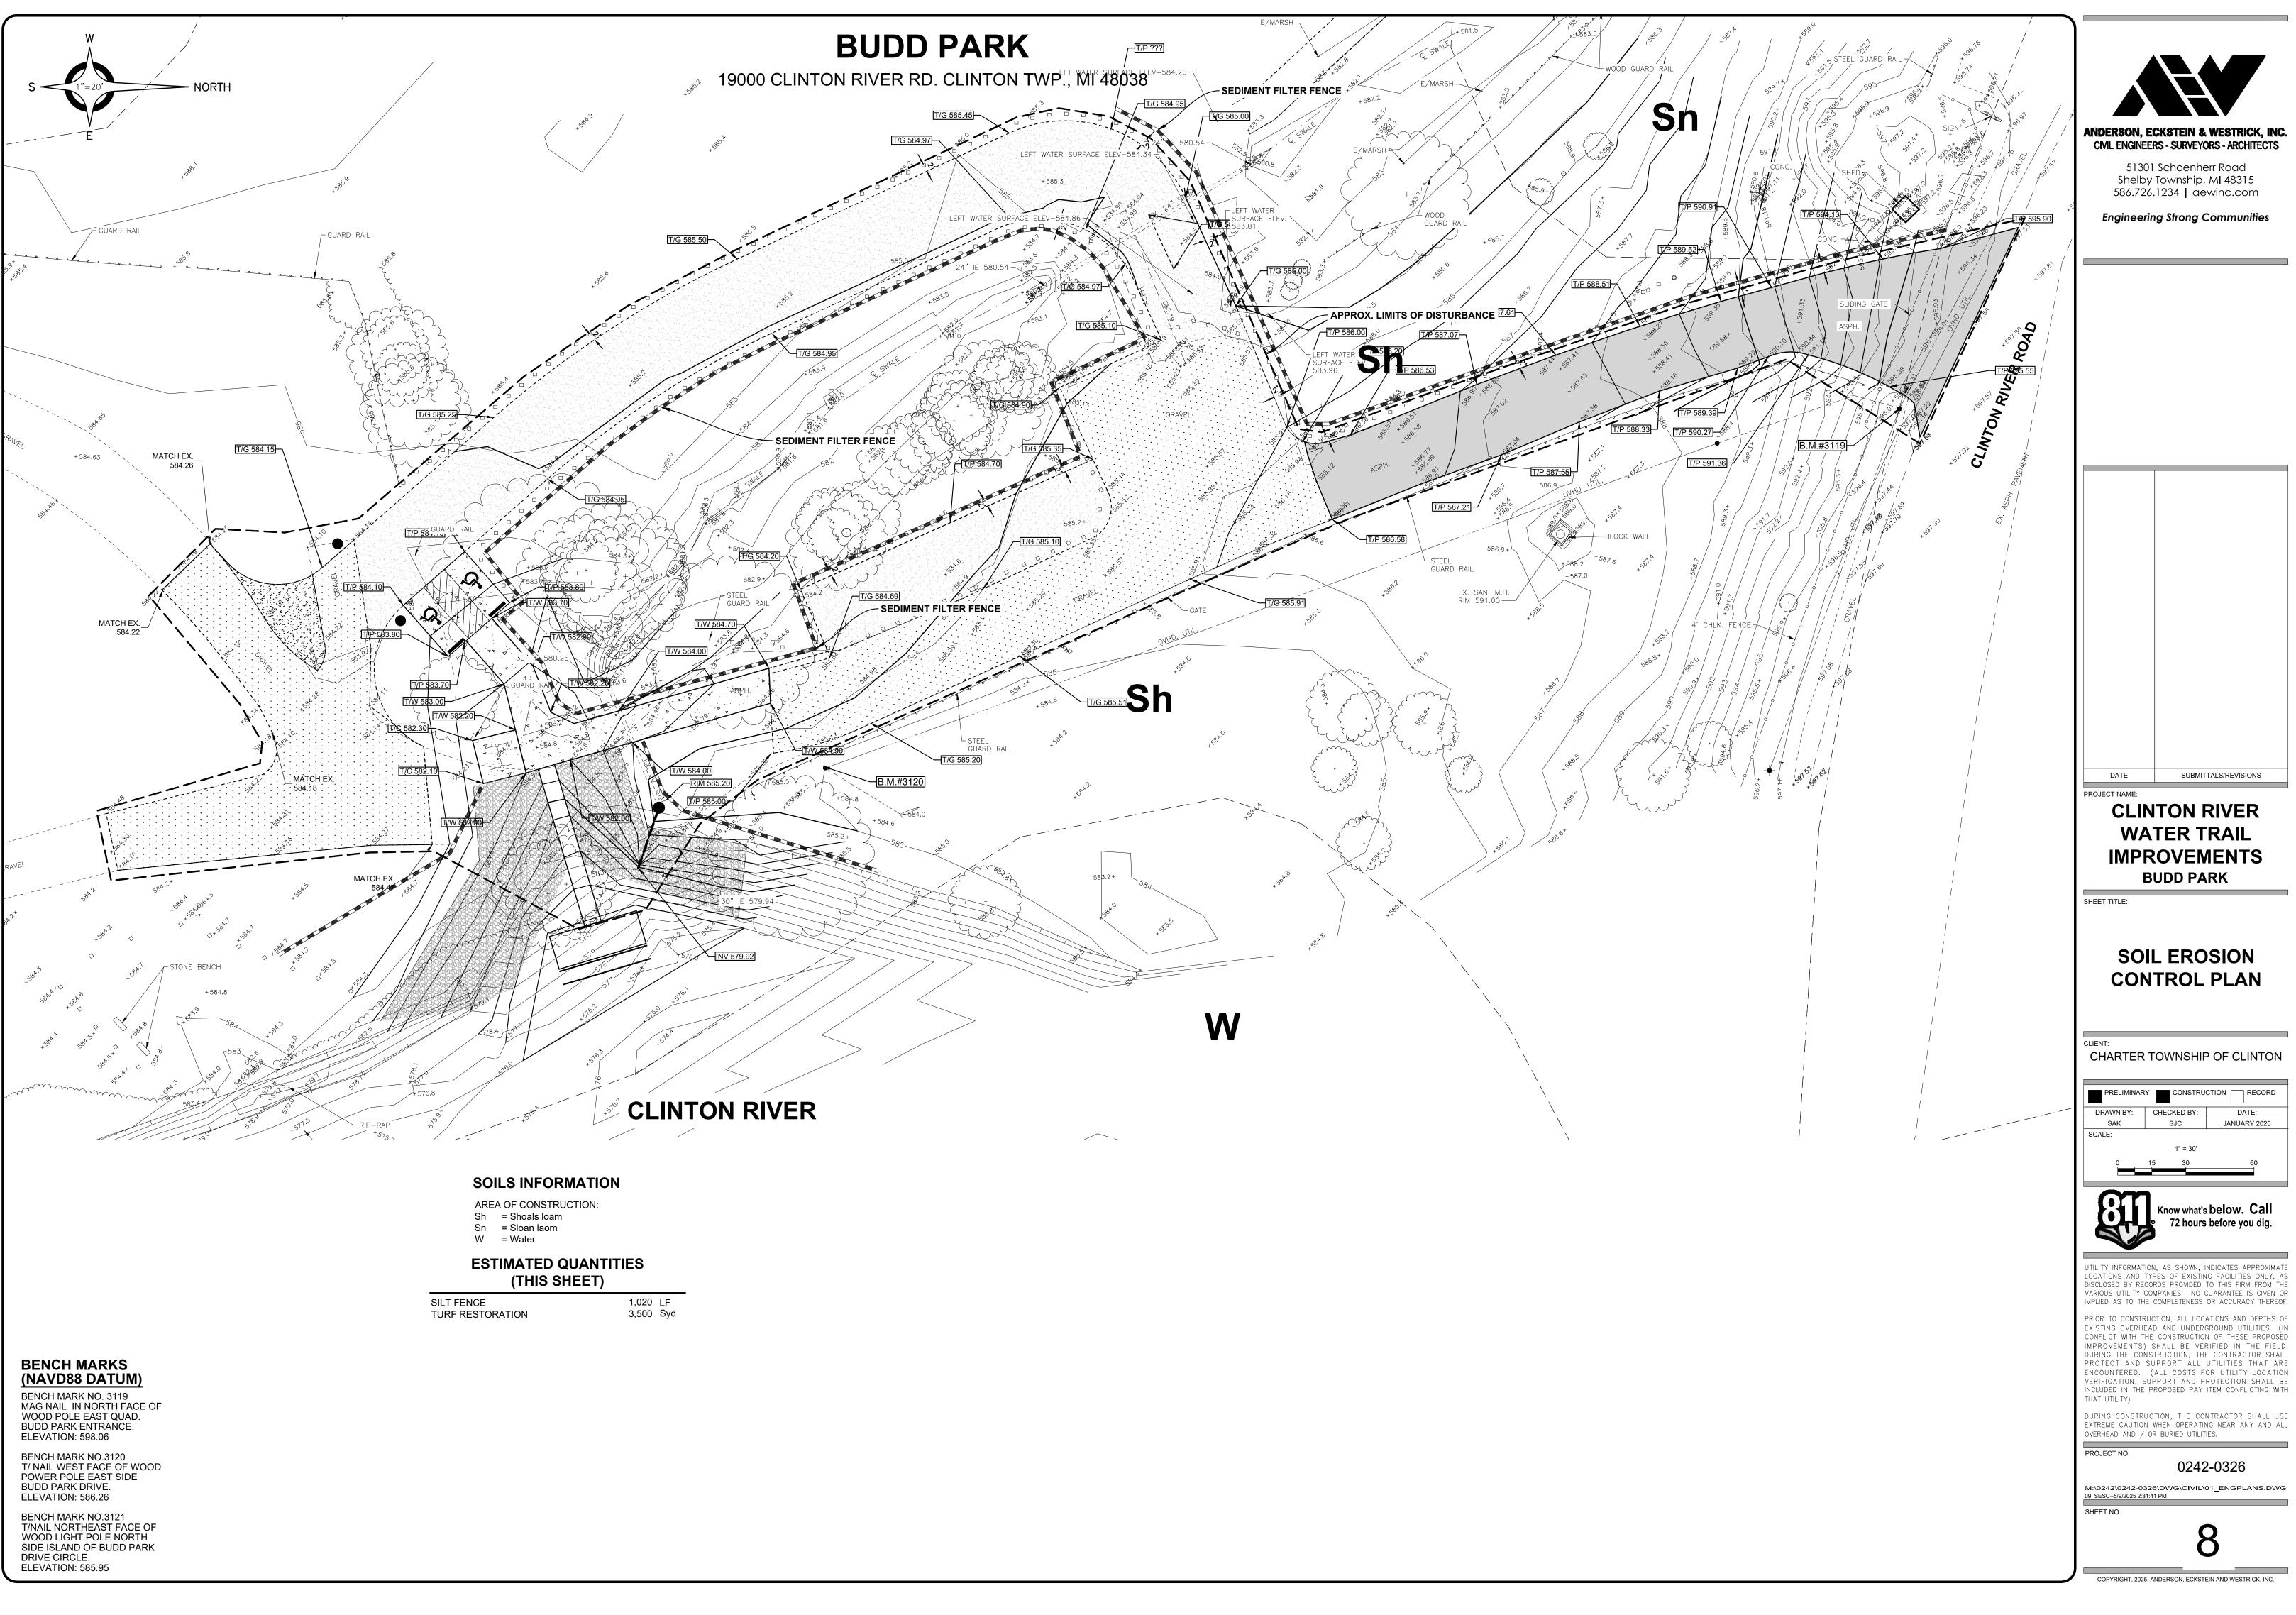

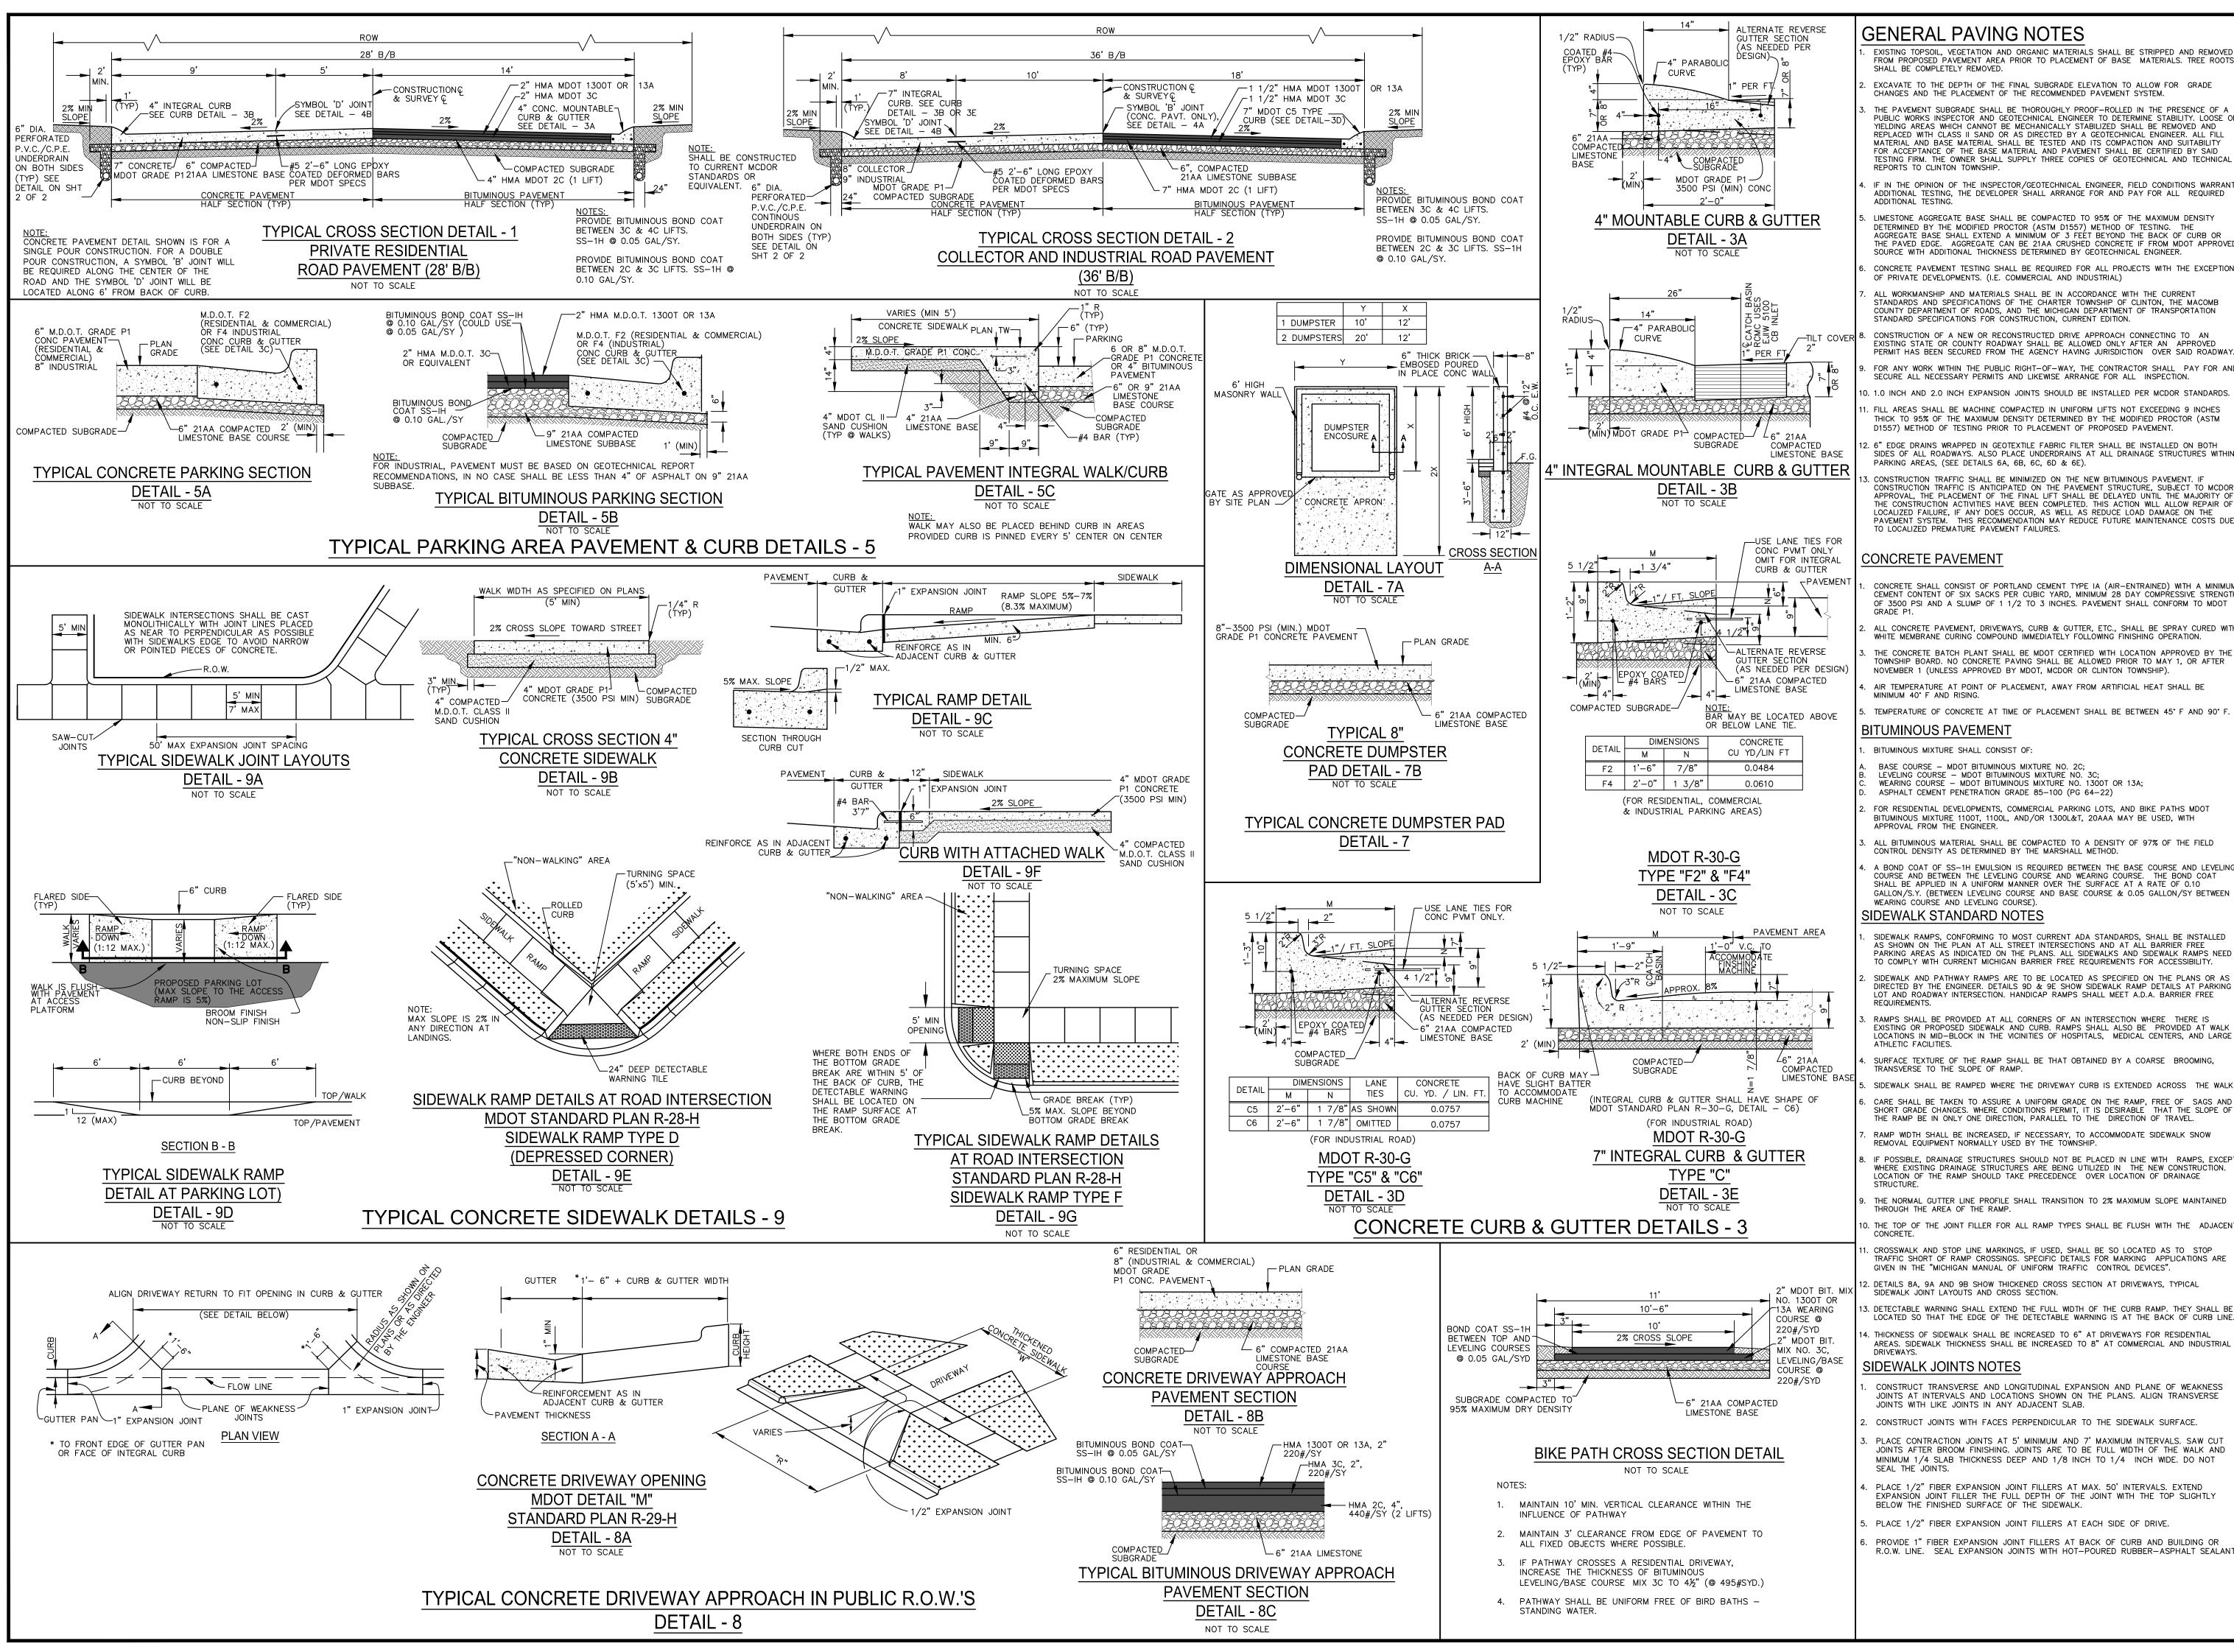

GENERAL PAVING NOTES

- EXISTING TOPSOIL, VEGETATION AND ORGANIC MATERIALS SHALL BE STRIPPED AND REMOVED FROM PROPOSED PAVEMENT AREA PRIOR TO PLACEMENT OF BASE MATERIALS. TREE ROOTS SHALL BE COMPLETELY REMOVED.
- EXCAVATE TO THE DEPTH OF THE FINAL SUBGRADE ELEVATION TO ALLOW FOR GRADE CHANGES AND THE PLACEMENT OF THE RECOMMENDED PAVEMENT SYSTEM.
- THE PAVEMENT SUBGRADE SHALL BE THOROUGHLY PROOF-ROLLED IN THE PRESENCE OF A PUBLIC WORKS INSPECTOR AND GEOTECHNICAL ENGINEER TO DETERMINE STABILITY. LOOSE OF YIELDING AREAS WHICH CANNOT BE MECHANICALLY STABILIZED SHALL BE REMOVED AND REPLACED WITH CLASS II SAND OR AS DIRECTED BY A GEOTECHNICAL ENGINEER. ALL FILL MATERIAL AND BASE MATERIAL SHALL BE TESTED AND ITS COMPACTION AND SUITABILITY FOR ACCEPTANCE OF THE BASE MATERIAL AND PAVEMENT SHALL BE CERTIFIED BY SAID TESTING FIRM. THE OWNER SHALL SUPPLY THREE COPIES OF GEOTECHNICAL AND TECHNICAL REPORTS TO CLINTON TOWNSHIP.
- IF IN THE OPINION OF THE INSPECTOR/GEOTECHNICAL ENGINEER, FIELD CONDITIONS WARRANT ADDITIONAL TESTING, THE DEVELOPER SHALL ARRANGE FOR AND PAY FOR ALL REQUIRED ADDITIONAL TESTING.
- LIMESTONE AGGREGATE BASE SHALL BE COMPACTED TO 95% OF THE MAXIMUM DENSITY DETERMINED BY THE MODIFIED PROCTOR (ASTM D1557) METHOD OF TESTING. THE AGGREGATE BASE SHALL EXTEND A MINIMUM OF 3 FEÉT BEYOND THE BACK OF CURB OR THE PAVED EDGE. AGGREGATE CAN BE 21AA CRUSHED CONCRETE IF FROM MDOT APPROVED SOURCE WITH ADDITIONAL THICKNESS DETERMINED BY GEOTECHNICAL ENGINEER.
- CONCRETE PAVEMENT TESTING SHALL BE REQUIRED FOR ALL PROJECTS WITH THE EXCEPTION OF PRIVATE DEVELOPMENTS. (I.E. COMMERCIAL AND INDUSTRIAL) ALL WORKMANSHIP AND MATERIALS SHALL BE IN ACCORDANCE WITH THE CURRENT
- STANDARDS AND SPECIFICATIONS OF THE CHARTER TOWNSHIP OF CLINTON, THE MACOMB COUNTY DEPARTMENT OF ROADS. AND THE MICHIGAN DEPARTMENT OF TRANSPORTATION STANDARD SPECIFICATIONS FOR CONSTRUCTION, CURRENT EDITION.
- CONSTRUCTION OF A NEW OR RECONSTRUCTED DRIVE APPROACH CONNECTING TO AN EXISTING STATE OR COUNTY ROADWAY SHALL BE ALLOWED ONLY AFTER AN APPROVED PERMIT HAS BEEN SECURED FROM THE AGENCY HAVING JURISDICTION OVER SAID ROADWAY
- FOR ANY WORK WITHIN THE PUBLIC RIGHT-OF-WAY, THE CONTRACTOR SHALL PAY FOR AND SECURE ALL NECESSARY PERMITS AND LIKEWISE ARRANGE FOR ALL INSPECTION. 1.0 INCH AND 2.0 INCH EXPANSION JOINTS SHOULD BE INSTALLED PER MCDOR STANDARDS
- FILL AREAS SHALL BE MACHINE COMPACTED IN UNIFORM LIFTS NOT EXCEEDING 9 INCHES THICK TO 95% OF THE MAXIMUM DENSITY DETERMINED BY THE MODIFIED PROCTOR (ASTM D1557) METHOD OF TESTING PRIOR TO PLACEMENT OF PROPOSED PAVEMENT
- 6" EDGE DRAINS WRAPPED IN GEOTEXTILE FABRIC FILTER SHALL BE INSTALLED ON BOTH SIDES OF ALL ROADWAYS. ALSO PLACE UNDERDRAINS AT ALL DRAINAGE STRUCTURES WITHIN PARKING AREAS, (SEE DETAILS 6A, 6B, 6C, 6D & 6E).
- CONSTRUCTION TRAFFIC SHALL BE MINIMIZED ON THE NEW BITUMINOUS PAVEMENT. IF CONSTRUCTION TRAFFIC IS ANTICIPATED ON THE PAVEMENT STRUCTURE, SUBJECT TO MCDOR APPROVAL, THE PLACEMENT OF THE FINAL LIFT SHALL BE DELAYED UNTIL THE MAJORITY OF THE CONSTRUCTION ACTIVITIES HAVE BEEN COMPLETED. THIS ACTION WILL ALLOW REPAIR OF LOCALIZED FAILURE, IF ANY DOES OCCUR, AS WELL AS REDUCE LOAD DAMAGE ON THE PAVEMENT SYSTEM. THIS RECOMMENDATION MAY REDUCE FUTURE MAINTENANCE COSTS DUE TO LOCALIZED PREMATURE PAVEMENT FAILURES.

CONCRETE PAVEMENT

- CONCRETE SHALL CONSIST OF PORTLAND CEMENT TYPE IA (AIR-ENTRAINED) WITH A MINIMUM CEMENT CONTENT OF SIX SACKS PER CUBIC YARD, MINIMUM 28 DAY COMPRESSIVE STRENGTH OF 3500 PSI AND A SLUMP OF 1 1/2 TO 3 INCHES. PAVEMENT SHALL CONFORM TO MDOT GRADE P
- ALL CONCRETE PAVEMENT, DRIVEWAYS, CURB & GUTTER, ETC., SHALL BE SPRAY CURED WITH WHITE MEMBRANE CURING COMPOUND IMMEDIATELY FOLLOWING FINISHING OPERATION.
- THE CONCRETE BATCH PLANT SHALL BE MDOT CERTIFIED WITH LOCATION APPROVED BY THE TOWNSHIP BOARD. NO CONCRETE PAVING SHALL BE ALLOWED PRIOR TO MAY 1, OR AFTER NOVEMBER 1 (UNLESS APPROVED BY MDOT, MCDOR OR CLINTON TOWNSHIP).
- AIR TEMPERATURE AT POINT OF PLACEMENT, AWAY FROM ARTIFICIAL HEAT SHALL BE MINIMUM 40° F AND RISING
- TEMPERATURE OF CONCRETE AT TIME OF PLACEMENT SHALL BE BETWEEN 45° F AND 90° F BITUMINOUS PAVEMEN
- BITUMINOUS MIXTURE SHALL CONSIST OF:
- BASE COURSE MDOT BITUMINOUS MIXTURE NO. 2C; LEVELING COURSE - MOOT BITUMINOUS MIXTURE NO. 3C;
- WEARING COURSE MDOT BITUMINOUS MIXTURE NO. 1300T OR 13A; ASPHALT CEMENT PENETRATION GRADE 85-100 (PG 64-22)
- FOR RESIDENTIAL DEVELOPMENTS, COMMERCIAL PARKING LOTS, AND BIKE PATHS MDOT BITUMINOUS MIXTURE 1100T, 1100L, AND/OR 1300L&T, 20AAA MAY BE USED, WITH APPROVAL FROM THE ENGINEER.
- ALL BITUMINOUS MATERIAL SHALL BE COMPACTED TO A DENSITY OF 97% OF THE FIELD CONTROL DENSITY AS DETERMINED BY THE MARSHALL METHOD.
- A BOND COAT OF SS-1H EMULSION IS REQUIRED BETWEEN THE BASE COURSE AND LEVELING COURSE AND BETWEEN THE LEVELING COURSE AND WEARING COURSE. THE BOND COAT SHALL BE APPLIED IN A UNIFORM MANNER OVER THE SURFACE AT A RATE OF 0.10 GALLON/S.Y. (BETWEEN LEVELING COURSE AND BASE COURSE & 0.05 GALLON/SY BETWEEN WEARING COURSE AND LEVELING COURSE).
- SIDEWALK STANDARD NOTES SIDEWALK RAMPS, CONFORMING TO MOST CURRENT ADA STANDARDS, SHALL BE INSTALLED
- AS SHOWN ON THE PLAN AT ALL STREET INTERSECTIONS AND AT ALL BARRIER FREE PARKING AREAS AS INDICATED ON THE PLANS. ALL SIDEWALKS AND SIDEWALK RAMPS NEED TO COMPLY WITH CURRENT MICHIGAN BARRIER FREE REQUIREMENTS FOR ACCESSIBILITY. SIDEWALK AND PATHWAY RAMPS ARE TO BE LOCATED AS SPECIFIED ON THE PLANS OR AS DIRECTED BY THE ENGINEER. DETAILS 9D & 9E SHOW SIDEWALK RAMP DETAILS AT PARKING
- REQUIREMENTS RAMPS SHALL BE PROVIDED AT ALL CORNERS OF AN INTERSECTION WHERE THERE IS EXISTING OR PROPOSED SIDEWALK AND CURB. RAMPS SHALL ALSO BE PROVIDED AT WALK LOCATIONS IN MID-BLOCK IN THE VICINITIES OF HOSPITALS, MEDICAL CENTERS, AND LARGE ATHLETIC FACILITIES.
- SURFACE TEXTURE OF THE RAMP SHALL BE THAT OBTAINED BY A COARSE BROOMING, TRANSVERSE TO THE SLOPE OF RAMP.
- SIDEWALK SHALL BE RAMPED WHERE THE DRIVEWAY CURB IS EXTENDED ACROSS THE WALK. CARE SHALL BE TAKEN TO ASSURE A UNIFORM GRADE ON THE RAMP, FREE OF SAGS AN SHORT GRADE CHANGES. WHERE CONDITIONS PERMIT, IT IS DESIRABLE THAT THE SLOPE OF THE RAMP BE IN ONLY ONE DIRECTION, PARALLEL TO THE DIRECTION OF TRAVEL.
- RAMP WIDTH SHALL BE INCREASED, IF NECESSARY, TO ACCOMMODATE SIDEWALK SNOW REMOVAL EQUIPMENT NORMALLY USED BY THE TOWNSHIP. IF POSSIBLE, DRAINAGE STRUCTURES SHOULD NOT BE PLACED IN LINE WITH RAMPS, EXCEPT
- WHERE EXISTING DRAINAGE STRUCTURES ARE BEING UTILIZED IN THE NEW CONSTRUCTION. LOCATION OF THE RAMP SHOULD TAKE PRECEDENCE OVER LOCATION OF DRAINAGE STRUCTURE.
- THE NORMAL GUTTER LINE PROFILE SHALL TRANSITION TO 2% MAXIMUM SLOPE MAINTAINED THROUGH THE AREA OF THE RAMP THE TOP OF THE JOINT FILLER FOR ALL RAMP TYPES SHALL BE FLUSH WITH THE ADJACENT CONCRETE.
- CROSSWALK AND STOP LINE MARKINGS, IF USED, SHALL BE SO LOCATED AS TO STOP TRAFFIC SHORT OF RAMP CROSSINGS. SPECIFIC DETAILS FOR MARKING APPLICATIONS ARE GIVEN IN THE "MICHIGAN MANUAL OF UNIFORM TRAFFIC CONTROL DEVICES".
- DETAILS 8A, 9A AND 9B SHOW THICKENED CROSS SECTION AT DRIVEWAYS, TYPICAL SIDEWALK JOINT LAYOUTS AND CROSS SECTION.
- DETECTABLE WARNING SHALL EXTEND THE FULL WIDTH OF THE CURB RAMP. THEY SHALL BI LOCATED SO THAT THE EDGE OF THE DETECTABLE WARNING IS AT THE BACK OF CURB LINE. THICKNESS OF SIDEWALK SHALL BE INCREASED TO 6" AT DRIVEWAYS FOR RESIDENTIAL
- SIDEWALK JOINTS NOTES
- CONSTRUCT TRANSVERSE AND LONGITUDINAL EXPANSION AND PLANE OF WEAKNESS JOINTS AT INTERVALS AND LOCATIONS SHOWN ON THE PLANS. ALIGN TRANSVERSE JOINTS WITH LIKE JOINTS IN ANY ADJACENT SLAB.
- CONSTRUCT JOINTS WITH FACES PERPENDICULAR TO THE SIDEWALK SURFACE. PLACE CONTRACTION JOINTS AT 5' MINIMUM AND 7' MAXIMUM INTERVALS. SAW CUT JOINTS AFTER BROOM FINISHING. JOINTS ARE TO BE FULL WIDTH OF THE WALK AND MINIMUM 1/4 SLAB THICKNESS DEEP AND 1/8 INCH TO 1/4 INCH WIDE. DO NOT SEAL THE JOINTS.
- PLACE 1/2" FIBER EXPANSION JOINT FILLERS AT MAX. 50' INTERVALS. EXTEND EXPANSIÓN JOINT FILLER THE FULL DEPTH OF THE JOINT WITH THE TOP SLIGHTLY BELOW THE FINISHED SURFACE OF THE SIDEWALK. PLACE 1/2" FIBER EXPANSION JOINT FILLERS AT EACH SIDE OF DRIVE.
- PROVIDE 1" FIBER EXPANSION JOINT FILLERS AT BACK OF CURB AND BUILDING OR R.O.W. LINE. SEAL EXPANSION JOINTS WITH HOT-POURED RUBBER-ASPHALT SEALANT. Scale:

T-2-N R-13-E 72 HOURS (3 WORKING DAYS) FORF YOU DI CALL MISS 0–482–7 (TOLL FREE) DATE: ISSUE: 09.10.2018 DETAIL SHEET REVISIONS

Charter

Township

of Clinton

Developed For: CHARTER TOWNSHIP OF CLINTON 40700 ROMEO PLANK ROAD CLINTON TOWNSHIP, MI 48038

(586) 286-8000

CHARTER TOWNSHIP OF CLINTON

PAVING (1 OF 2) STANDARD DETAILS


CHARTER TOWNSHIP OF CLINTON MACOMB COUNTY MICHIGAN


> 07.24.2015 N.T.S. P-1


Date:

Sheet:

Project:

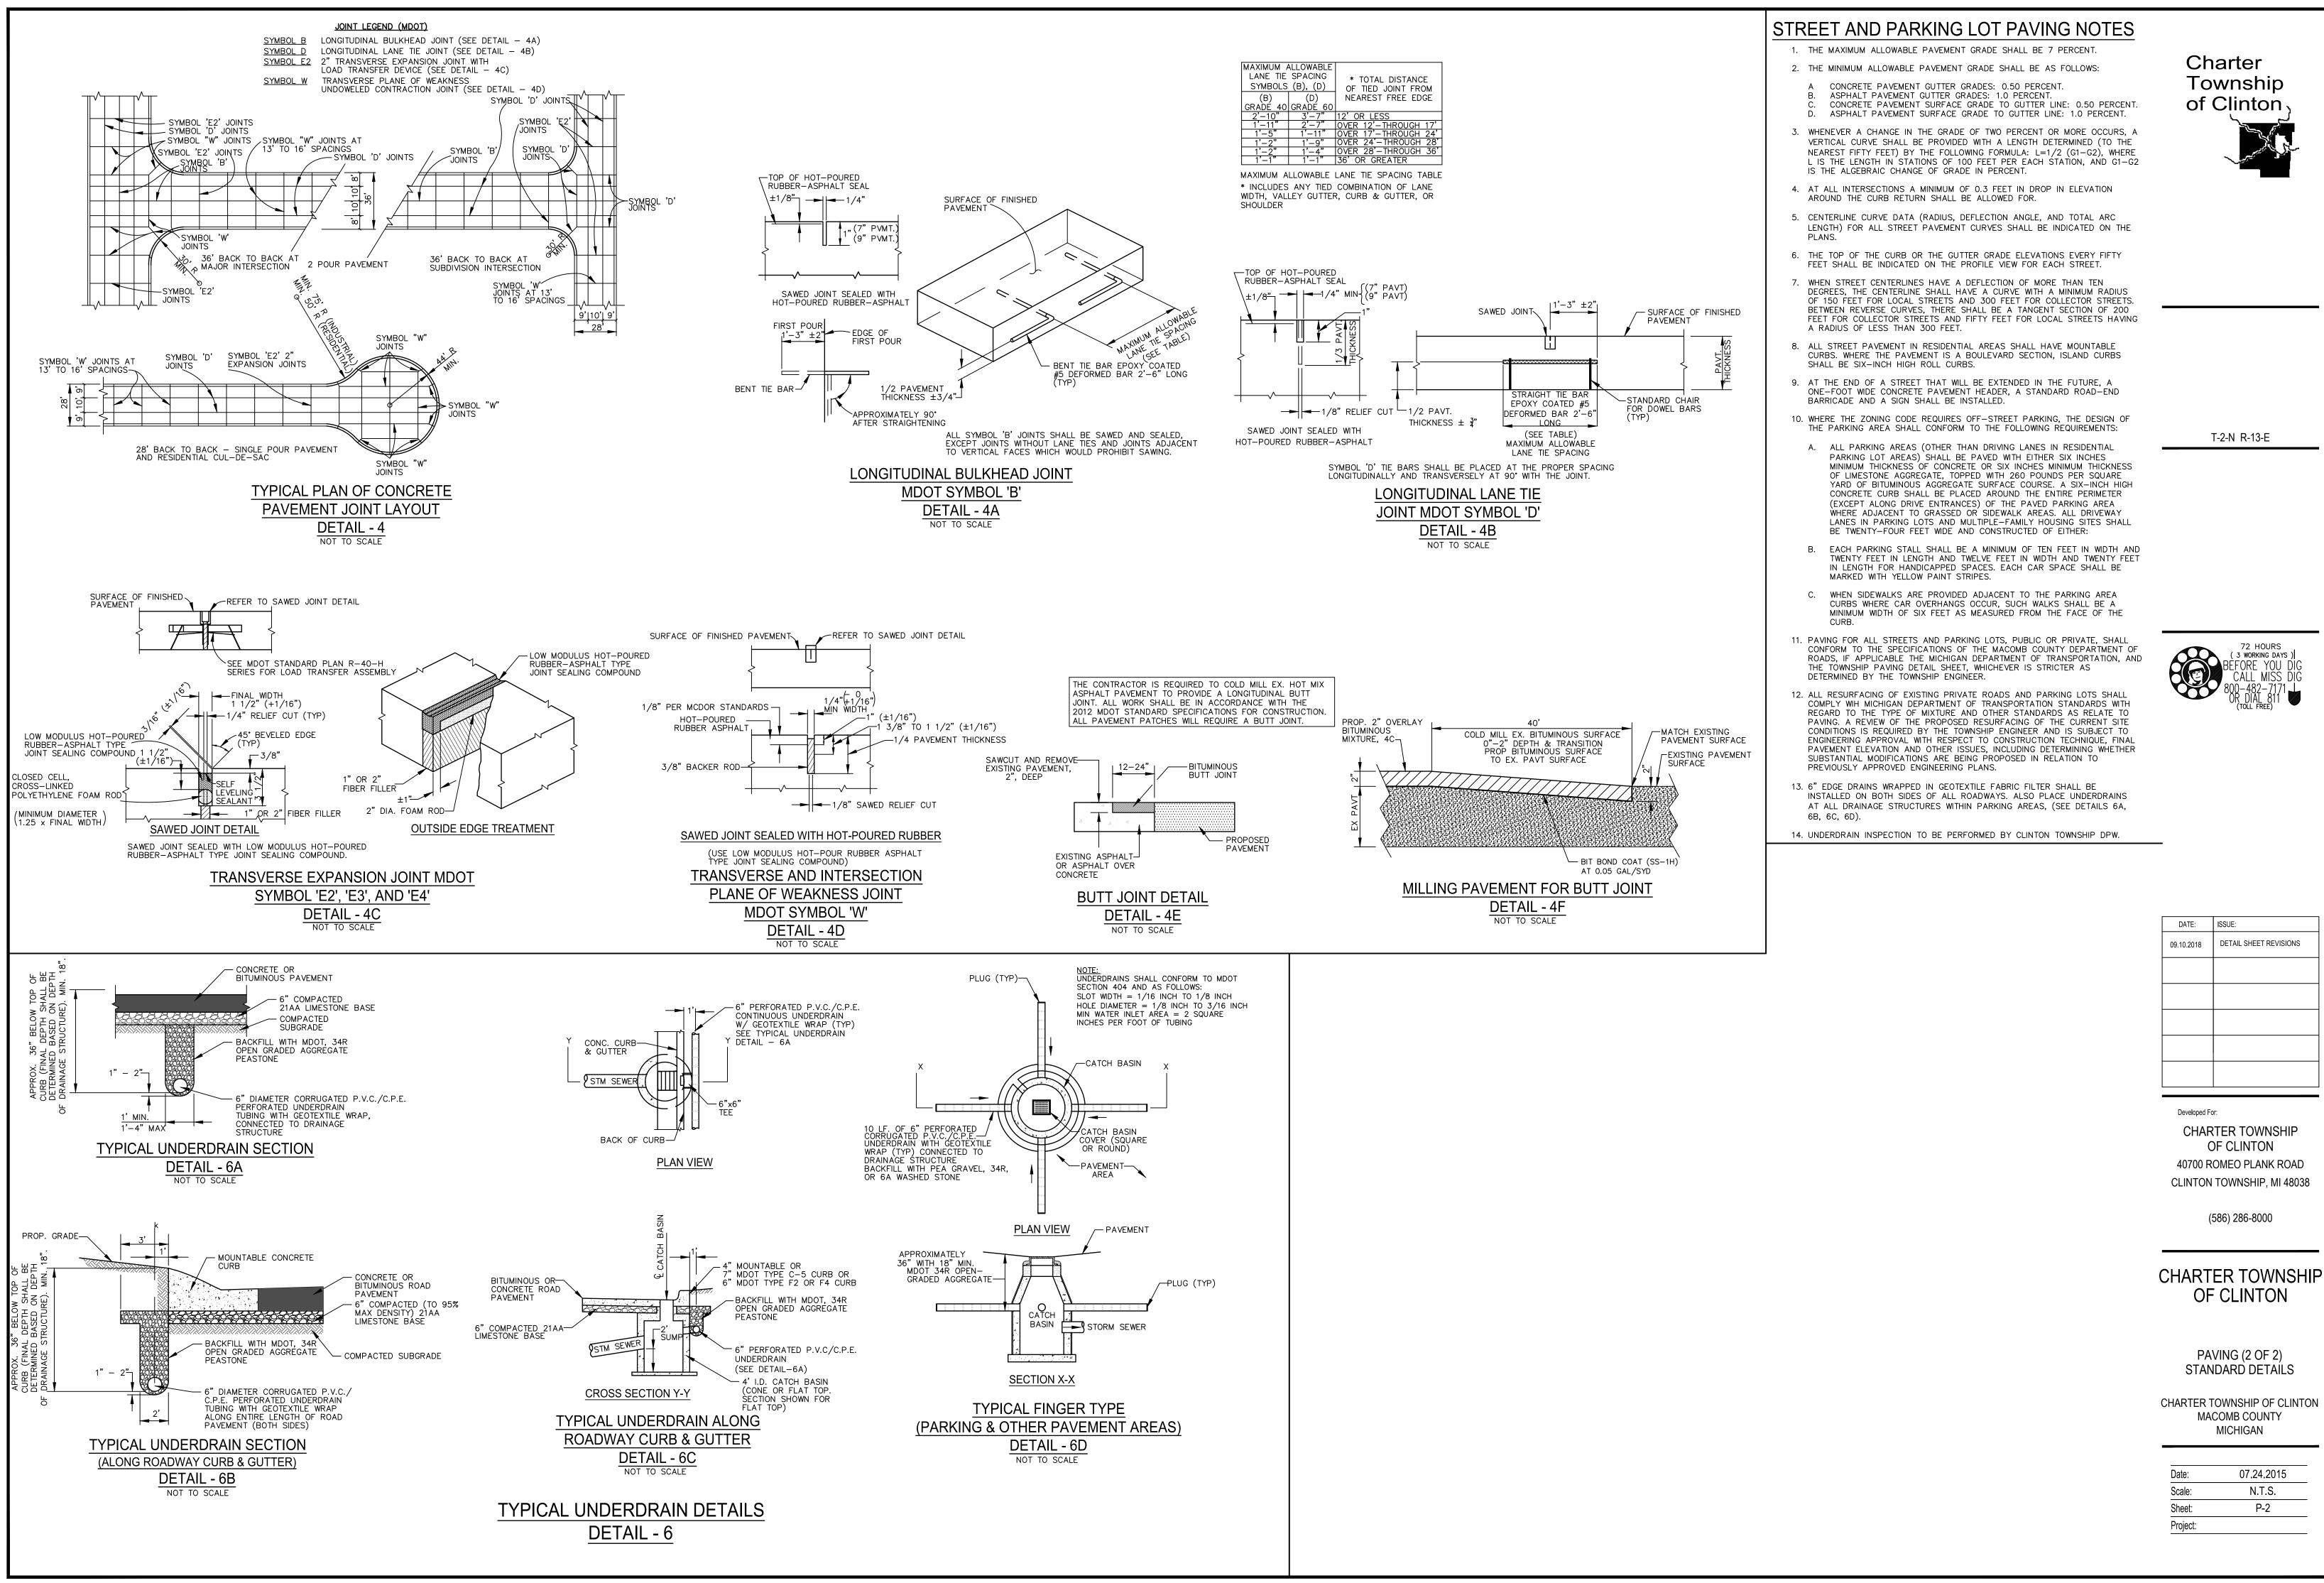

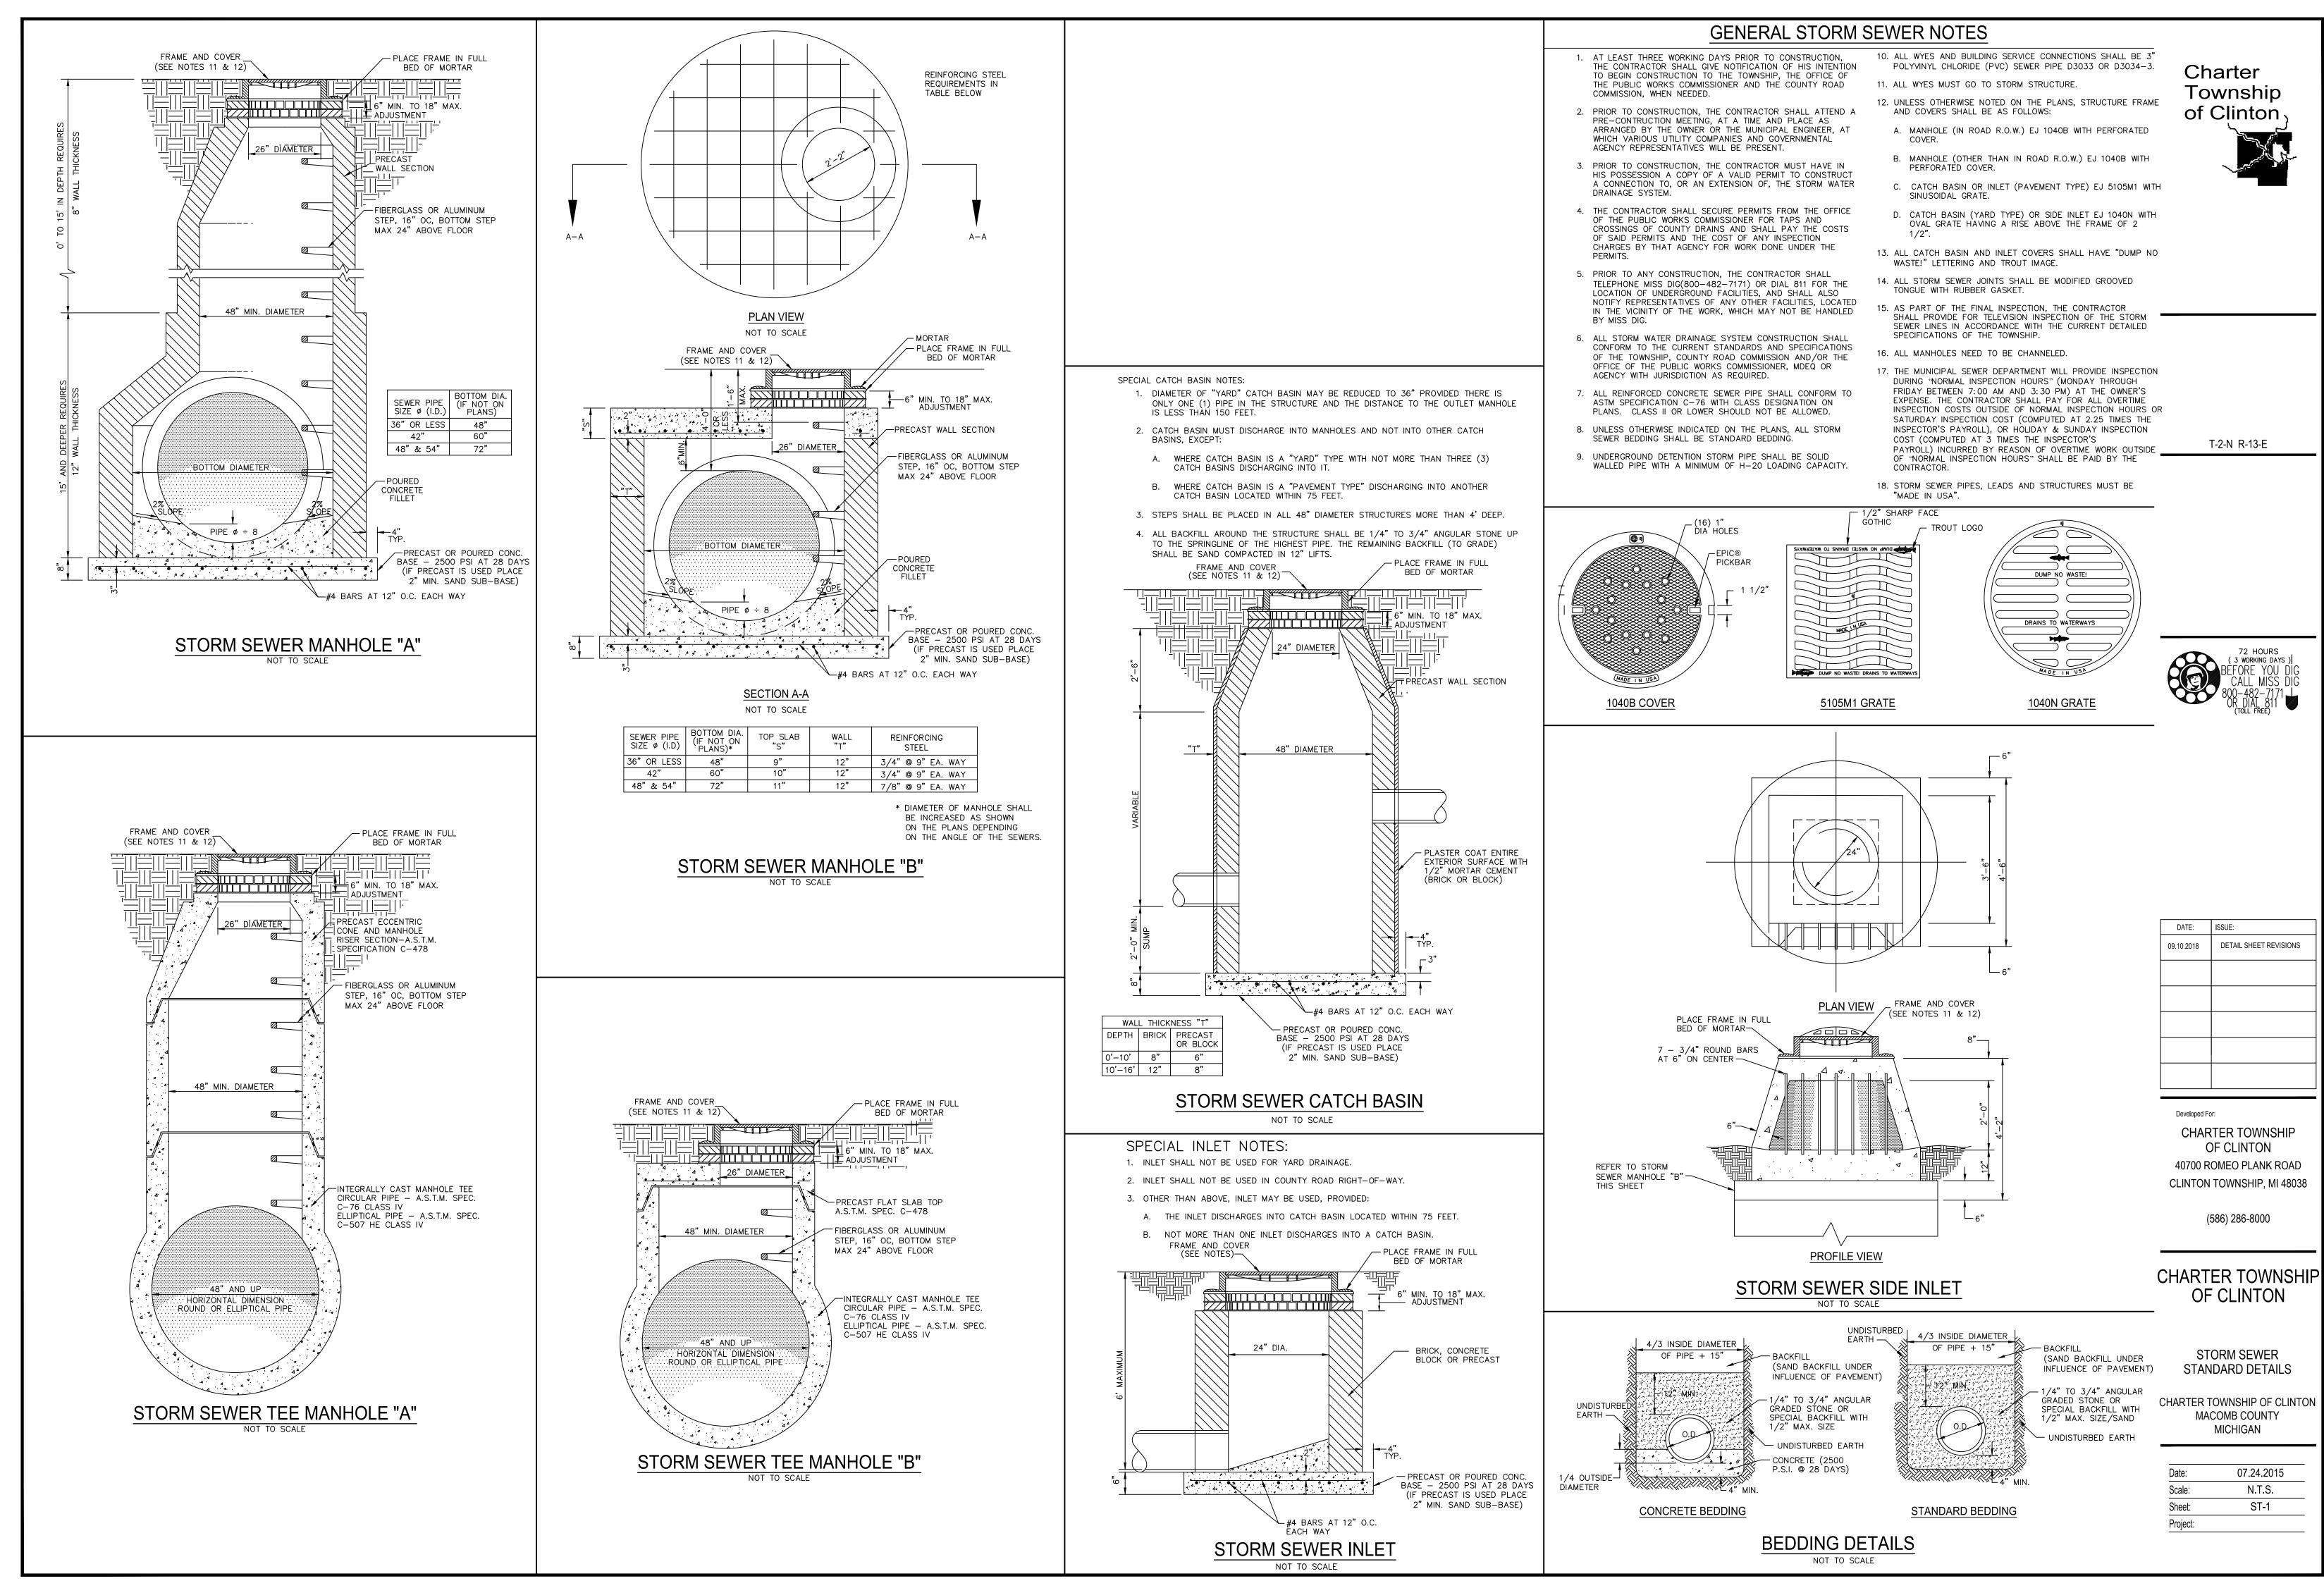

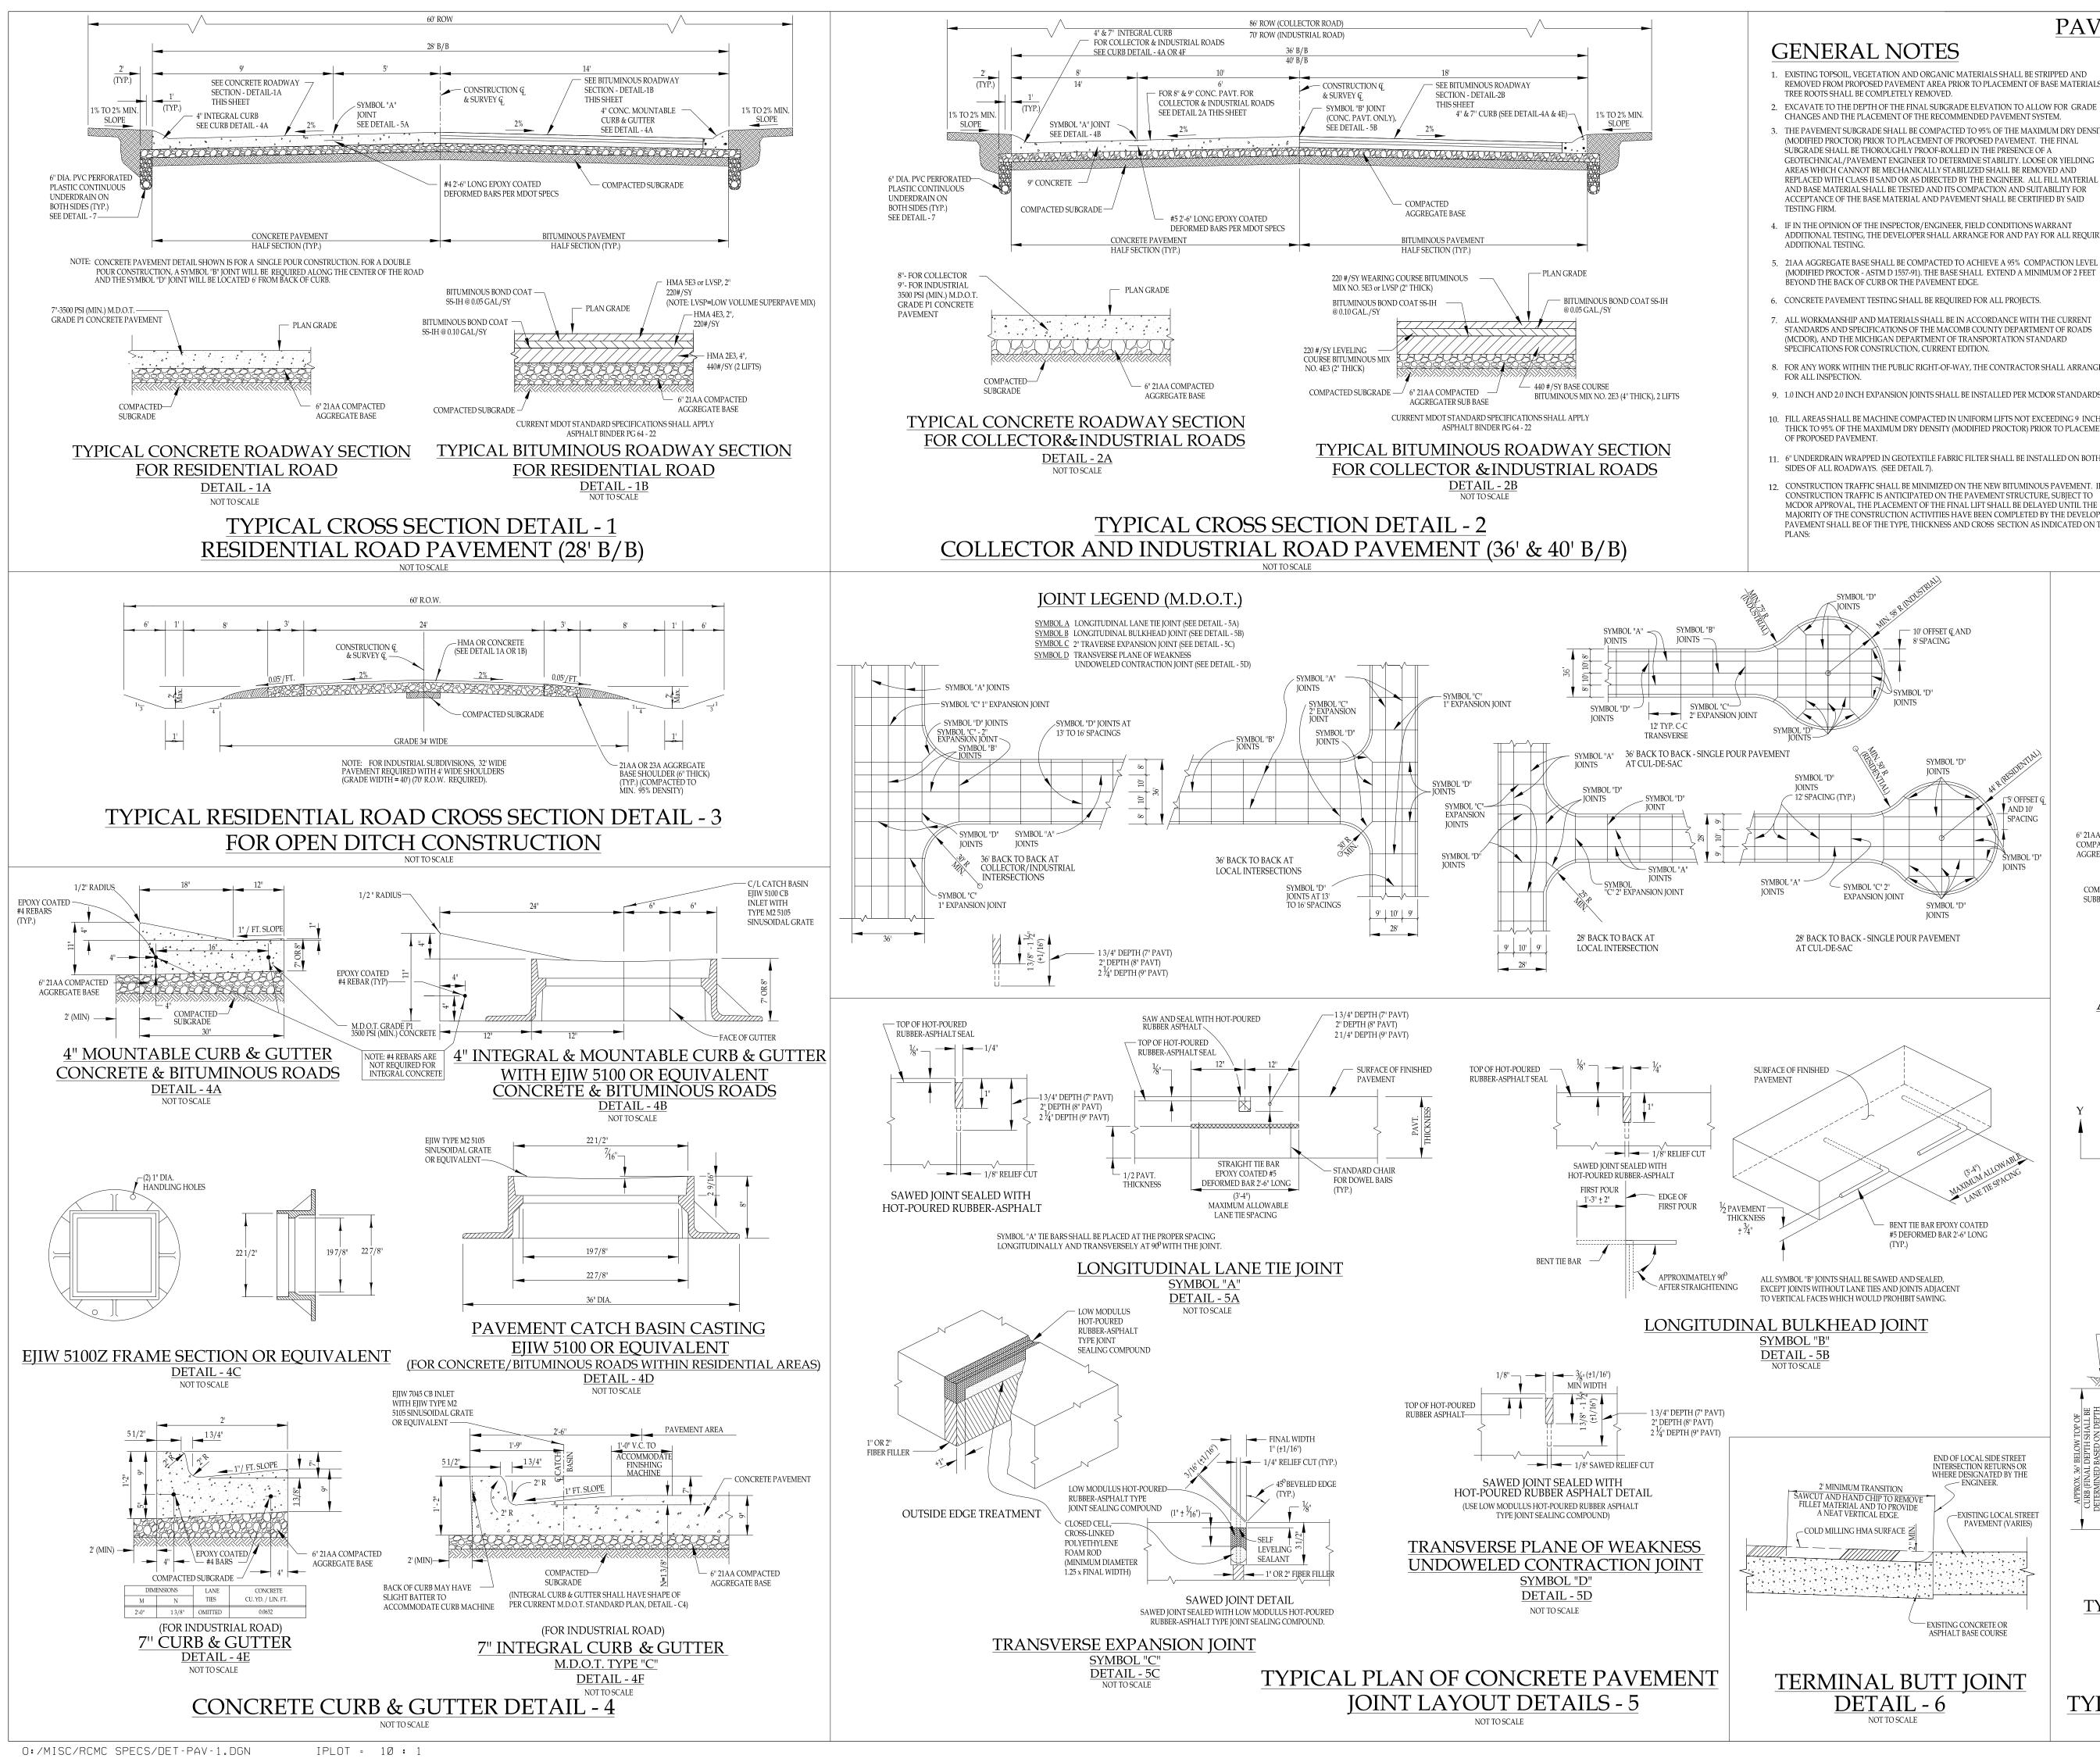

DET-PAV-1.dgn 04/03/2018 2:53:04 PM

PAVING NOTES

. EXISTING TOPSOIL, VEGETATION AND ORGANIC MATERIALS SHALL BE STRIPPED AND REMOVED FROM PROPOSED PAVEMENT AREA PRIOR TO PLACEMENT OF BASE MATERIALS.

- EXCAVATE TO THE DEPTH OF THE FINAL SUBGRADE ELEVATION TO ALLOW FOR GRADE THE PAVEMENT SUBGRADE SHALL BE COMPACTED TO 95% OF THE MAXIMUM DRY DENSITY (MODIFIED PROCTOR) PRIOR TO PLACEMENT OF PROPOSED PAVEMENT. THE FINAL GEOTECHNICAL/PAVEMENT ENGINEER TO DETERMINE STABILITY, LOOSE OR YIELDING AREAS WHICH CANNOT BE MECHANICALLY STABILIZED SHALL BE REMOVED AND REPLACED WITH CLASS II SAND OR AS DIRECTED BY THE ENGINEER. ALL FILL MATERIAL AND BASE MATERIAL SHALL BE TESTED AND ITS COMPACTION AND SUITABILITY FOR
- ADDITIONAL TESTING. THE DEVELOPER SHALL ARRANGE FOR AND PAY FOR ALL REQUIRED
- 5. 21AA AGGREGATE BASE SHALL BE COMPACTED TO ACHIEVE A 95% COMPACTION LEVEL (MODIFIED PROCTOR - ASTM D 1557-91). THE BASE SHALL EXTEND A MINIMUM OF 2 FEET
- 7 ALL WORKMANSHIP AND MATERIALS SHALL BE IN ACCORDANCE WITH THE CURRENT STANDARDS AND SPECIFICATIONS OF THE MACOMB COUNTY DEPARTMENT OF ROADS
- (MCDOR), AND THE MICHIGAN DEPARTMENT OF TRANSPORTATION STANDARD 8. FOR ANY WORK WITHIN THE PUBLIC RIGHT-OF-WAY, THE CONTRACTOR SHALL ARRANGE
- 9 1.0 INCH AND 2.0 INCH EXPANSION JOINTS SHALL BE INSTALLED PER MCDOR STANDARDS
- 10. FILL AREAS SHALL BE MACHINE COMPACTED IN UNIFORM LIFTS NOT EXCEEDING 9 INCHES THICK TO 95% OF THE MAXIMUM DRY DENSITY (MODIFIED PROCTOR) PRIOR TO PLACEMENT
- CONSTRUCTION TRAFFIC SHALL BE MINIMIZED ON THE NEW BITUMINOUS PAVEMENT. II CONSTRUCTION TRAFFIC IS ANTICIPATED ON THE PAVEMENT STRUCTURE, SUBJECT TO MCDOR APPROVAL, THE PLACEMENT OF THE FINAL LIFT SHALL BE DELAYED UNTIL THE MAJORITY OF THE CONSTRUCTION ACTIVITIES HAVE BEEN COMPLETED BY THE DEVELOPER PAVEMENT SHALL BE OF THE TYPE, THICKNESS AND CROSS SECTION AS INDICATED ON THE

- CONCRETE PAVEMENT CONCRETE SHALL CONSIST OF PORTLAND CEMENT TYPE IA (AIR-ENTRAINED) WITH A MINIMUM CEMENT CONTENT OF SI
- SACKS PER CUBIC YARD, MINIMUM 28 DAY COMPRESSIVE STRENGTH OF 3500 PSI AND A SLUMP OF 1 1/2 TO 3 INCHES. PAVEMENT SHALL CONFORM TO M.D.O.T. GRADE P1.
- ALL CONCRETE PAVEMENT, DRIVEWAYS, CURB & GUTTER, ETC., SHALL BE SPRAY CURED WITH WHITE MEMBRANE CURING COMPOUND IMMEDIATELY FOLLOWING FINISHING OPERATION
- . THE CONCRETE BATCH PLANT SHALL BE M.D.O.T. CERTIFIED WITH LOCATION APPROVED B THE MACOMB COUNTY DEPARTMENT OF ROADS.
- 4 NO CONCRETE PAVING SHALL BE ALLOWED PRIOR TO MAY 1. OR AFTER NOVEMBER 1 (UNLESS APPROVED BY THE MACOMB COUNTY DEPARTMENT OF ROADS).
- 5. AIR TEMPERATURE AT POINT OF PLACEMENT, AWAY FROM ARTIFICIAL HEAT SHALL BE MINIMUM 25°F AND RISINC
- 5 TEMPERATURE OF CONCRETE AT TIME OF PLACEMENT SHALL BE BETWEEN 45°F AND 90°F CONCRETE PAVING MIXTURES SHALL MEET ALL PROVISIONS OF SECTION 601 OF THE MICHIGAN DEPARTMENT OF TRANSPORTATION 2012 STANDARD SPECIFICATIONS FOR ONSTRUCTION AND FOR THE COARSE AGGREGATE 6AA: SECTION 902. OBTAIN THE COARSE AGGREGATE FOR CONCRETE MIXTURES FROM NATURAL AGGREGATE SOURCES. THE ABSORBTION DETERMINED IN ACCORDANCE WITH ASTM C 127 SHALL NOT EXCEED 2.5%

ITUMINOUS PAVEMEN BITUMINOUS MIXTURE SHALL CONSIST OF BASE COURSE - MOOT BITUMINOUS MIXTURE NO

2E3; LEVELING COURSE - MDOT BITUMINOUS MIXTURE NO. 4E3; WEARING COURSE - MDOT BITUMINOUS MIXTURE NO. 5E3 or LVSP; ASPHALT CEMENT PERFORMANCE GRADE 85-100 (PG 64-22)

AIL

ET

 \Box

ANDARD

ST

VING

ΡA

 ∞

REVISED MARCH 201

- 2. ALL BITUMINOUS MATERIAL SHALL BE COMPACTED TO A DENSITY OF 97% OF THE FIELD CONTROL DENSITY AS DETERMINED BY THE MARSHALL METHOD A BOND COAT OF SS-1H EMULSION IS REOUIRED BETWEEN THE BASE COURSE AND LEVELING COURSE AND BETWEEN THE LEVELING COURSE AND WEARING COURSE WHEN EITHER 48 HOURS HAVE ELAPSED BETWEEN PLACEMENT OF THE BITUMINOUS COURSES OR THE SURFACE OF THE PAVEMENT HAS BEEN CONTAMINATED WITH DIRT. DUST, OR FOREIGN MATERIAL. THE BOND COAT SHALL BE APPLIED IN A UNIFORM MANNER OVER THE SURFACE AT A RATE OF 0.10 GALLON/S.Y. (BETWEEN LEVELING COURSE AND BASE COURS & 0.05 GALLON/SY (BETWEEN WEARING COURSE AND LEVELING COURSE) THE COATS MAY DIFFER. IN THE EVENT A BOND COAT IS NOT REOUIRED, THE LEVELING COURSE MAY REOUIRE LOCALIZED BROOM CLEANING
- 4. UNLESS OTHERWISE APPROVED BY THE DIRECTOR OF ROADS, TEMPERATURE AND SEASONAL REQUIREMENTS FOR PLACING HMA WILL BE ACCORDING TO CURRENT MOOT STANDARD SPECIFICATIONS FOR CONSTRUCTION. TARGET PLACEMENT TEMPERATURES FOR CONSTRUCTION. THE MCDOR WILL NOT ALLOW PAVING BELOW THESE MINIMUM TEMPERATURES. NOR WHEN FROST IS ON OR IN THE GRADE OR
- ON THE EXISTING SURFACE 5. PLACEMENT OF HMA OR APPLICATION OF BOND COAT IS PROHIBITED WHEN PRECIPITATION IS IMMINENT OR WHEN MOISTURE ON THE EXISTING SURFACE WILL PREVENT SATISFACTORY CURING. 5. RECYCLED HOT MIX ASPHALT MIXTURE: LIMITS RECYCLED ASPHALT MATERIAL (RAP) TO A
- MAXIMUM OF 15% BINDER BY WEIGHT OF THE TOTAL BINDER IN THE MIXTURE. ASPHALT SHINGLES AND TIRES ARE NOT ALLOWED.


UNDERDRAIN NOTES

2. UNDERDRAIN TO BE 6" PVC AASHTO M 278 MEETING ASTM D 2751, SDR-35 WITH

1. UNDERDRAIN SHALL BE PLACED ALONG THE ENTIRE LENGTH OF CURB

PERFORATIONS MEETING AASHTO M 278. 3. PIPE SHALL BE WRAPPED IN GEOTEXTILE FABRIC AND INSTALLED WITH THE PERFORATIONS FACING DOWNWARI 4. PROPOSED UNDERDRAIN PIPE LAYOUT, FLOW LINE ELEVATION AND DETAILS SHALL BE APPROVED PRIOR TO CONSTRUCTION. CONCRETE CURB & GUTTER - COMPACTED FILL - MDOT 34R OPEN-GRADED PAVEMENT AGGREGATE (PEA STONE) AS INDICATED ON PLANS SPACIN 6" DIAMETER CORRUGATED 20303030 P.V.C. PERFORATED 6" 21AA 6" 21AA -COMPACTED UNDERDRAIN WITH LIMESTONE AGGREGATE BASE ้รับMBOL "7 GEOTEXTILE WRAP ALONG ENTIRE LENGTH OF CURB (BOTH SIDES) COMPACTED-6" PVC UNDERDRAIN W/GEOTEXTILE WRAP (CONNECT TO MANHOLE) SUBBASE - COMPACTED SUBBASE CROSS SECTION Y-Y UNDERDRAIN WITH CATCH BASIN ALONG ROADWAY CURB&GUTTER (TYP.) <u>DETAIL - 7A</u> NOT TO SCALE 6" PERFORATED P.V.C. CONTINUOUS UNDERDRAIN WITH GEOTEXTILE WRAP (TYP.) SEE TYPICAL UNDER DRAIN DETAIL - 7C CONC. CURB & GUTTER STORM SEWER

(BOTH SIDES).

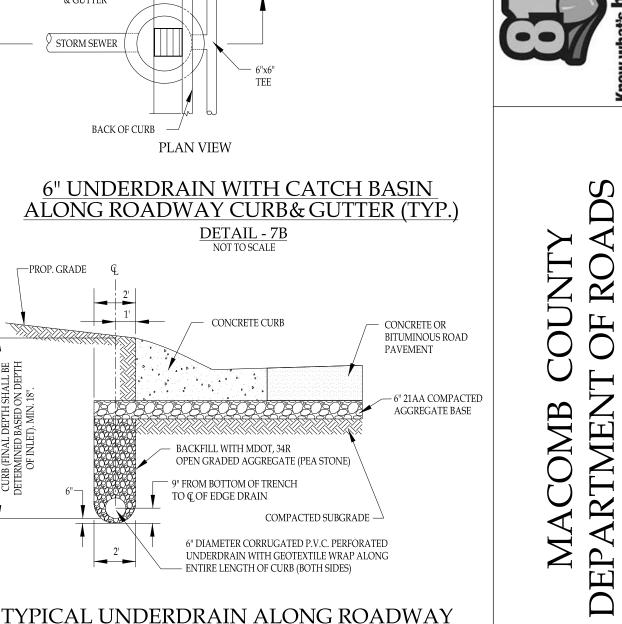



TYPICAL UNDERDRAIN DETAILS - 7

NOT TO SCALE

